# CONCEPTUAL ENGINEERING DRAWINGS

# CALIFORNIA HIGH-SPEED RAIL PROJECT

Design-Build Contract for CONSTRUCTION PACKAGE 4

Proposal | RFP Number: HSR 14-32










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### LEGEND



PROPOSED HST RIGHT OF WAY

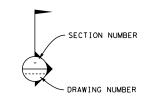PROPOSED HST TRACK CENTERLINE

TOE OF SLOPE / TOP OF CUT

LINE DATA

CURVE DATA

REMOVE BASE & SURFACING

- PRELIMINARY, SUBJECT TO CHANGE DURING DETAIL DESIGN.

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REV	DATE	BY	СНК	APP	DESCRIPTION	52	ı

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# CALIFORNIA HIGH-SPEED TRAIN PROJECT FRESNO TO BAKERSFIELD

INDEX OF DRAWINGS

CONTRACT NO.
DRAWING NO.
2.00
SCALE
NO SCALE
SHEET NO.
1 OF 1

# PLAN AND PROFILE



### INDEX - PLAN AND PROFILE - HIGH-SPEED RAIL TRACK

DRAWING No.	REV No.	DRAWING DESCRIPTION	SHEET No
2.01.01_01		ALLENSWORTH BYPASS SUBSECTION - ALIGNMENT A1 - STA. 4435+50 TO 4463+00 - PLAN AND PROFILE	1 OF 40
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2.01.01_03		ALLENSWORTH BYPASS SUBSECTION - ALIGNMENT A1 - STA. 4491+00 TO 4519+00 - PLAN AND PROFILE	3 OF 40
2.01.01_04		ALLENSWORTH BYPASS SUBSECTION - ALIGNMENT A1 - STA. 4519+00 TO 4547+00 - PLAN AND PROFILE	4 OF 40
2.01.01_05		ALLENSWORTH BYPASS SUBSECTION - ALIGNMENT A1 - STA. 4547+00 TO 4575+00 - PLAN AND PROFILE	5 OF 40
2.01.01_06		ALLENSWORTH BYPASS SUBSECTION - ALIGNMENT A1 - STA. 4575+00 TO 4603+00 - PLAN AND PROFILE	6 OF 40
2.01.01_07		ALLENSWORTH BYPASS SUBSECTION - ALIGNMENT A1 - STA. 4603+00 TO 4631+00 - PLAN AND PROFILE	7 OF 40
2.01.01_08		ALLENSWORTH BYPASS SUBSECTION - ALIGNMENT A1 - STA. 4631+00 TO 4659+00 - PLAN AND PROFILE	8 OF 40
2.01.01_09		ALLENSWORTH BYPASS SUBSECTION - ALIGNMENT A1 - STA. 4659+00 TO 4687+00 - PLAN AND PROFILE	9 OF 40
2.01.01_10		ALLENSWORTH BYPASS SUBSECTION - ALIGNMENT A1 - STA. 4687+00 TO 4715+00 - PLAN AND PROFILE	10 OF 40
2.01.01_11		ALLENSWORTH BYPASS SUBSECTION - ALIGNMENT A1 - STA. 4715+00 TO 4743+00 - PLAN AND PROFILE	11 OF 40
2.01.01_12		ALLENSWORTH BYPASS SUBSECTION - ALIGNMENT A1 - STA. 4743+00 TO 4771+00 - PLAN AND PROFILE	12 OF 40
2.01.01_13		ALLENSWORTH BYPASS SUBSECTION - ALIGNMENT A1 - STA. 4771+00 TO 4799+00 - PLAN AND PROFILE	13 OF 40
2.01.01_14		ALLENSWORTH BYPASS SUBSECTION - ALIGNMENT A1 - STA. 4799+00 TO 4827+00 - PLAN AND PROFILE	14 OF 40
2.01.01_15		ALLENSWORTH BYPASS SUBSECTION - ALIGNMENT A1 - STA. 4827+00 TO 4855+00 - PLAN AND PROFILE	15 OF 40
2.01.01_16		ALLENSWORTH BYPASS SUBSECTION - ALIGNMENT A1 - STA. 4855+00 TO 4883+00 - PLAN AND PROFILE	16 OF 40
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2.01.01_18		ALLENSWORTH BYPASS SUBSECTION - ALIGNMENT A1 - STA. 4911+00 TO 4925+33.36  POSO CREEK SUBSECTION - ALIGNMENT L1 - STA. 5154+50 TO 5168+00 - PLAN AND PROFILE	18 OF 40
2.01.01_19		POSO CREEK SUBSECTION - ALIGNMENT L1 - STA. 5168+00 TO 5196+00 - PLAN AND PROFILE	19 OF 40
2.01.01_20		POSO CREEK SUBSECTION - ALIGNMENT L1 - STA. 5196+00 TO 5224+00 - PLAN AND PROFILE	20 OF 40
2.01.01_21		POSO CREEK SUBSECTION - ALIGNMENT L1 - STA. 5224+00 TO 5252+00 - PLAN AND PROFILE	21 OF 40
2.01.01_22		POSO CREEK SUBSECTION - ALIGNMENT L1 - STA. 5252+00 TO 5280+00 - PLAN AND PROFILE	22 OF 40
2.01.01_23		POSO CREEK SUBSECTION - ALIGNMENT L1 - STA. 5280+00 TO 5308+00 - PLAN AND PROFILE	23 OF 40
2.01.01_24		POSO CREEK SUBSECTION - ALIGNMENT L1 - STA. 5308+00 TO 5322+33.13 THROUGH WASCO SUBSECTION - ALIGNMENT WS1 - STA. 5422+50 TO 5436+00 - PLAN AND PROFILE	24 OF 40
2.01.01_25		THROUGH WASCO SUBSECTION - ALIGNMENT WS1 - STA. 5436+00 TO 5464+00 - PLAN AND PROFILE	25 OF 40
2.01.01_26		THROUGH WASCO SUBSECTION - ALIGNMENT WS1 - STA. 5464+00 TO 5492+00 - PLAN AND PROFILE	26 OF 40
2.01.01_27		THROUGH WASCO SUBSECTION - ALIGNMENT WS1 - STA. 5492+00 TO 5520+00 - PLAN AND PROFILE	27 OF 40
2.01.01_28		THROUGH WASCO SUBSECTION - ALIGNMENT WS1 - STA. 5520+00 TO 5548+00 - PLAN AND PROFILE	28 OF 40
2.01.01_29		THROUGH WASCO SUBSECTION - ALIGNMENT WS1 - STA. 5548+00 TO 5576+00 - PLAN AND PROFILE	29 OF 40
2.01.01_30		THROUGH WASCO SUBSECTION - ALIGNMENT WS1 - STA. 5576+00 TO 5604+00 - PLAN AND PROFILE	30 OF 40

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# CALIFORNIA HIGH-SPEED TRAIN PROJECT FRESNO TO BAKERSFIELD

INDEX OF DRAWINGS PLAN AND PROFILE

CONTRACT NO.
DRAWING NO. 2.01
SCALE NO SCALE

SHEET NO. 1 OF 3

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2.01.01_31		THROUGH WASCO SUBSECTION - ALIGNMENT WS1 - STA. 5604+00 TO 5632+00 - PLAN AND PROFILE	31 OF 40
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2.01.01_33		THROUGH WASCO SUBSECTION - ALIGNMENT WS1 - STA. 5660+00 TO 5688+00 - PLAN AND PROFILE	33 OF 40
2.01.01_34		THROUGH WASCO SUBSECTION - ALIGNMENT WS1 - STA. 5688+00 TO 5716+00 - PLAN AND PROFILE	34 OF 40
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2.01.01_36		THROUGH WASCO SUBSECTION - ALIGNMENT WS1 - STA. 5744+00 TO 5772+00 - PLAN AND PROFILE	36 OF 40
2.01.01_37		THROUGH WASCO SUBSECTION - ALIGNMENT WS1 - STA. 5772+00 TO 5800+00 - PLAN AND PROFILE	37 OF 40
2.01.01_38		THROUGH WASCO SUBSECTION - ALIGNMENT WS1 - STA. 5800+00 TO 5828+00 - PLAN AND PROFILE	38 OF 40
2.01.01_39		THROUGH WASCO SUBSECTION - ALIGNMENT WS1 - STA. 5828+00 TO 5856+00 - PLAN AND PROFILE	39 OF 40
2.01.01_40		THROUGH WASCO SUBSECTION - ALIGNMENT WS1 - STA. 5856+00 TO 5879+93.88 - PLAN AND PROFILE	40 OF 40

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2.01.02_06		THROUGH WASCO SUBSECTION - ALIGNMENT WS1 - GRADE SEPARATION LAYOUT - MCCOMBS AVE - PLAN	6 OF 28
2.01.02_07		THROUGH WASCO SUBSECTION - ALIGNMENT WS1 - GRADE SEPARATION LAYOUT - MCCOMBS AVE - PLAN	7 OF 28
2.01.02_08		THROUGH WASCO SUBSECTION - ALIGNMENT WS1 - GRADE SEPARATION LAYOUT - 6TH STREET - PLAN	8 OF 28
2.01.02_09		THROUGH WASCO SUBSECTION - ALIGNMENT WS1 - GRADE SEPARATION LAYOUT - POSO AVE - PLAN	9 OF 28
2.01.02_10		THROUGH WASCO SUBSECTION - ALIGNMENT WS1 - GRADE SEPARATION LAYOUT - KIMBERLINA RD - PLAN	10 OF 28
2.01.02_11		THROUGH WASCO SUBSECTION - ALIGNMENT WS1 - GRADE SEPARATION LAYOUT - MERCED AVE - PLAN	11 OF 28
2.01.02_12		THROUGH WASCO SUBSECTION - ALIGNMENT WS1 - GRADE SEPARATION LAYOUT - MERCED AVE - PLAN	12 OF 28
2.01.02_13		ALLENSWORTH BYPASS SUBSECTION - ALIGNMENT A1 - GRADE SPARATION LAYOUT - SCOFIELD AVE - PROFILE	13 OF 28
2.01.02_14		ALLENSWORTH BYPASS SUBSECTION - ALIGNMENT A1 - GRADE SPARATION LAYOUT - SCOFIELD AVE - PROFILE	14 OF 28
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2.01.02_18		THROUGH WASCO SUBSECTION - ALIGNMENT WS1 - GRADE SEPARATION LAYOUT - MCCOMBS AVE - PROFILE	18 OF 28

- PRELIMINARY, SUBJECT TO CHANGE DURING DETAIL DESIGN.

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#### CALIFORNIA HIGH-SPEED TRAIN PROJECT FRESNO TO BAKERSFIELD

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CONTRACT NO.
DRAWING NO.
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2 OF 3

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2.01.02_28		THROUGH WASCO SUBSECTION - ALIGNMENT WS1 - GRADE SEPARATION LAYOUT - MERCED AVE - PROFILE	28 OF 28

- PRELIMINARY, SUBJECT TO CHANGE DURING DETAIL DESIGN.

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# CALIFORNIA HIGH-SPEED TRAIN PROJECT FRESNO TO BAKERSFIELD


INDEX OF DRAWINGS PLAN AND PROFILE


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2.01
NO SCALE


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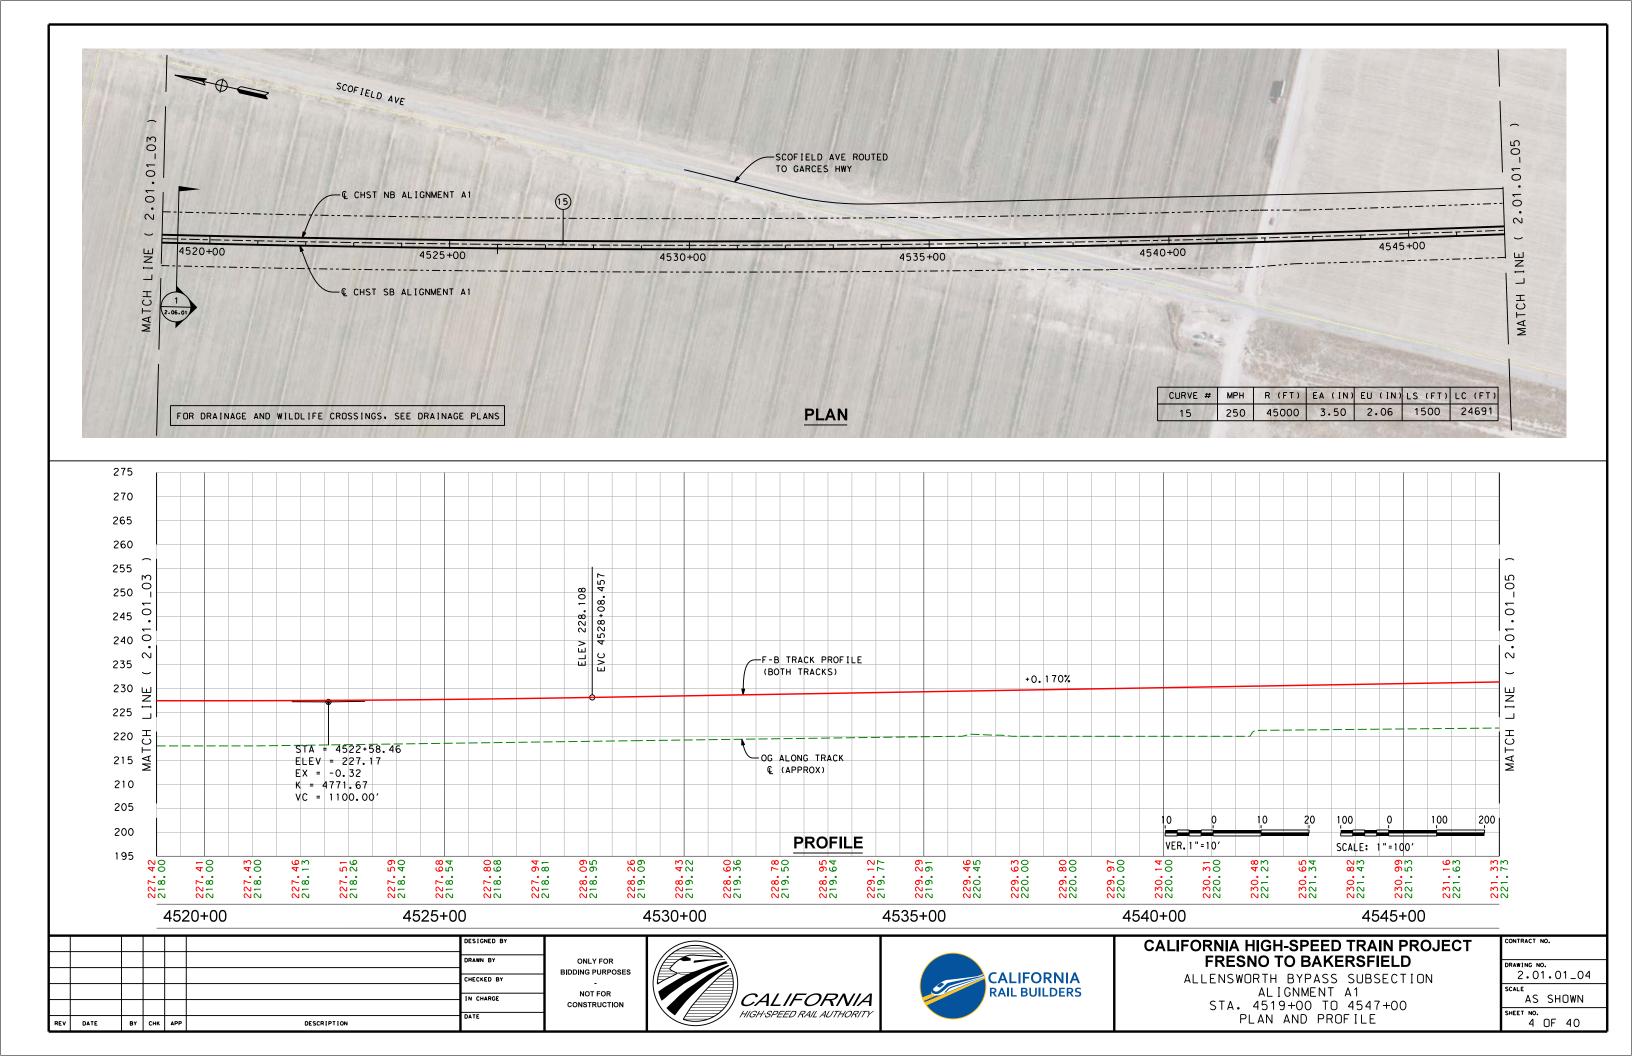
# PLAN AND PROFILE HIGH-SPEED RAIL TRACK







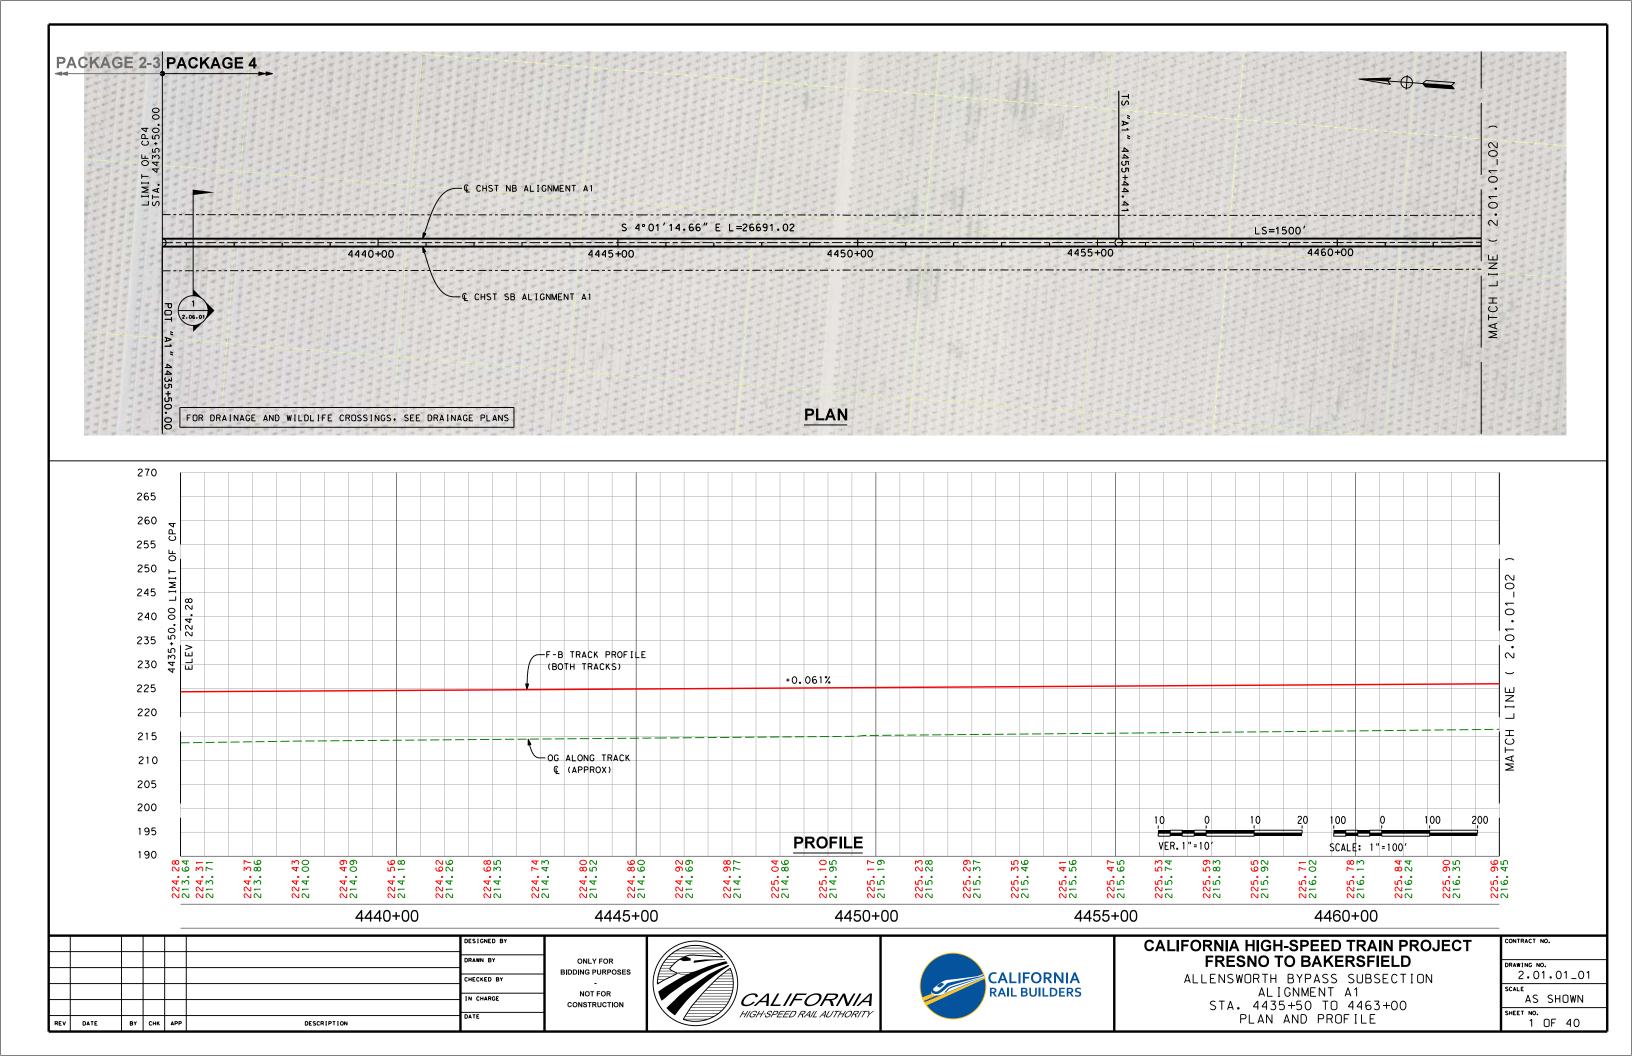


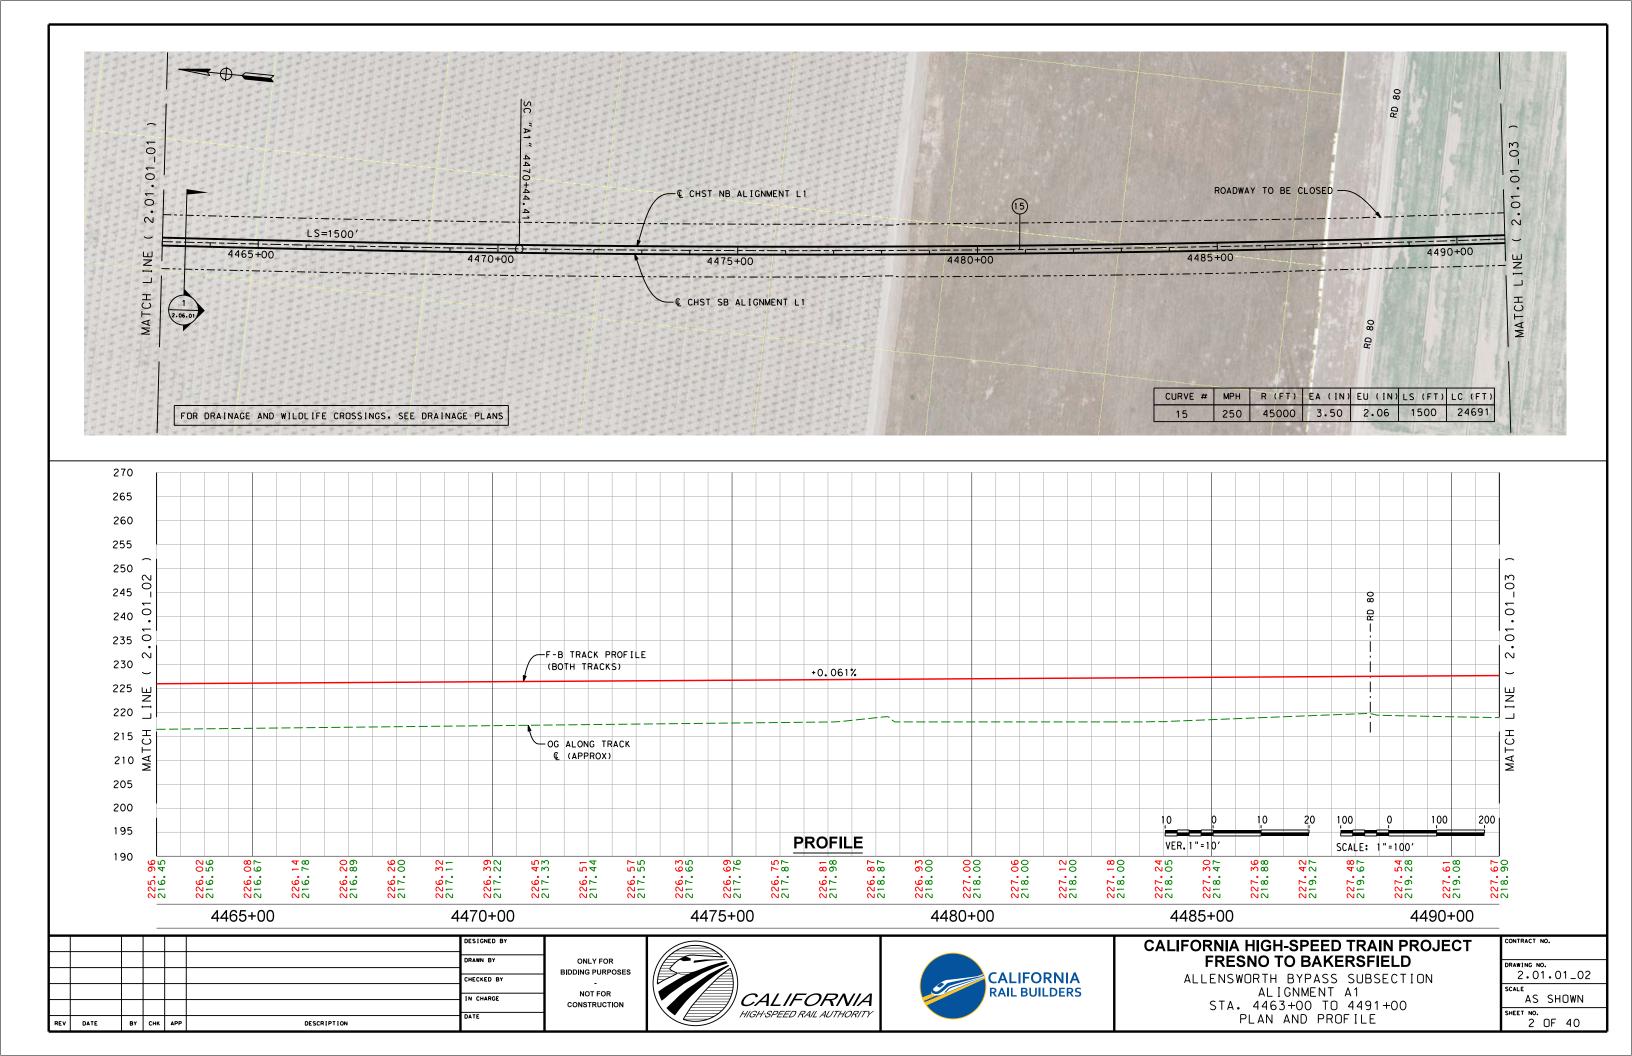


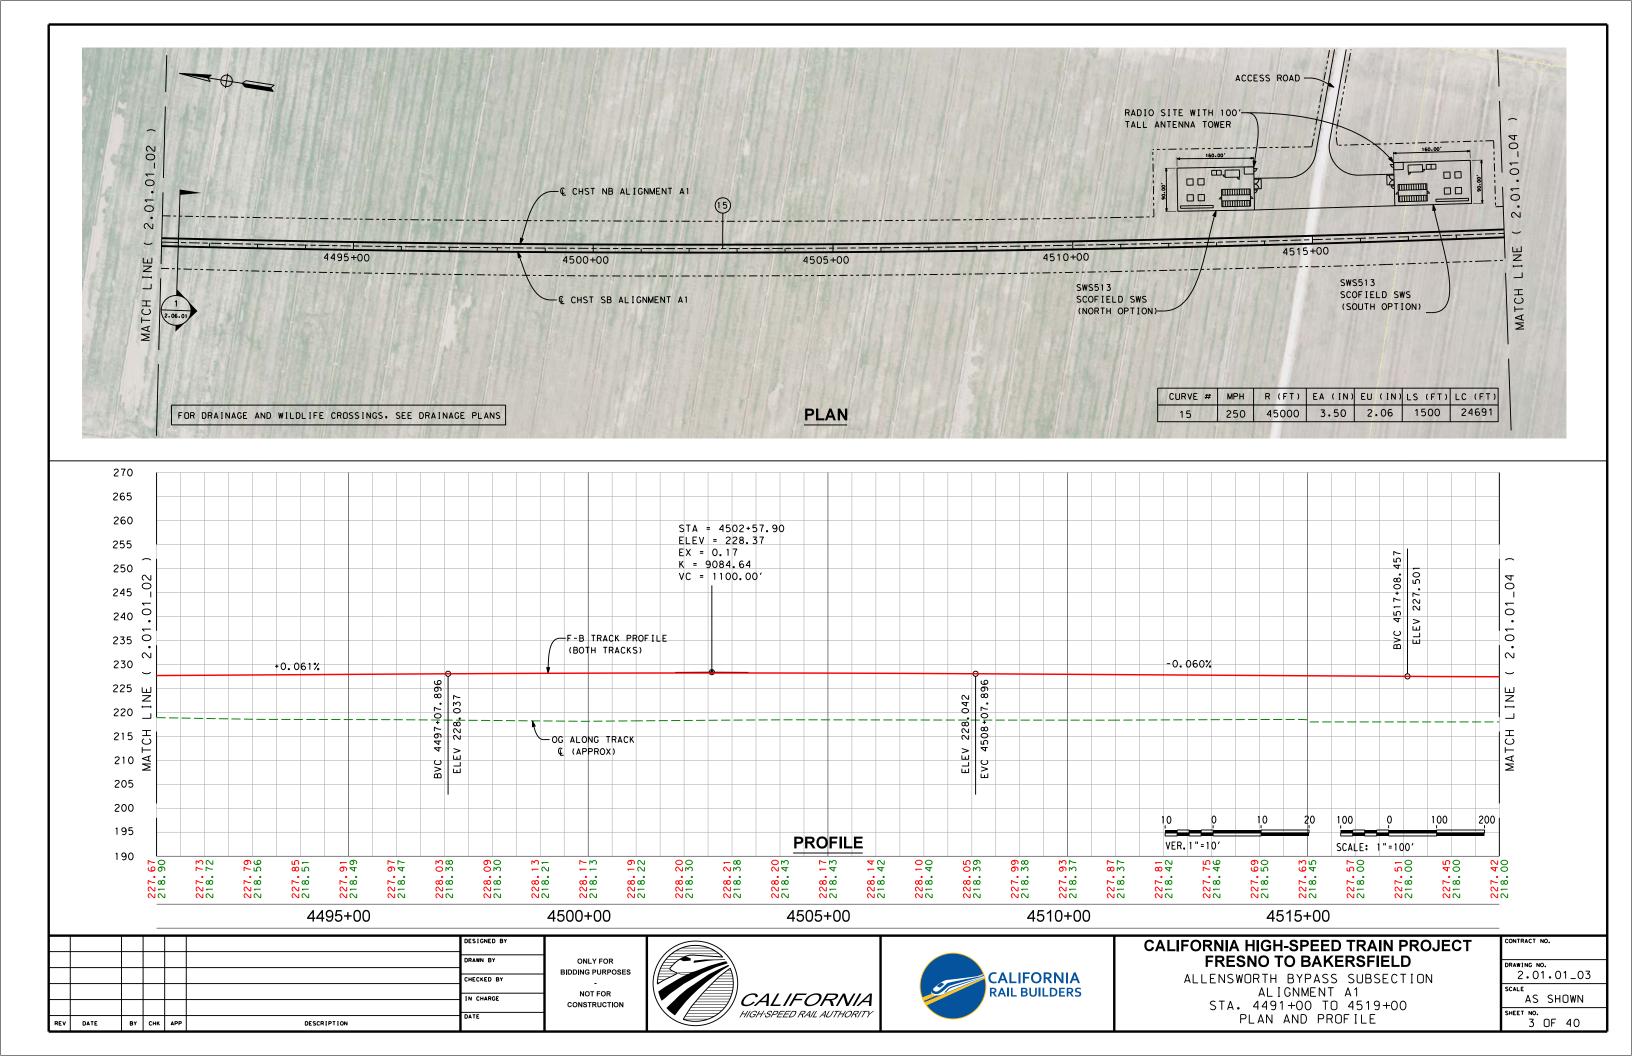


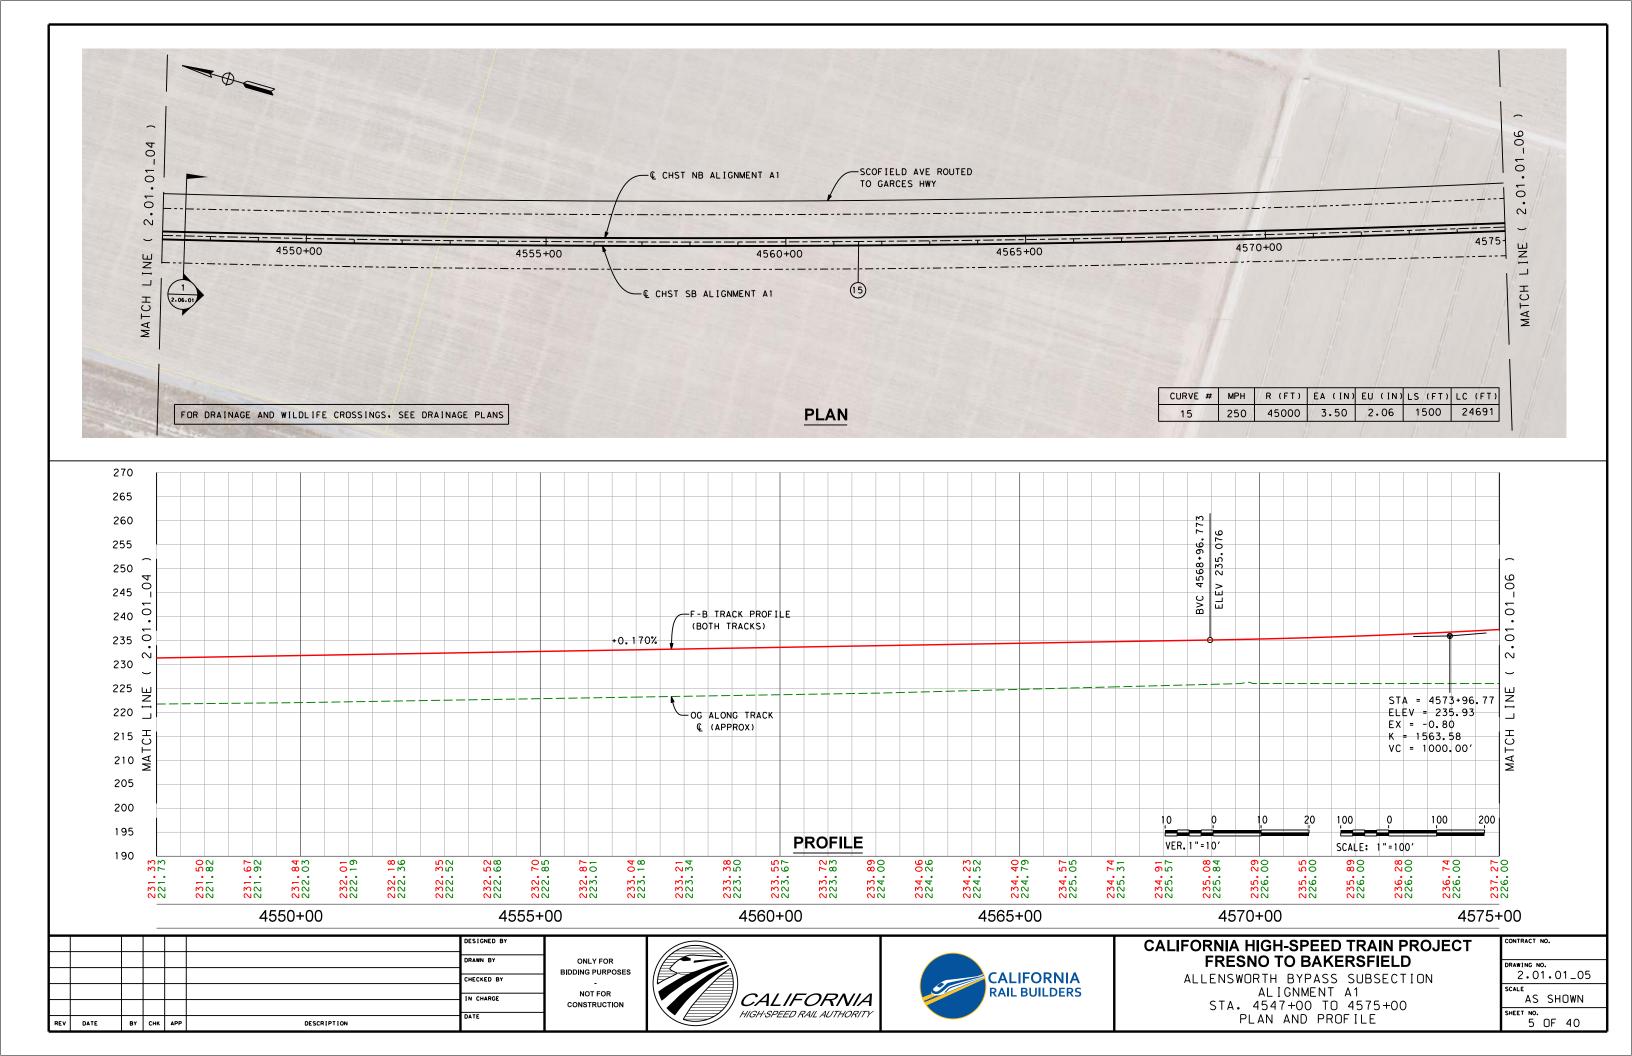


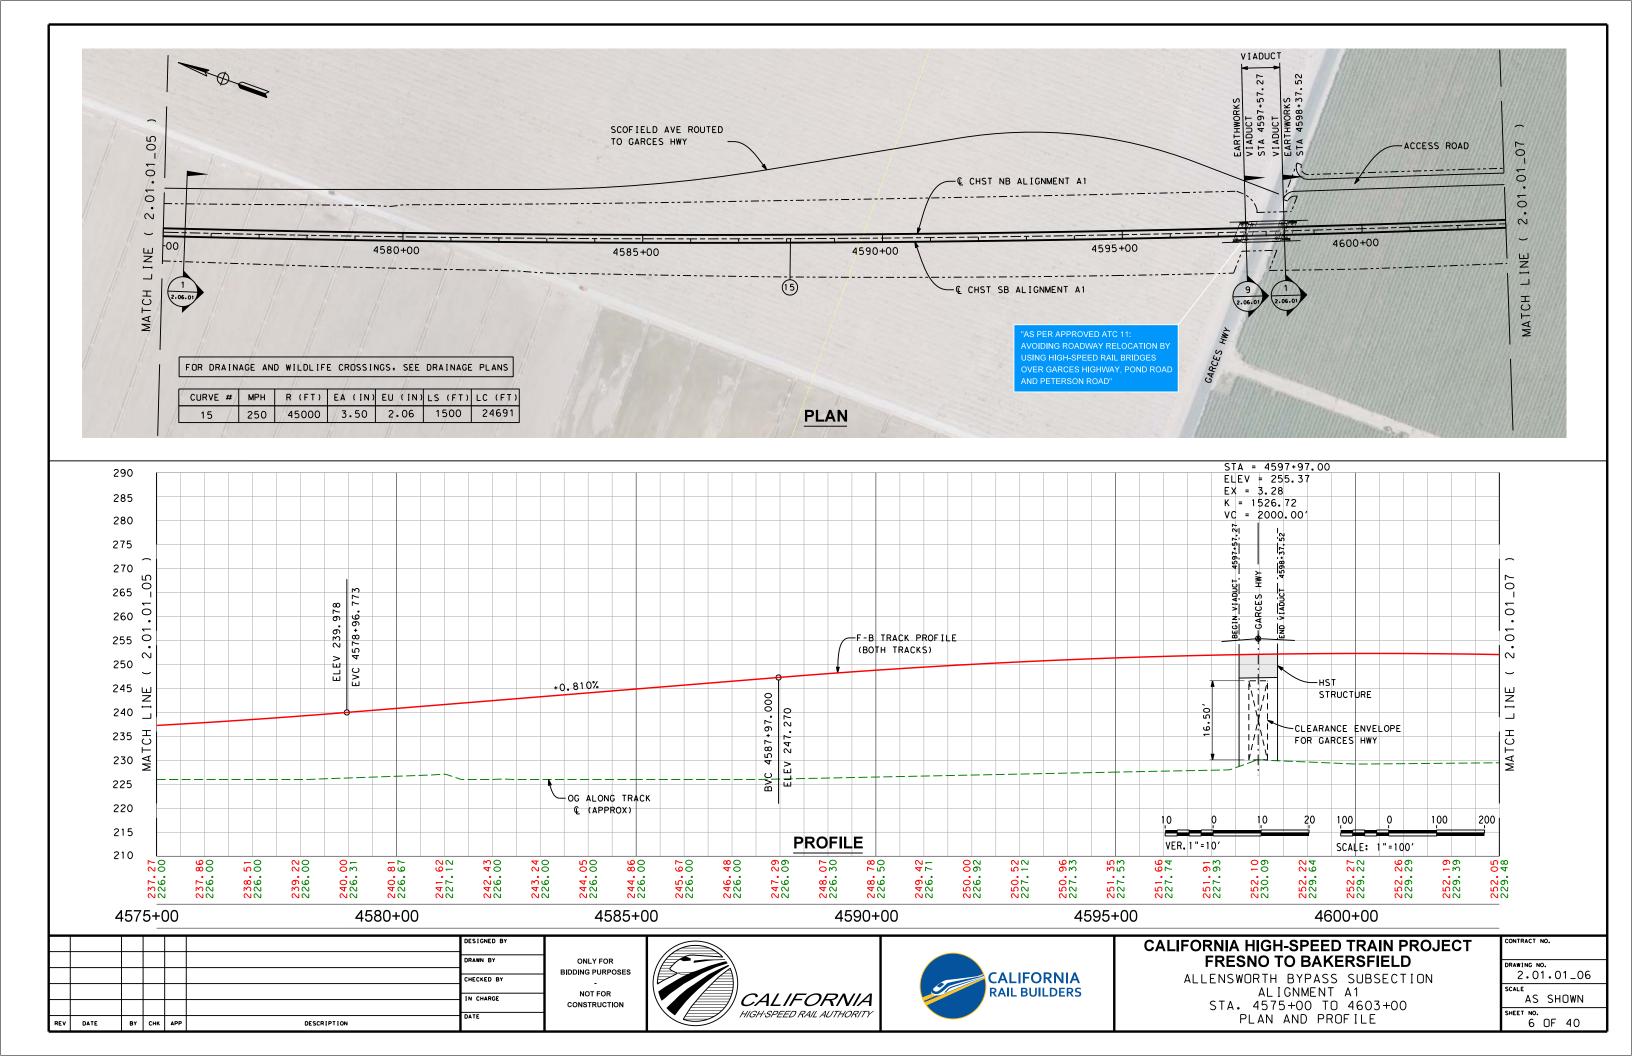


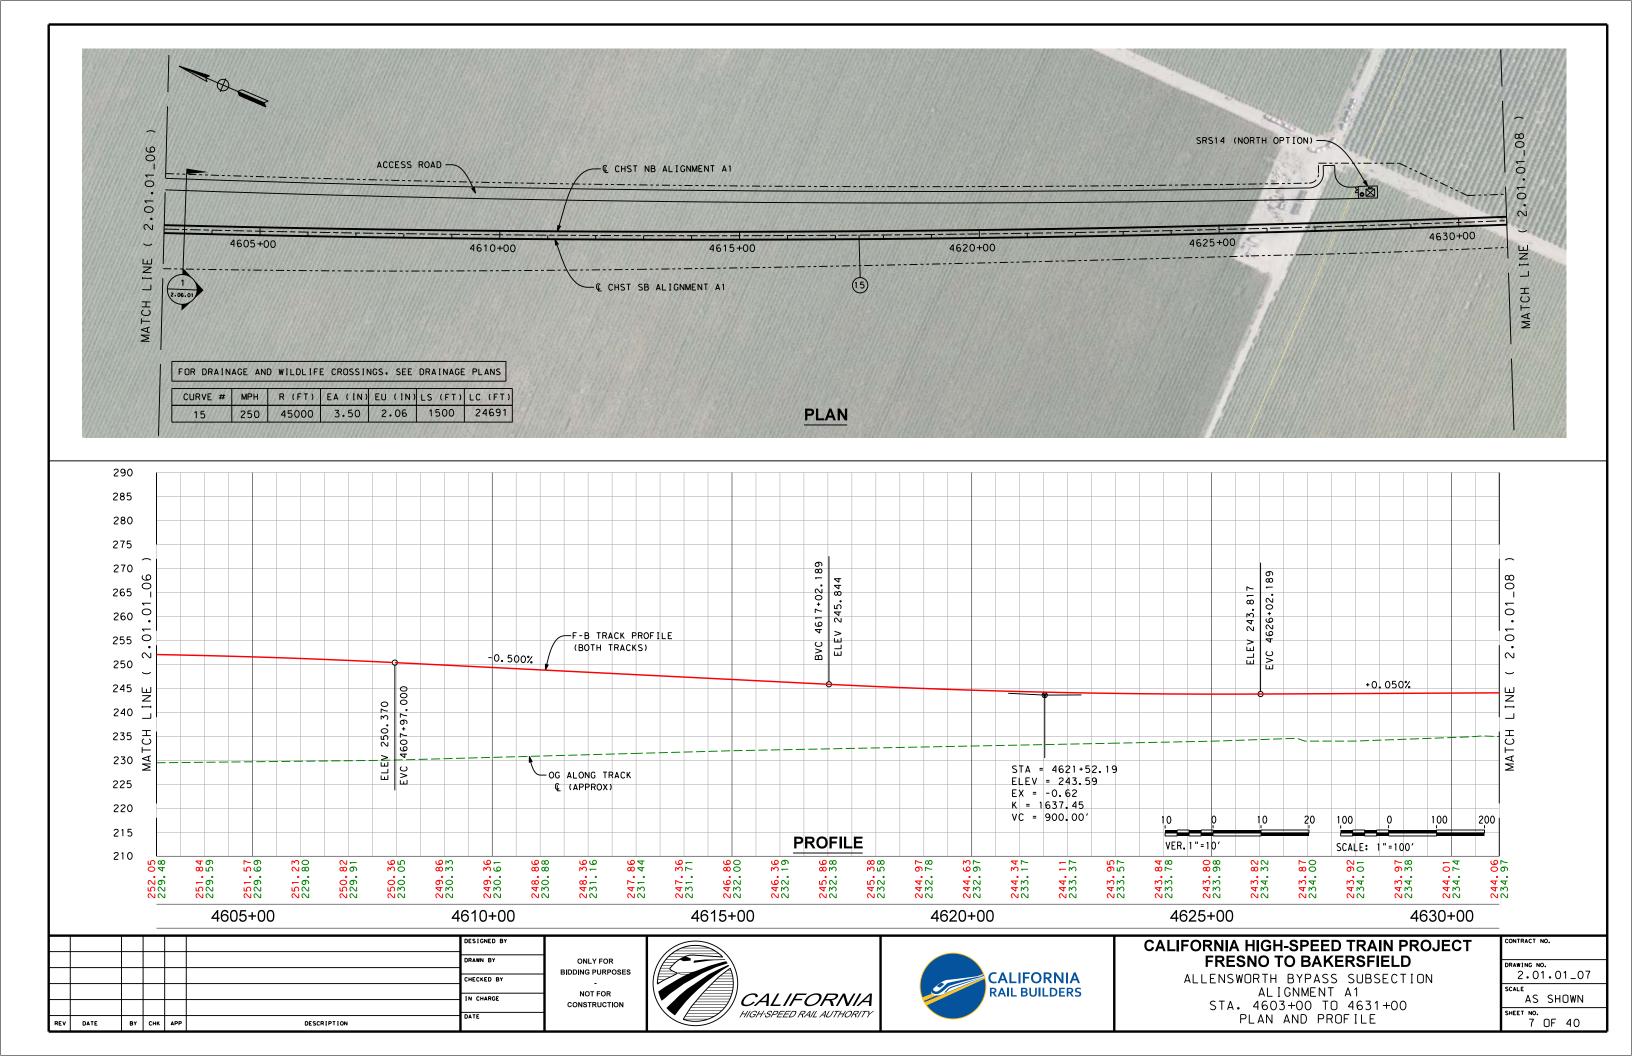


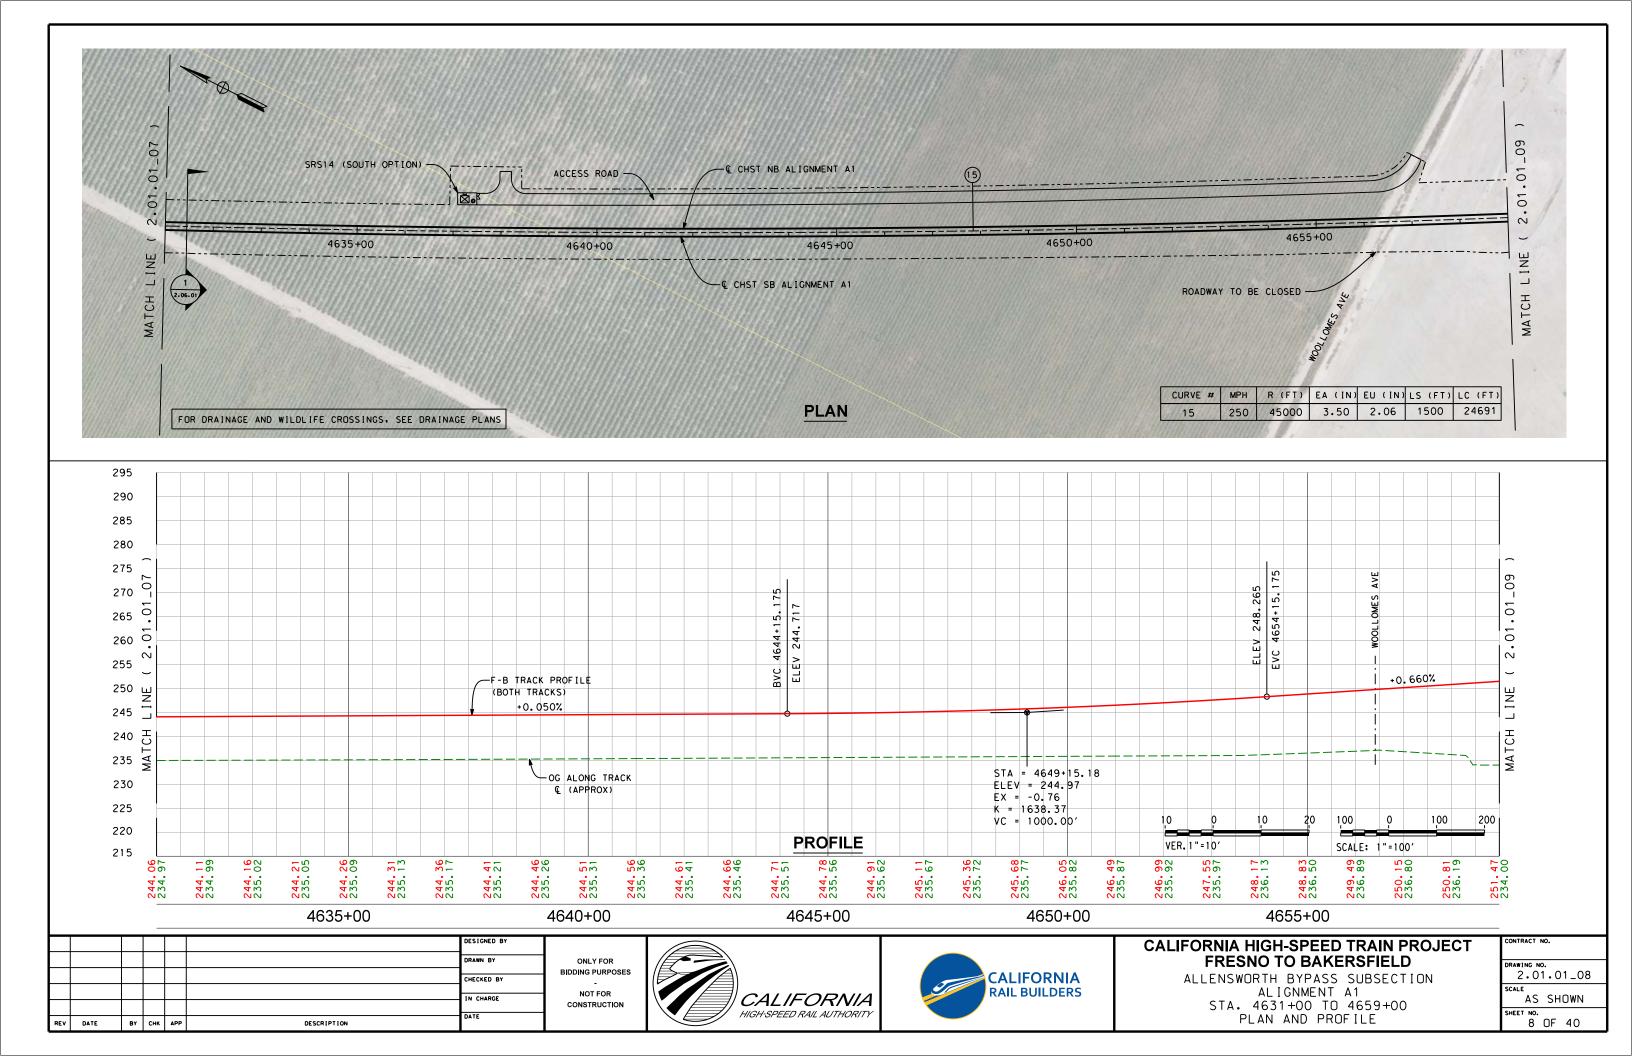


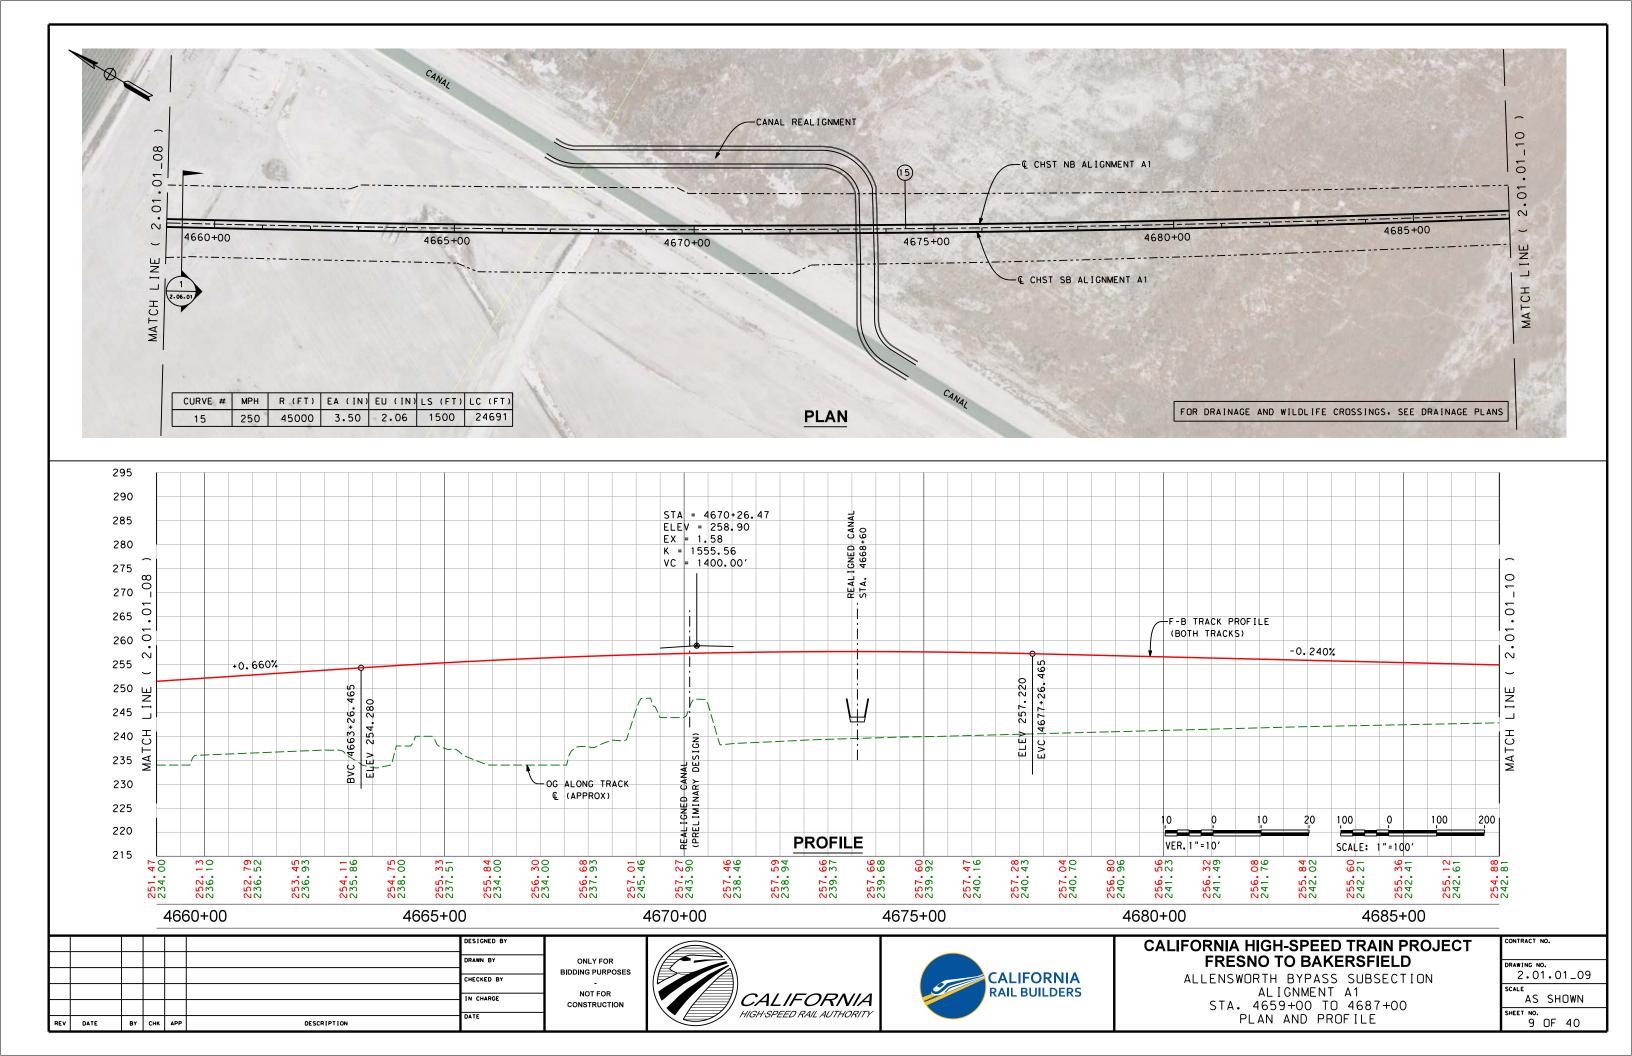


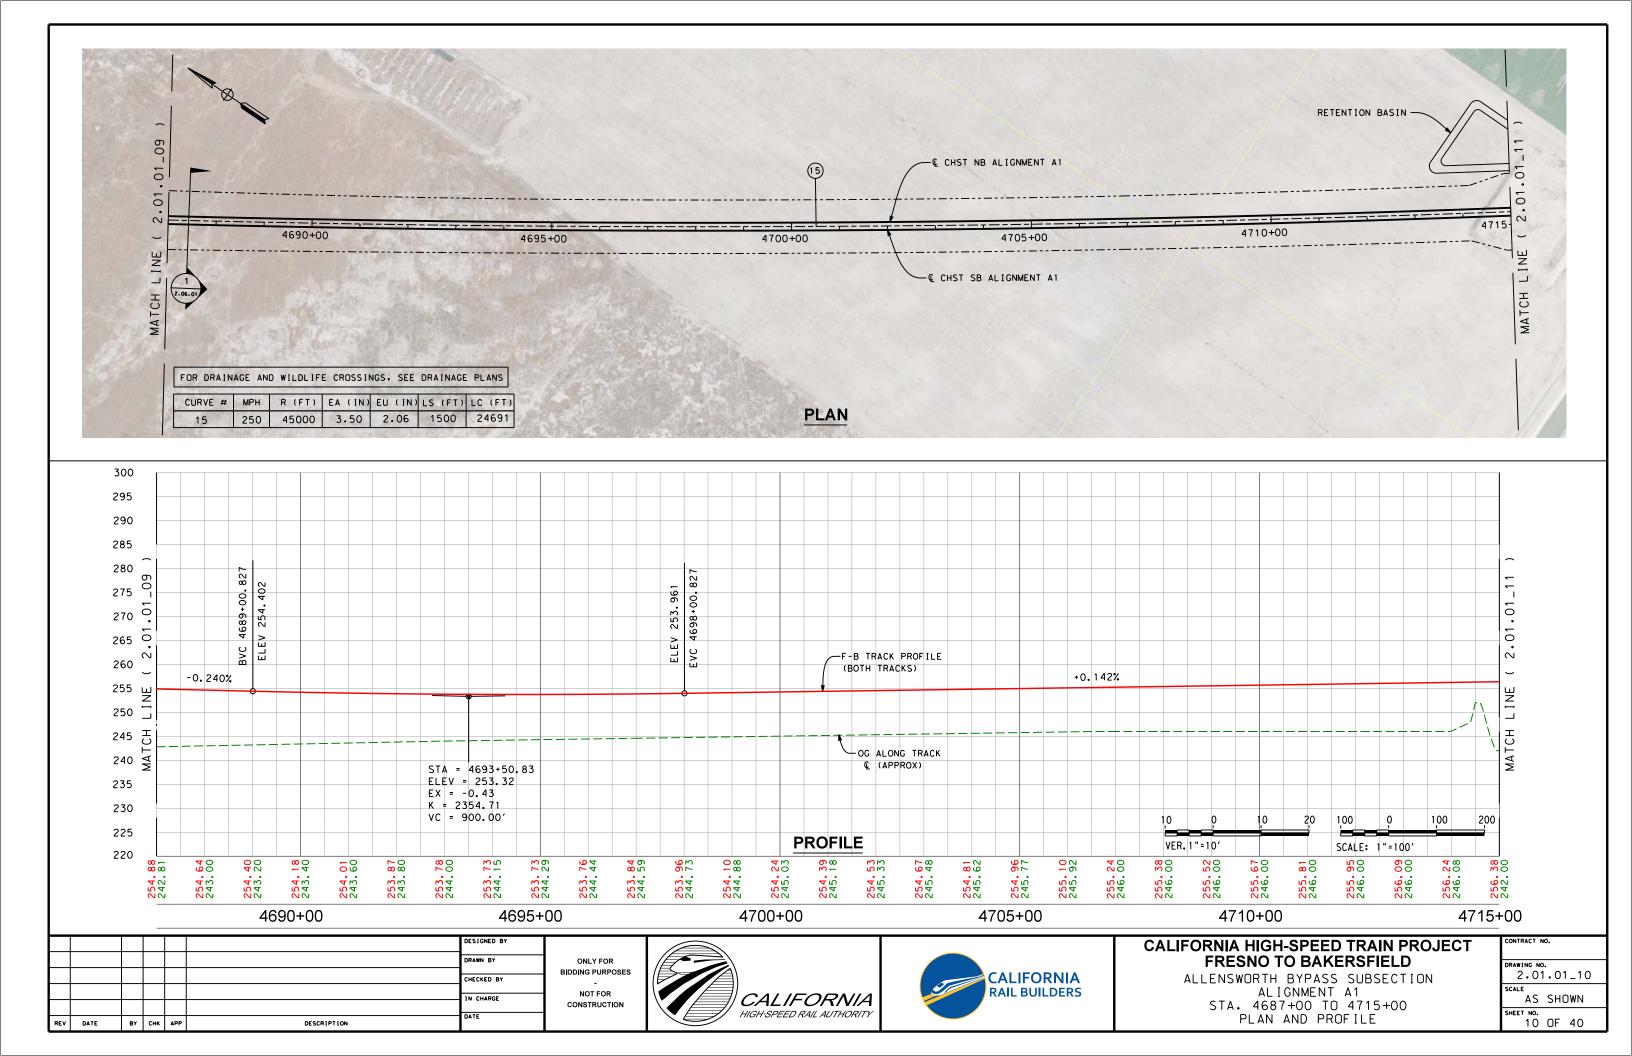


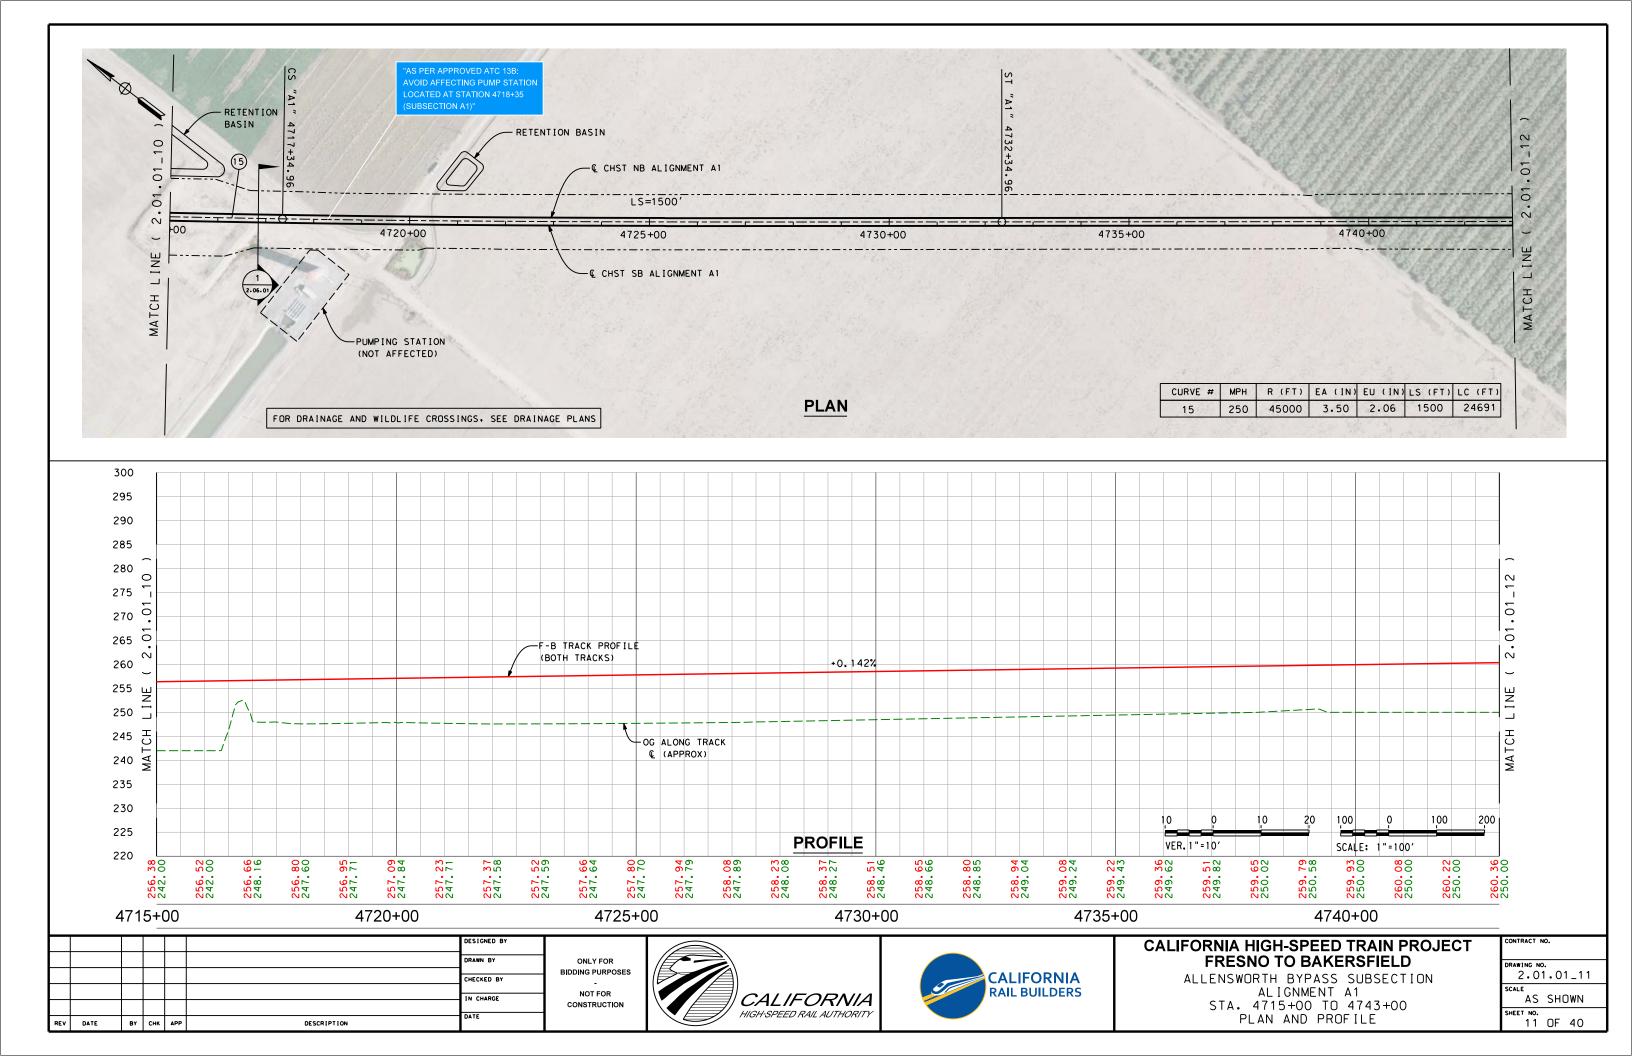


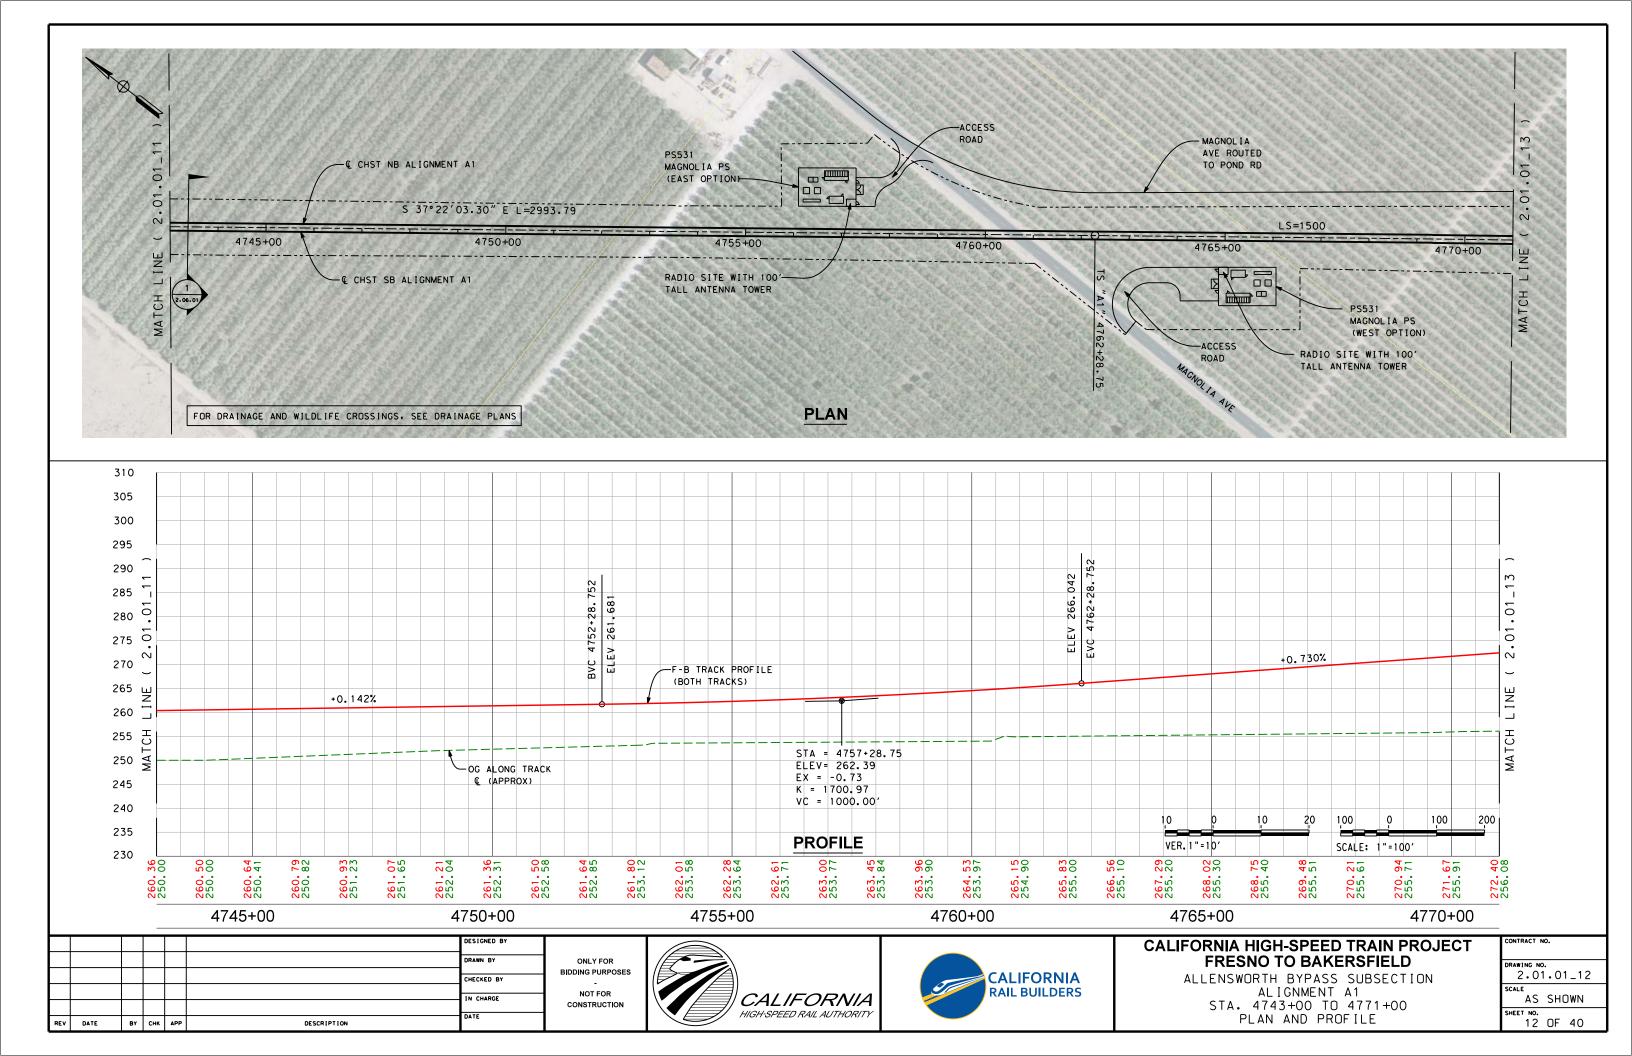


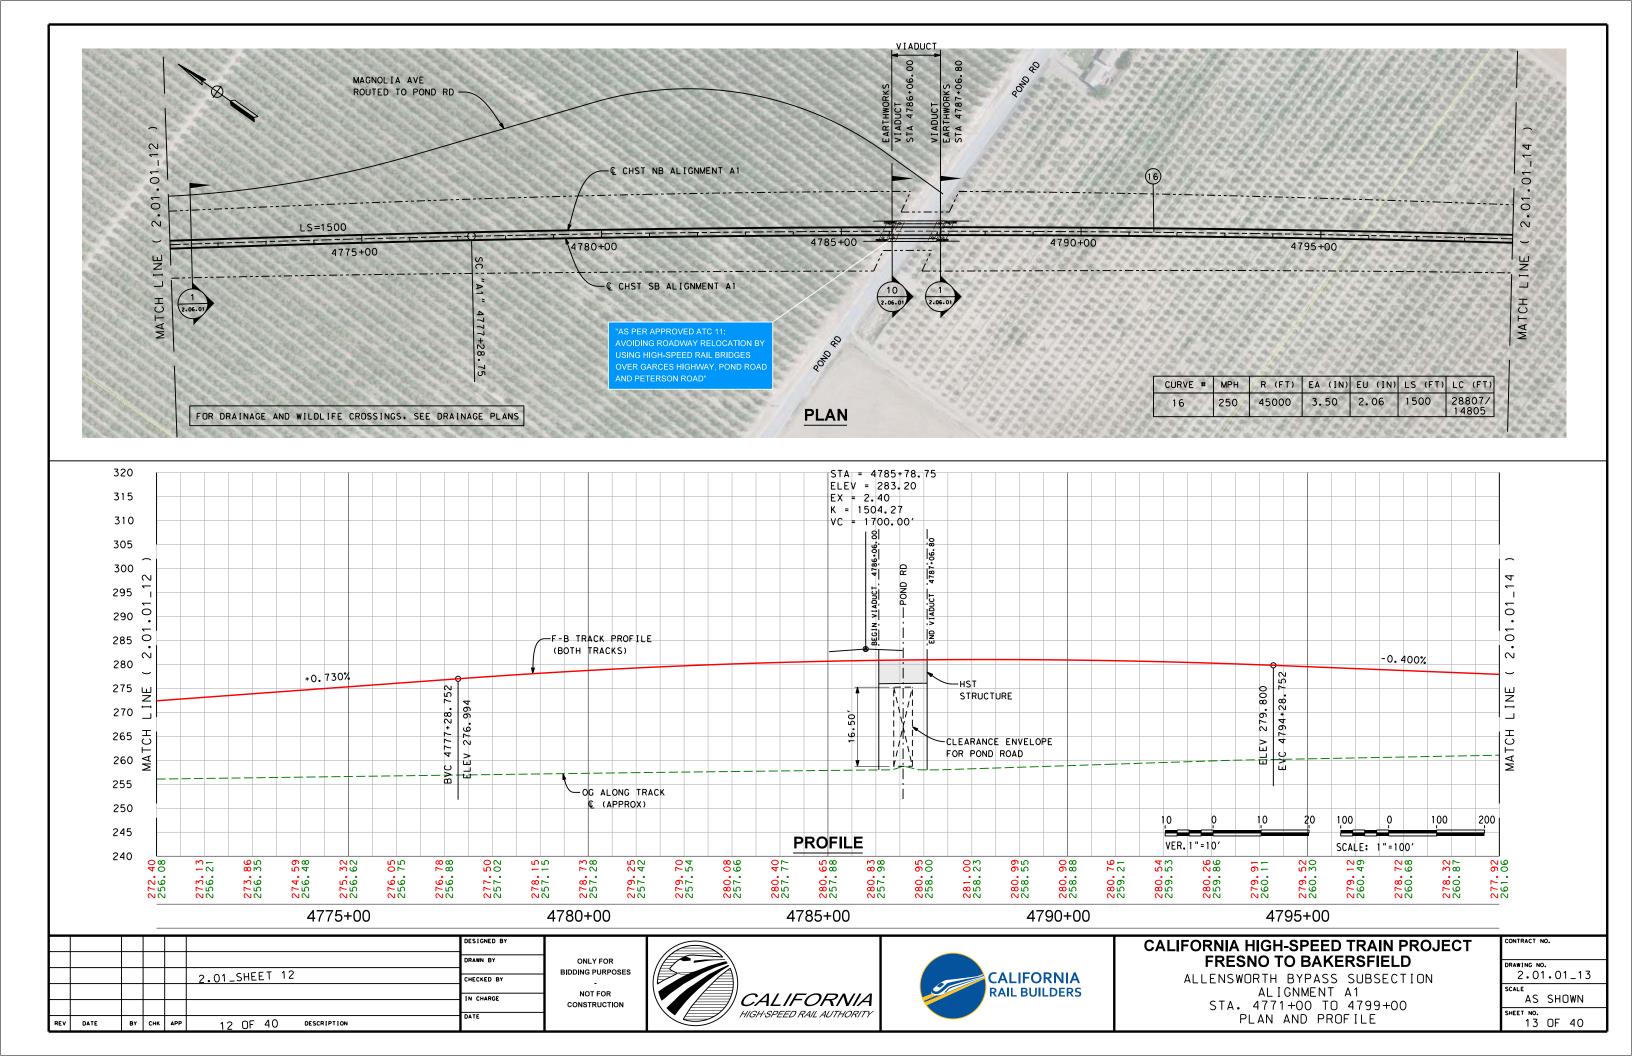


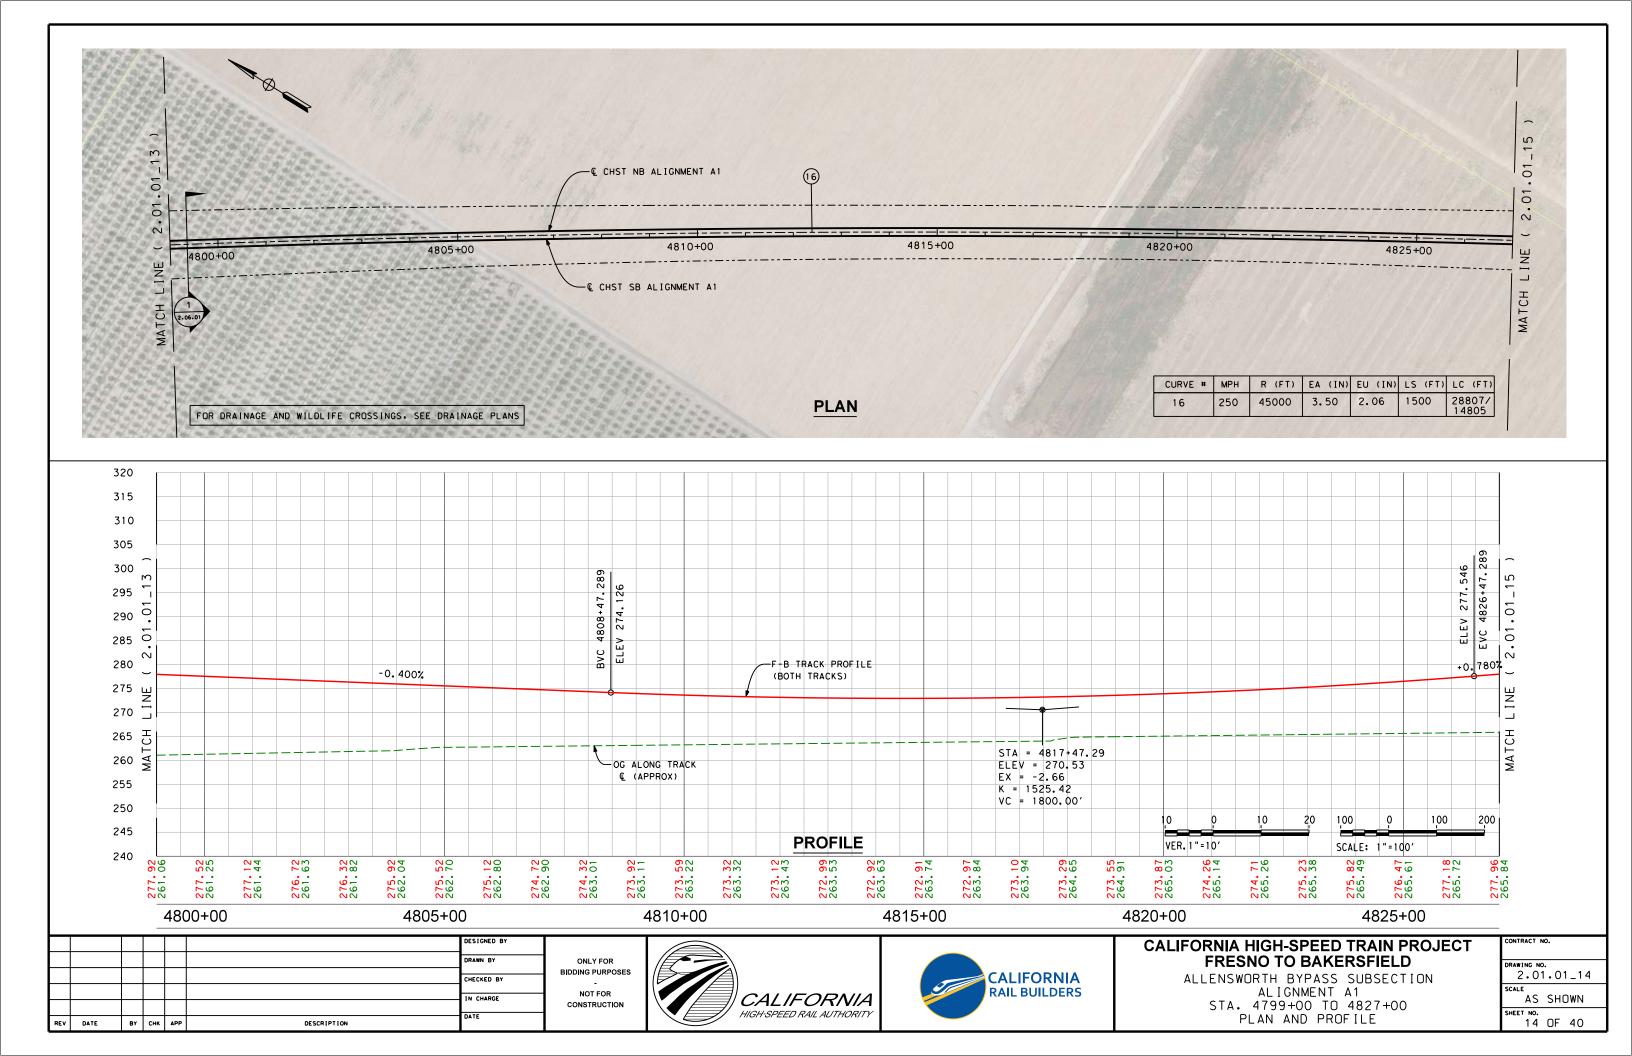


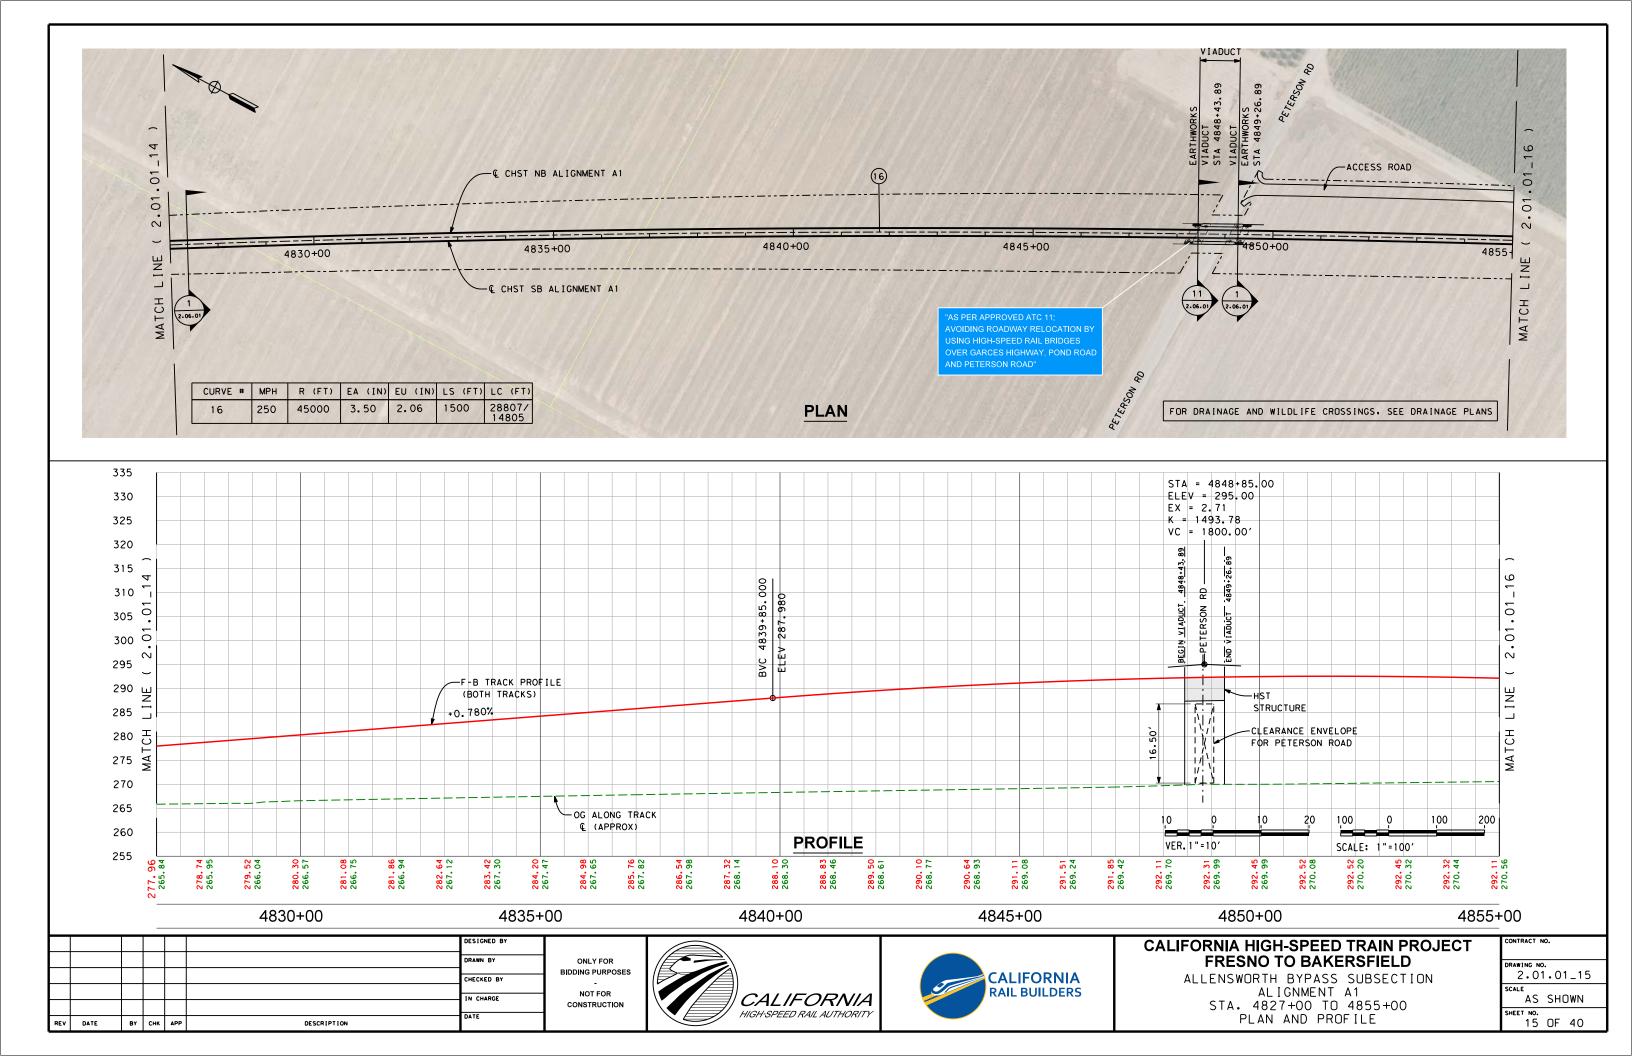


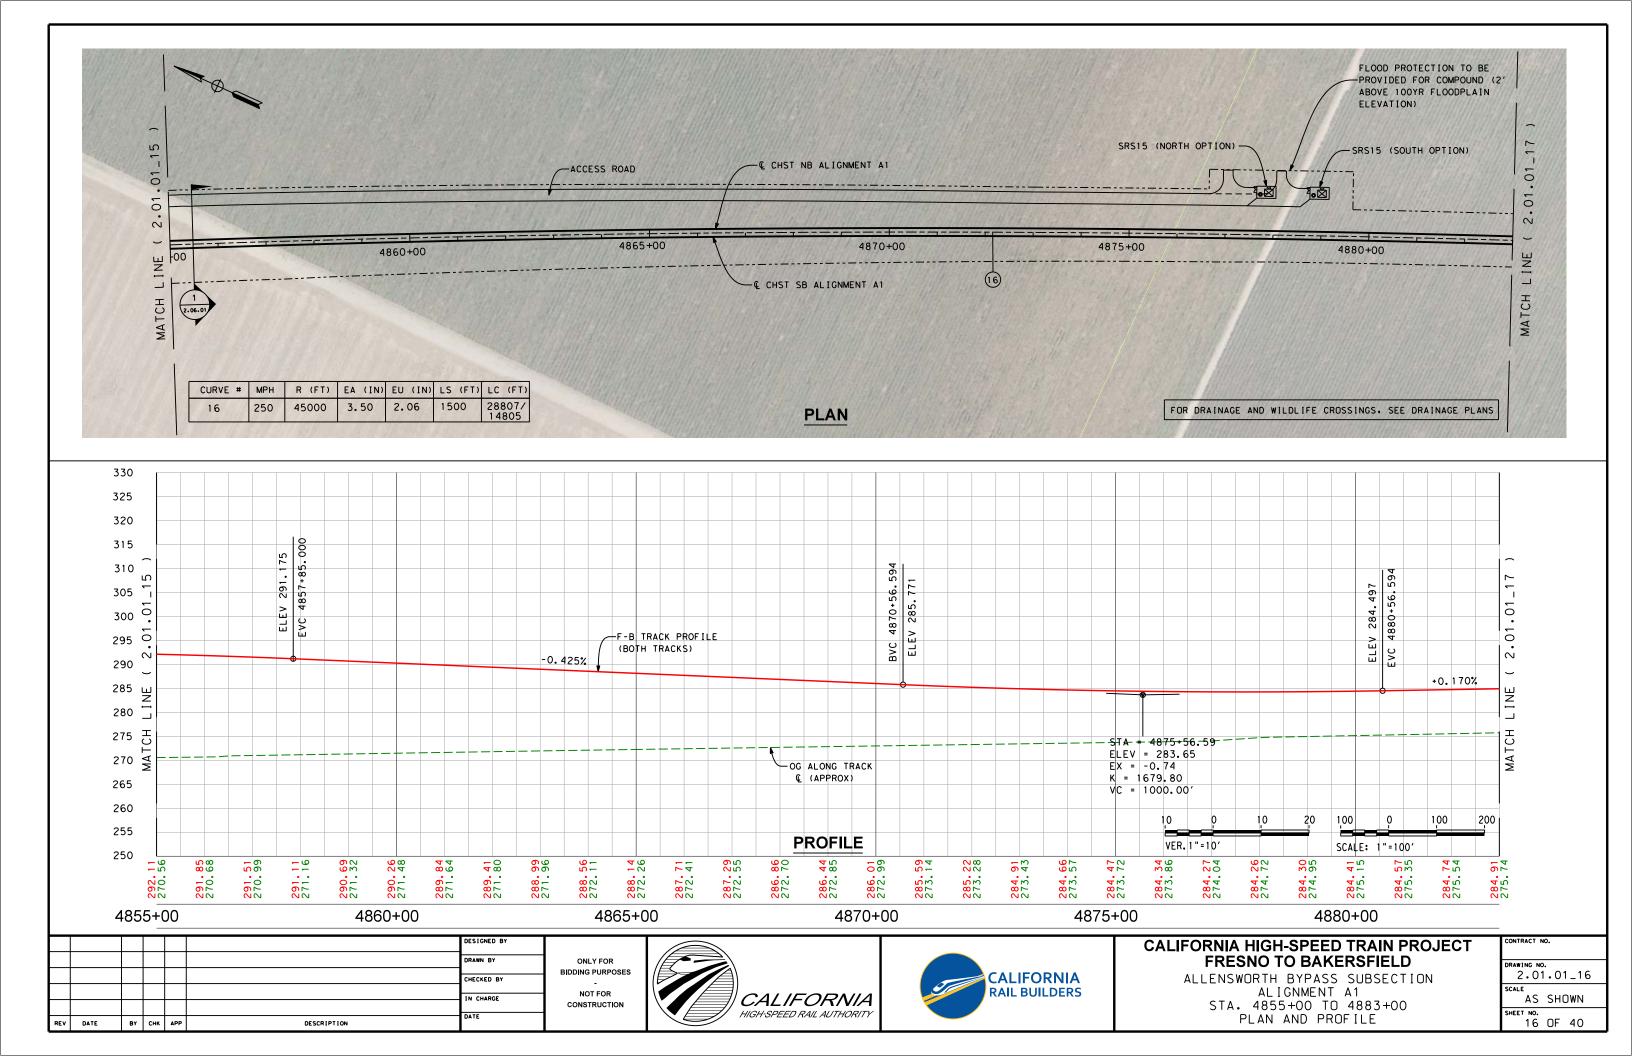


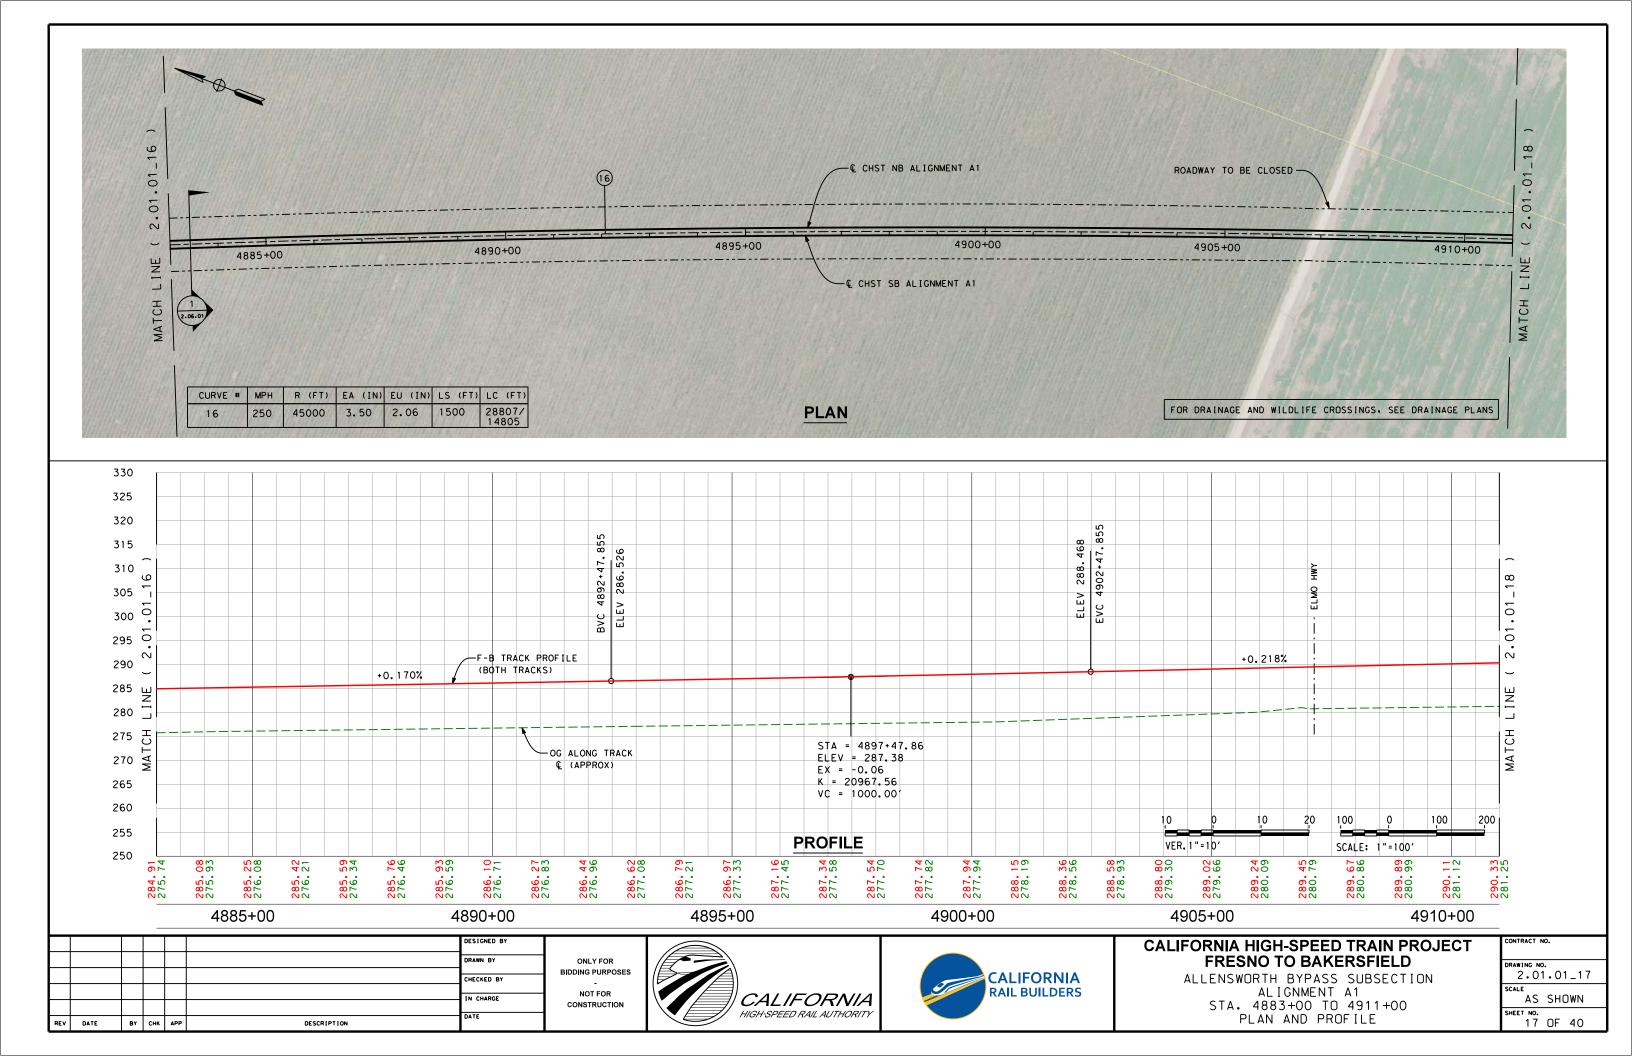


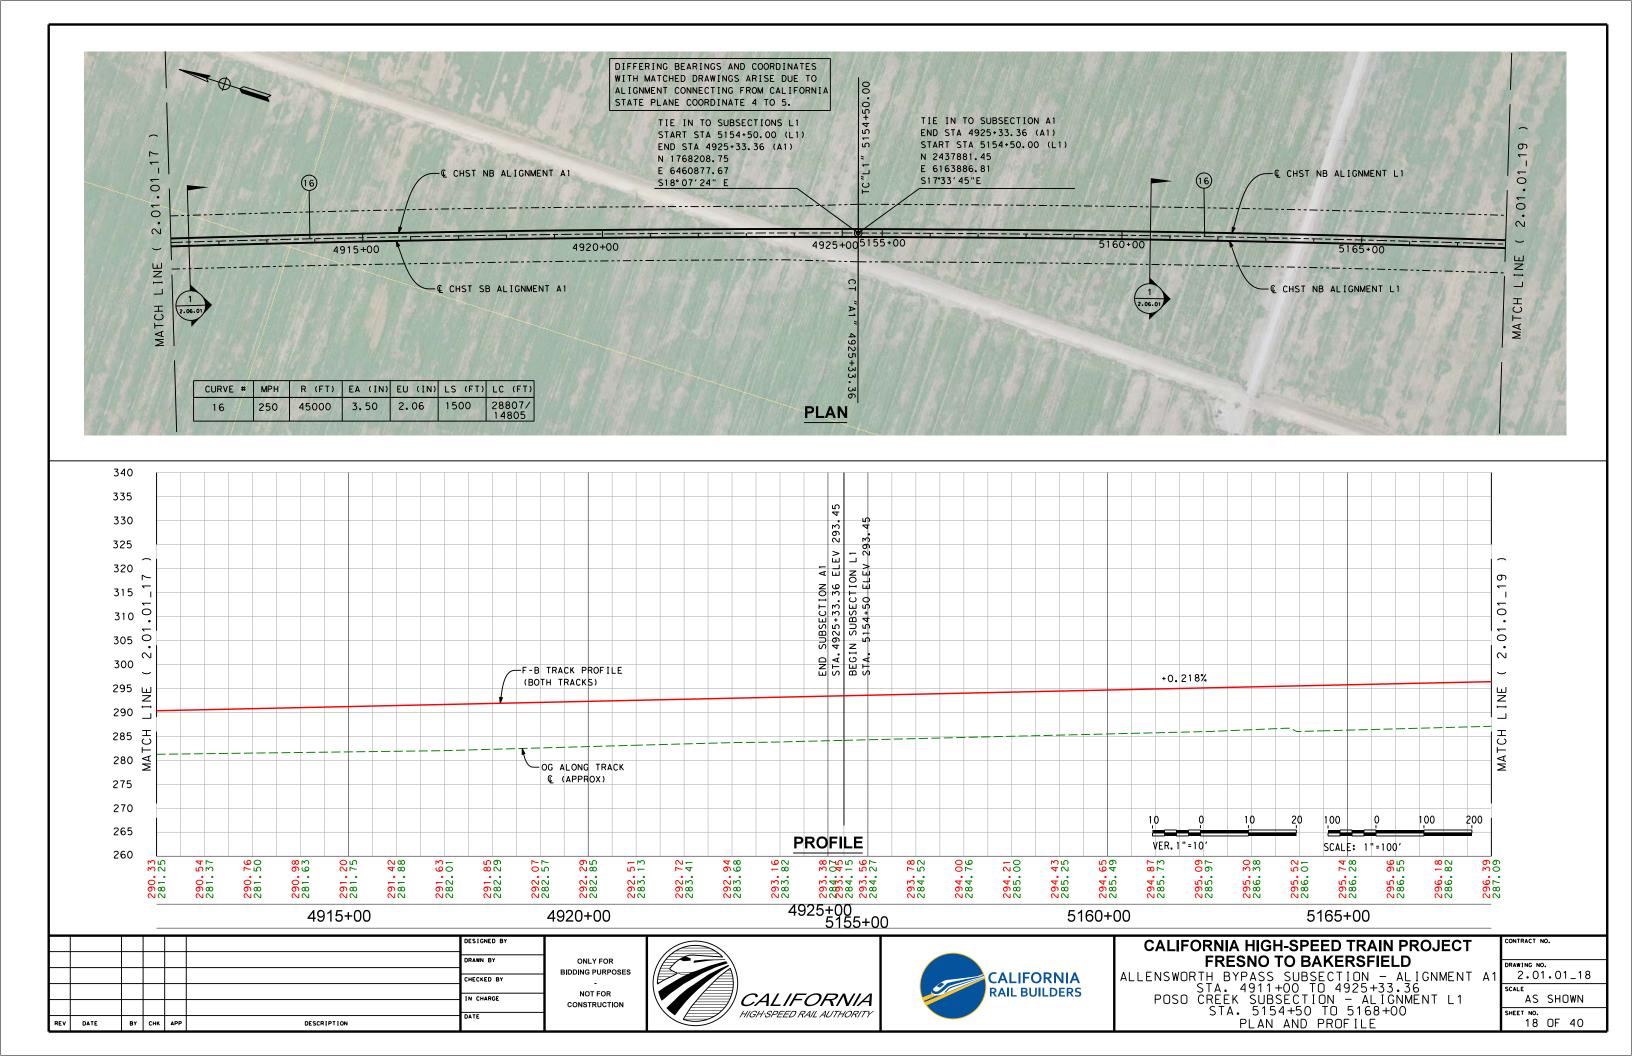


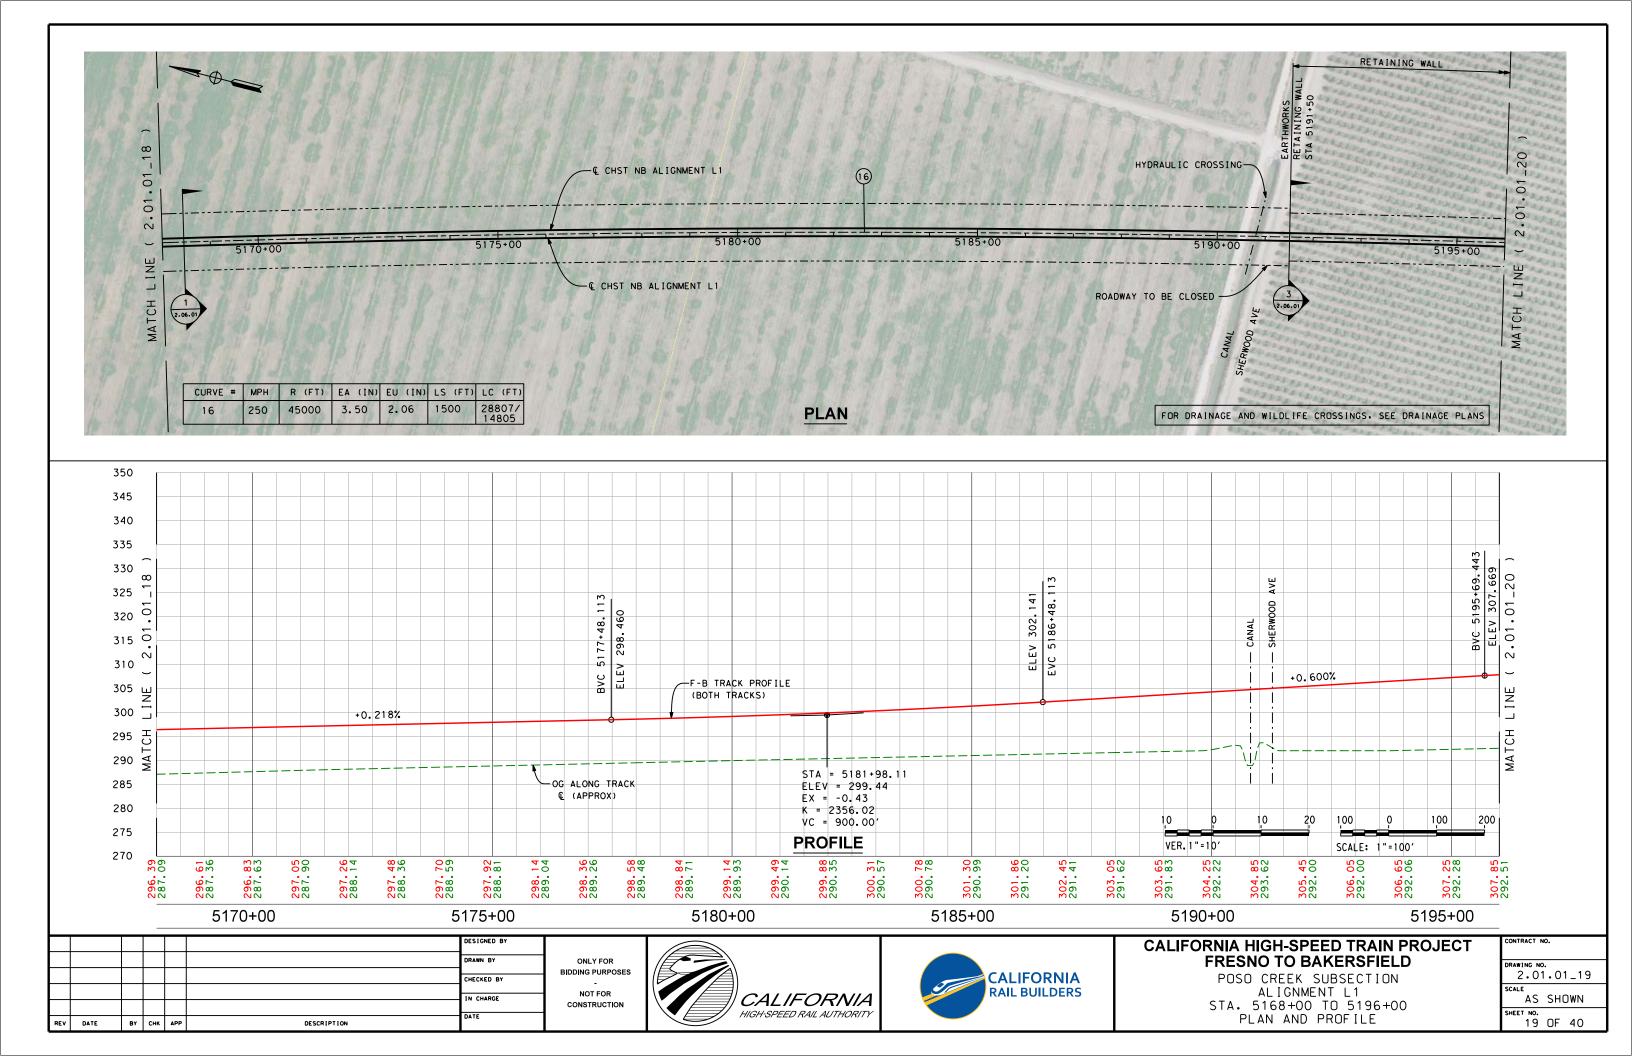


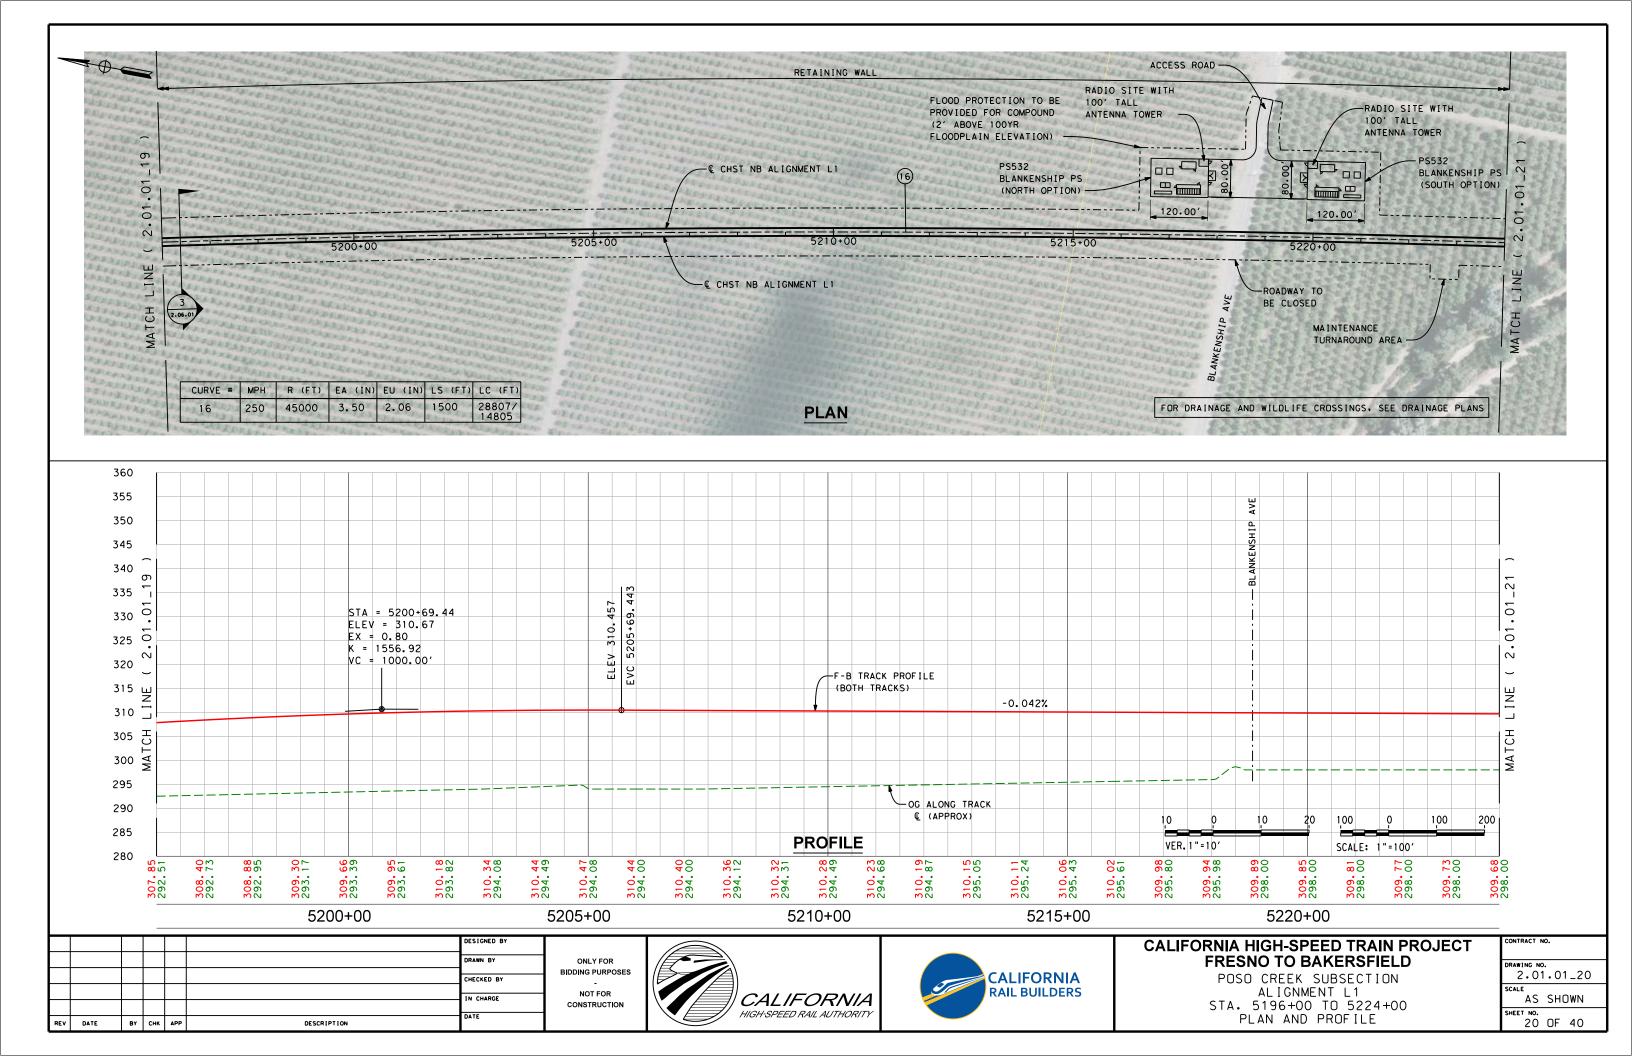


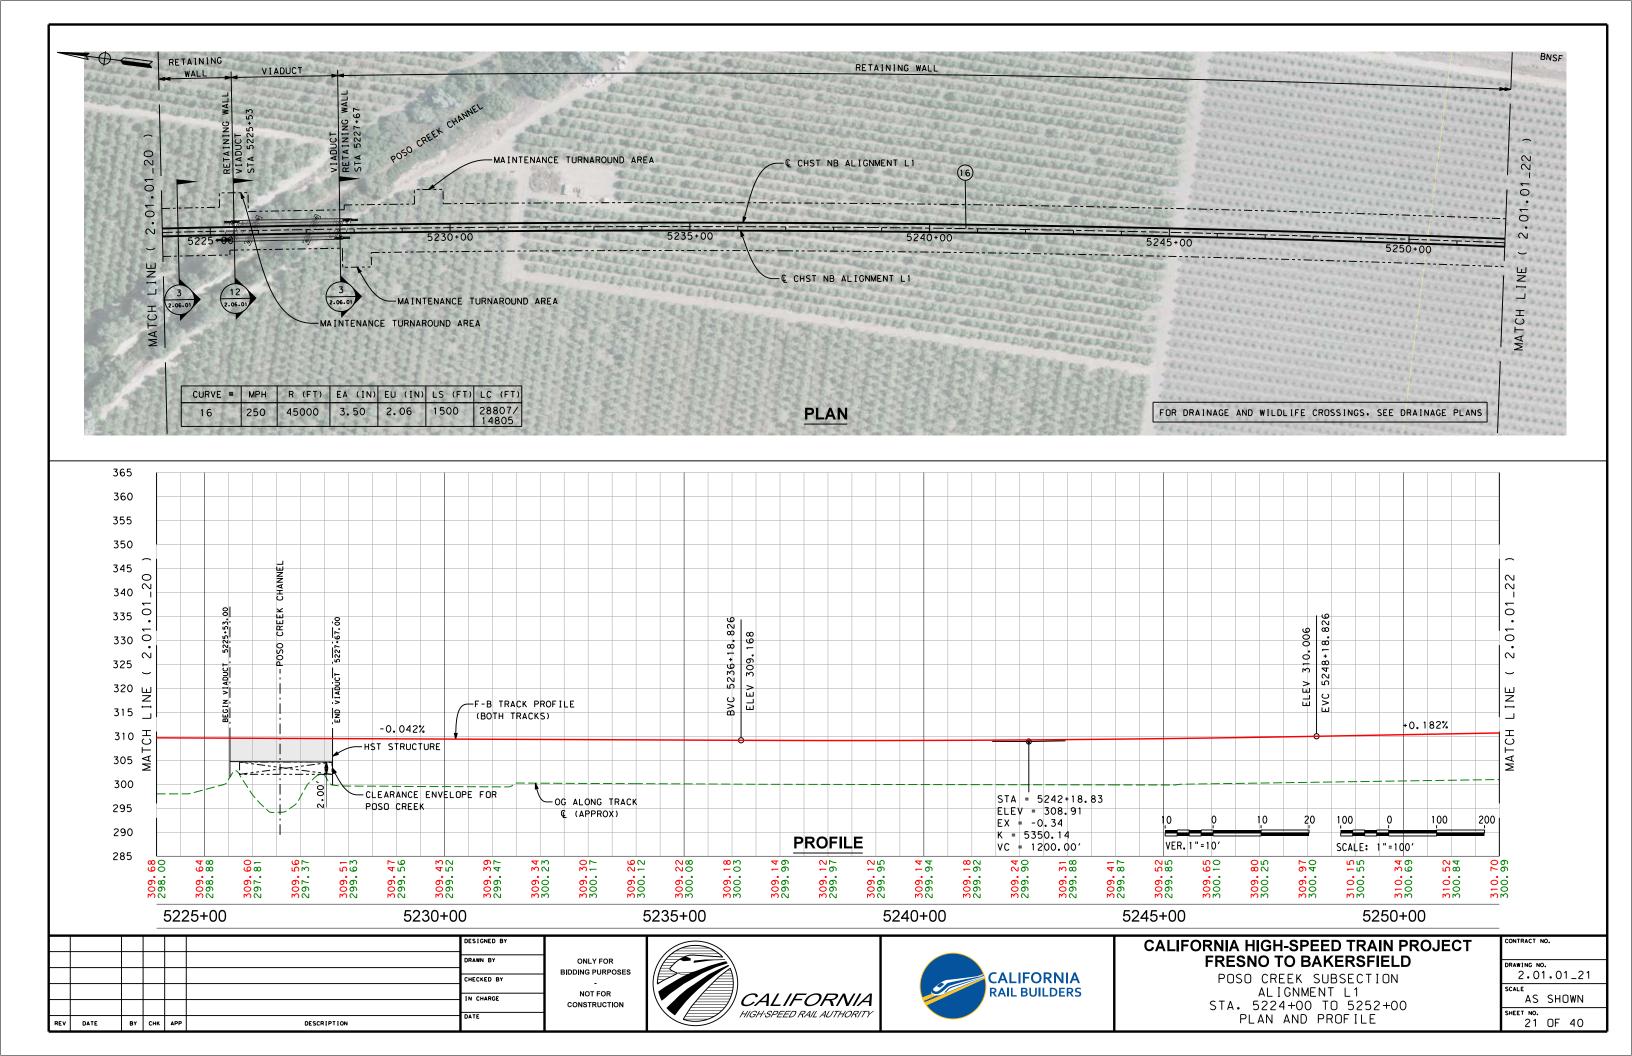


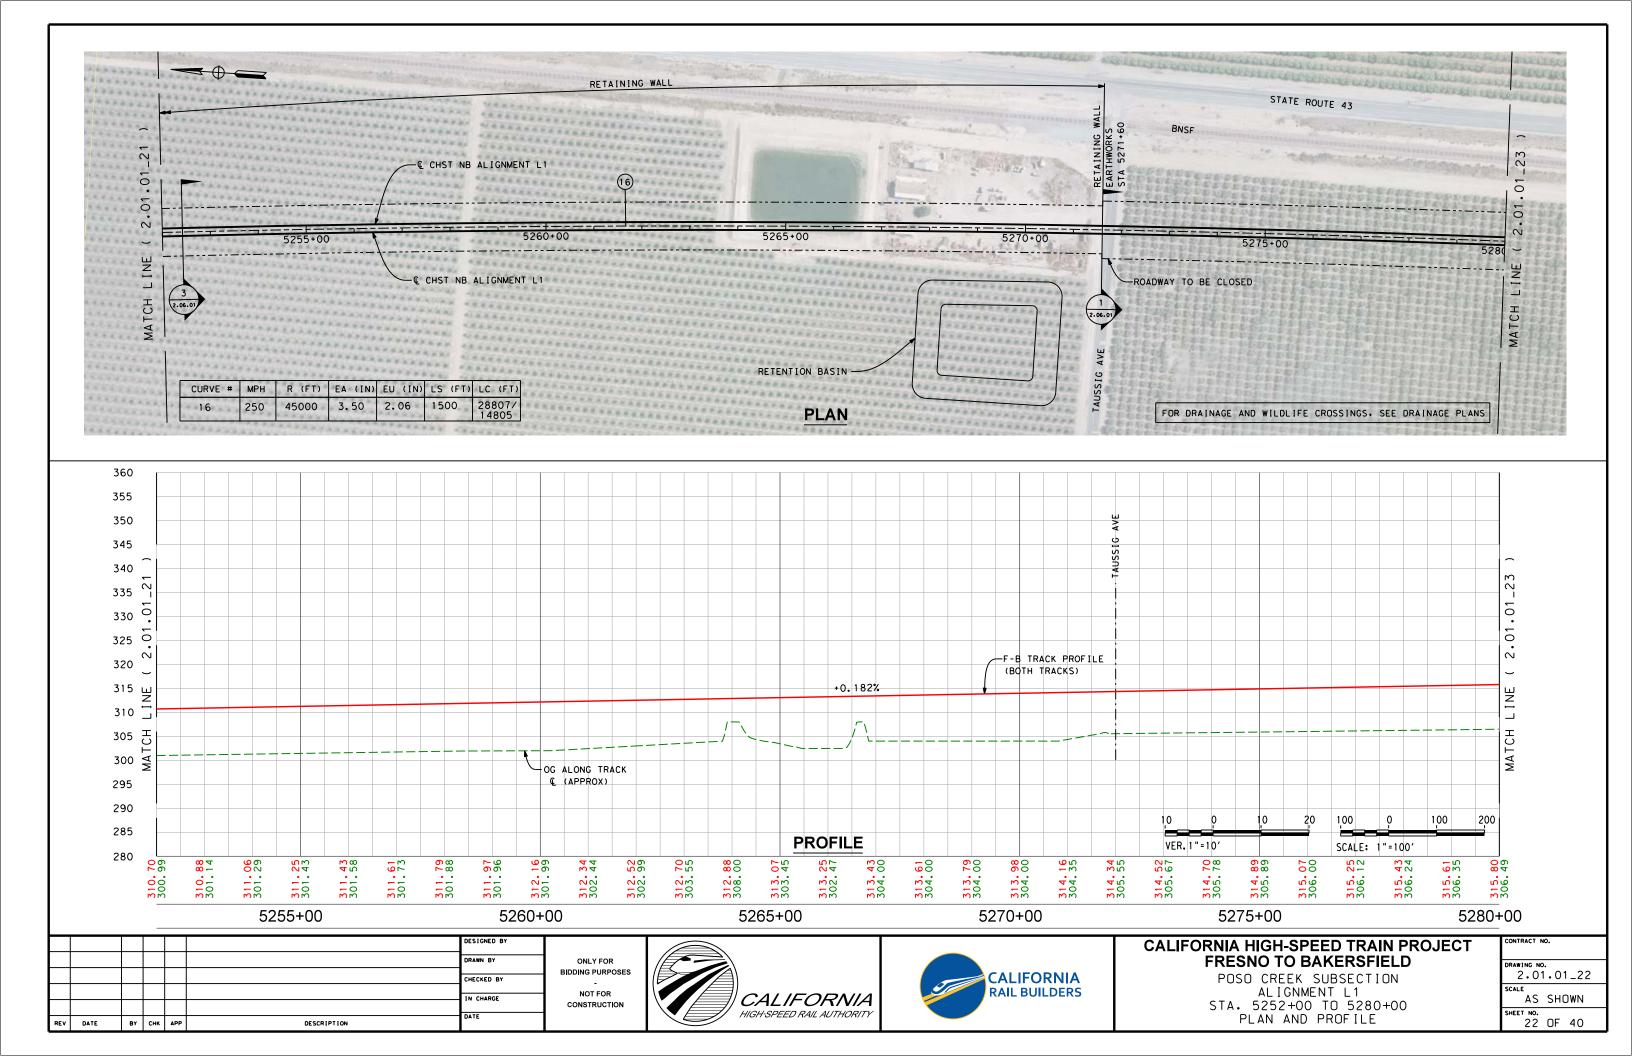


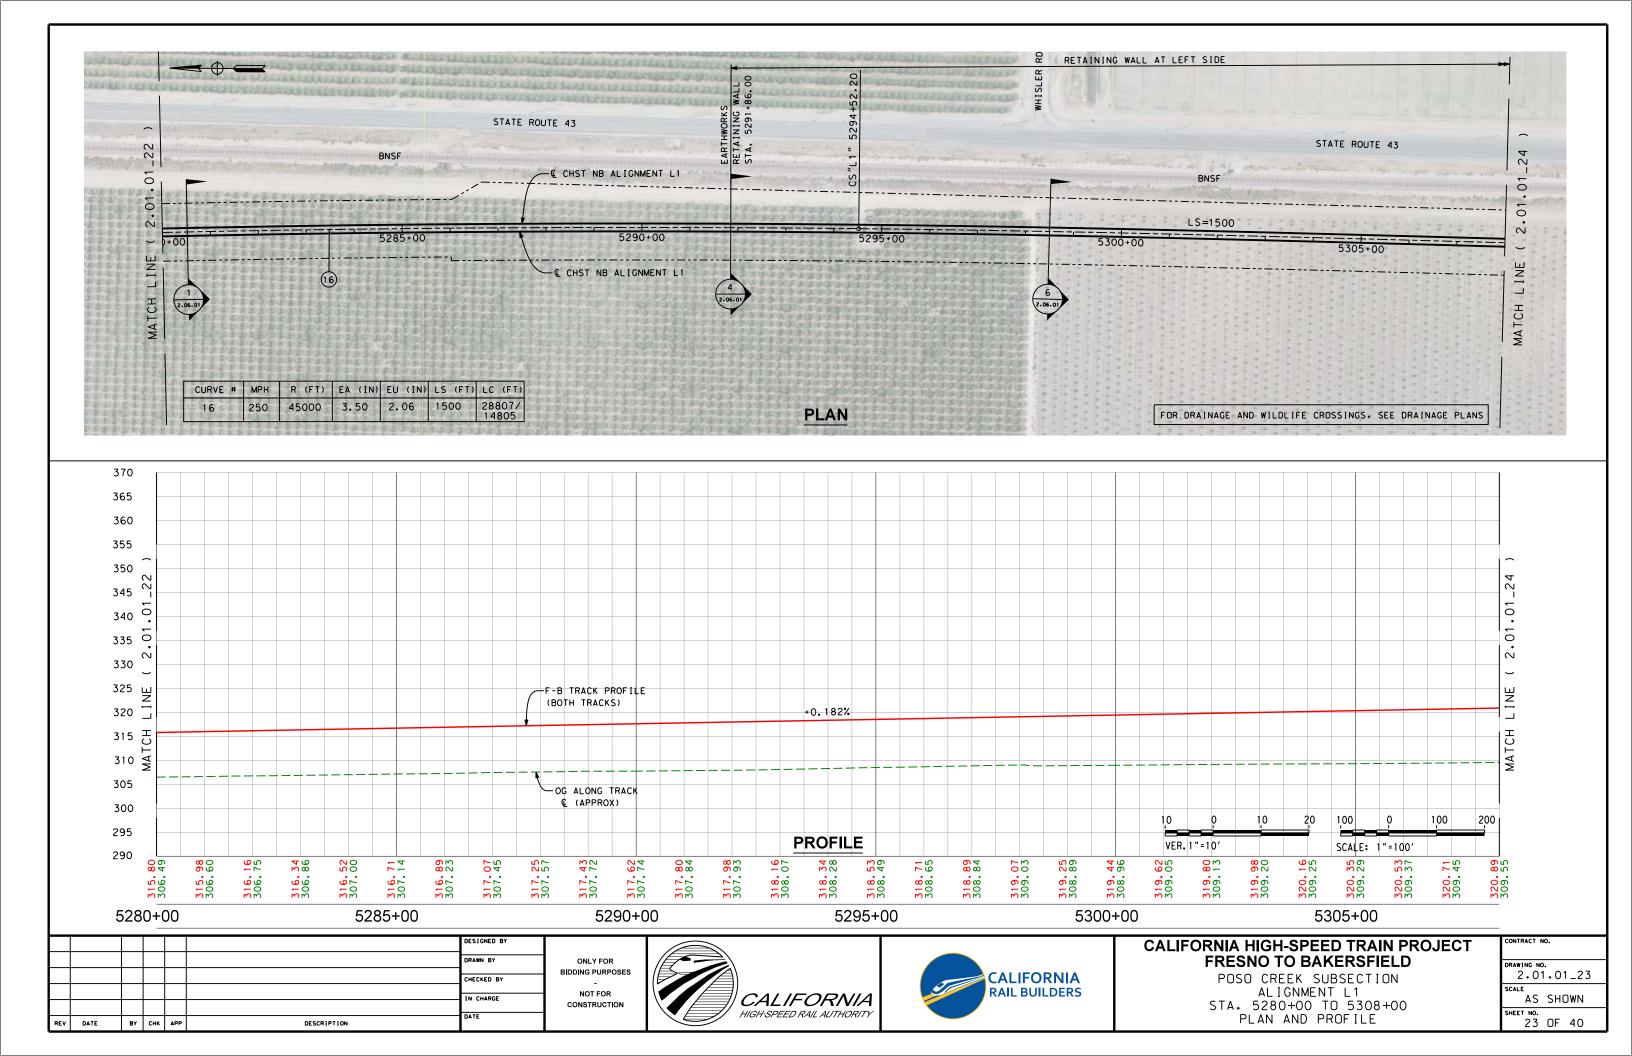


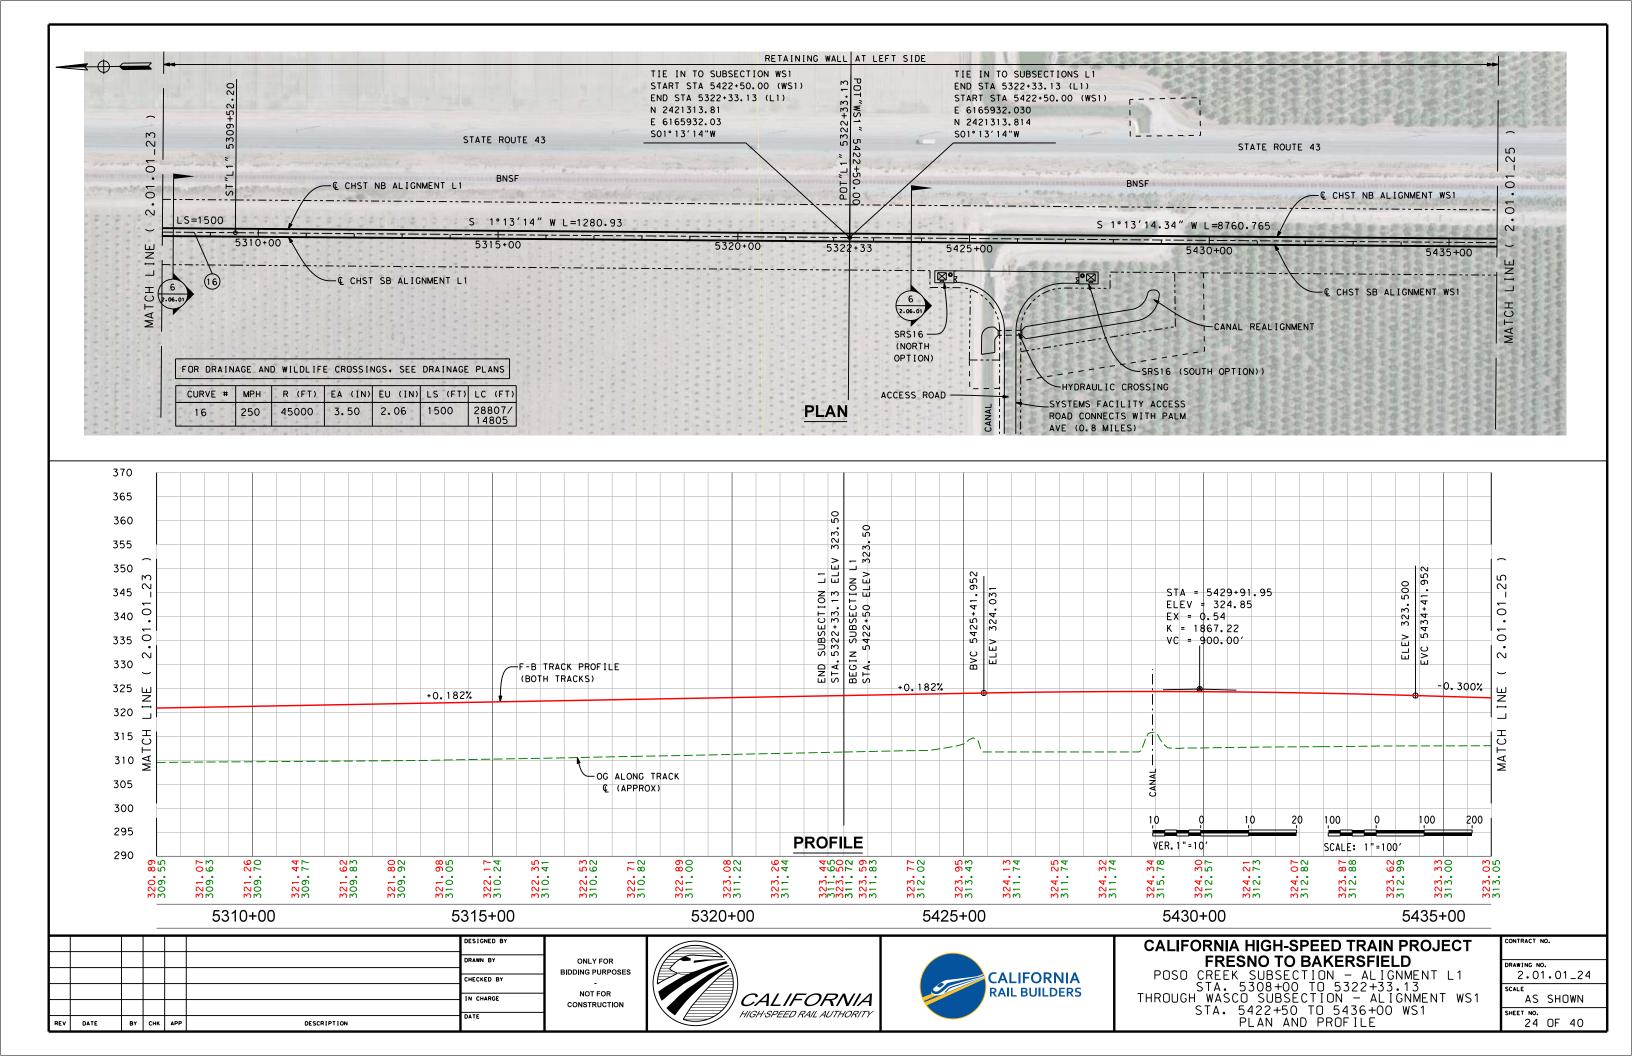


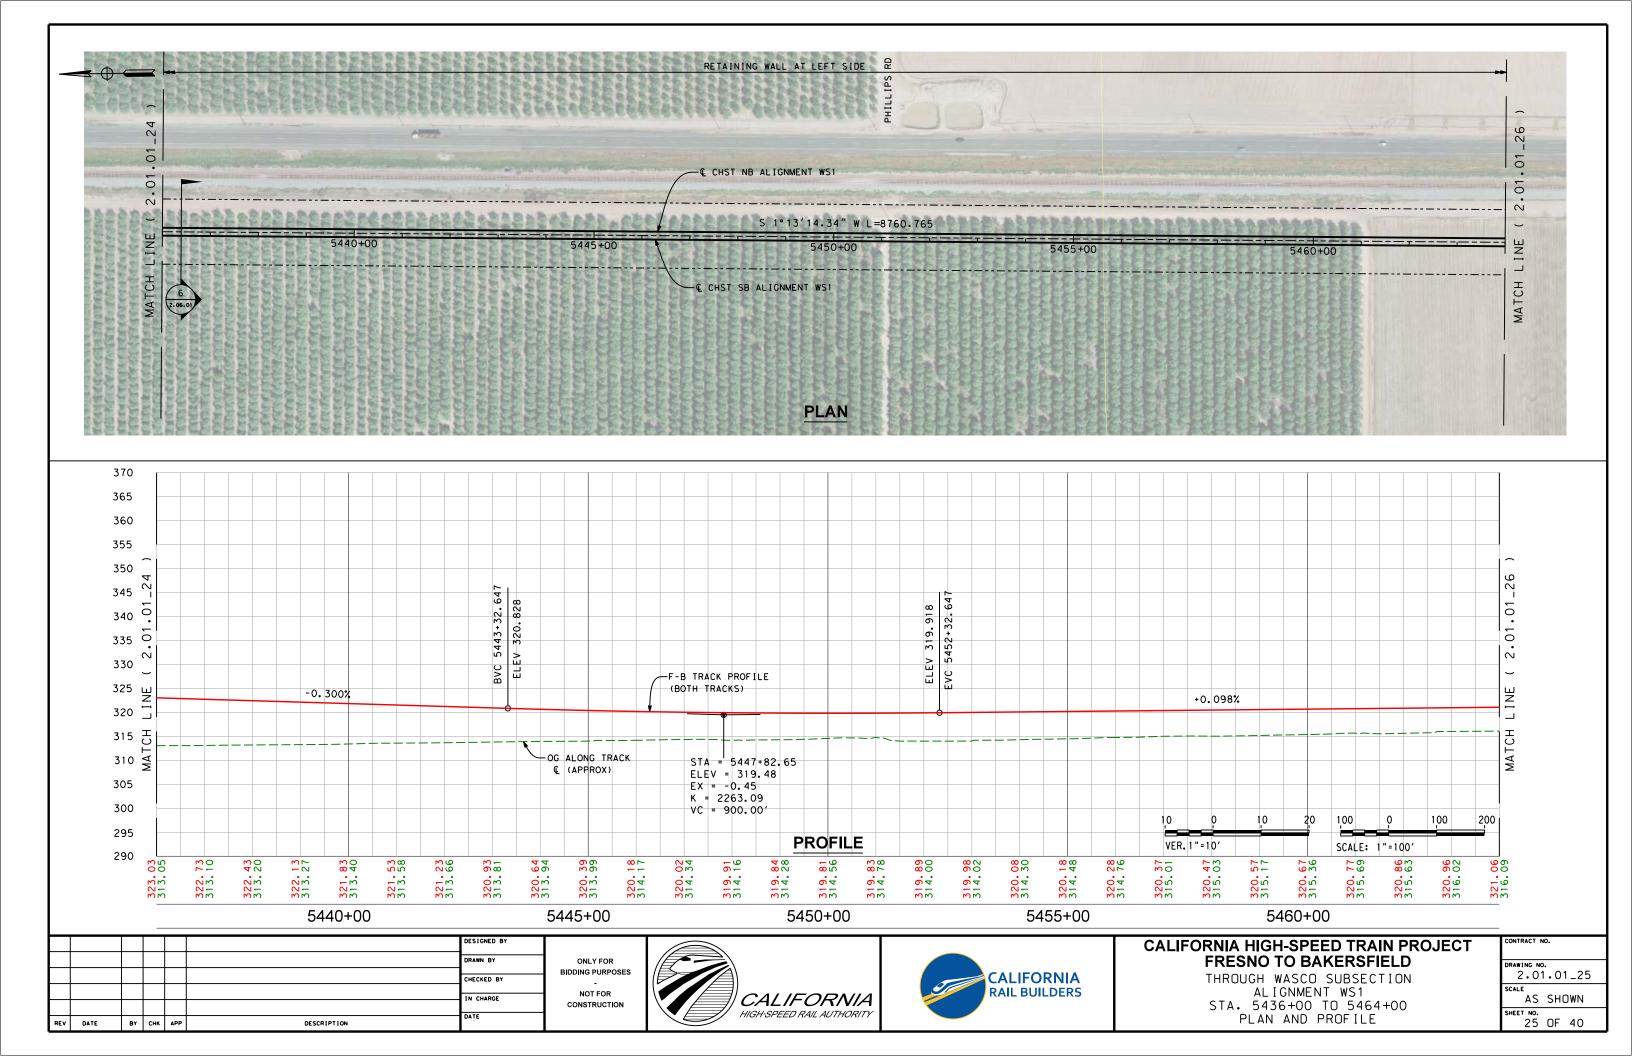


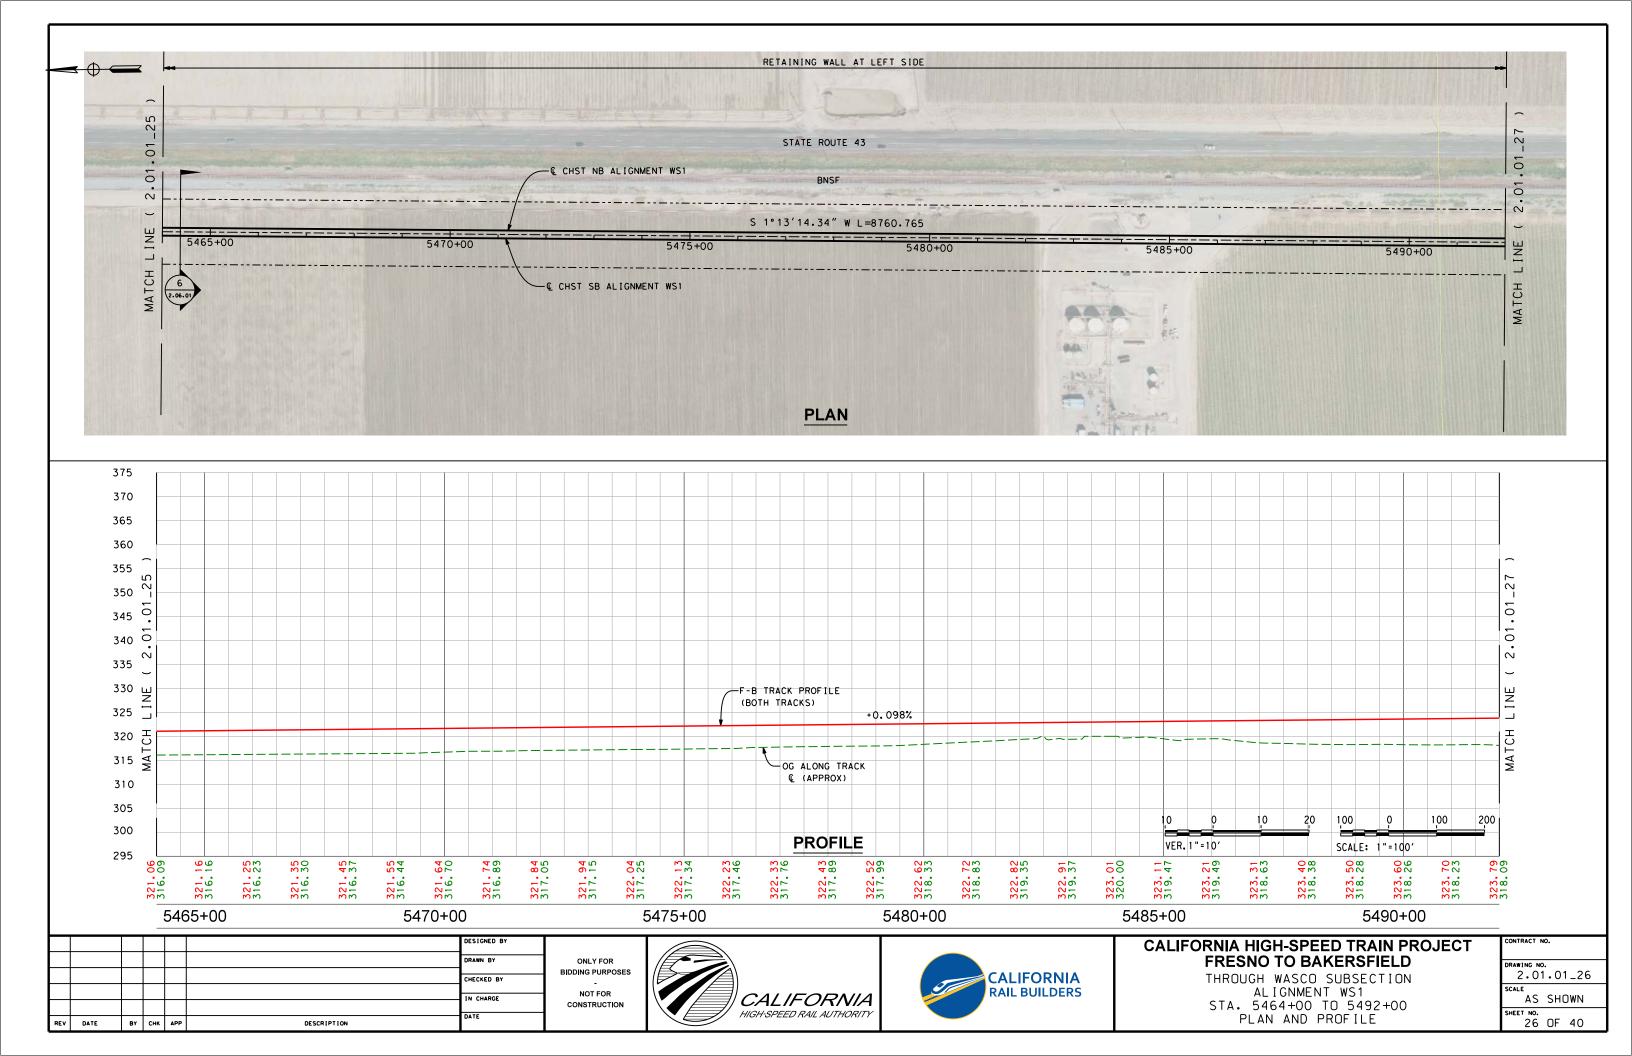


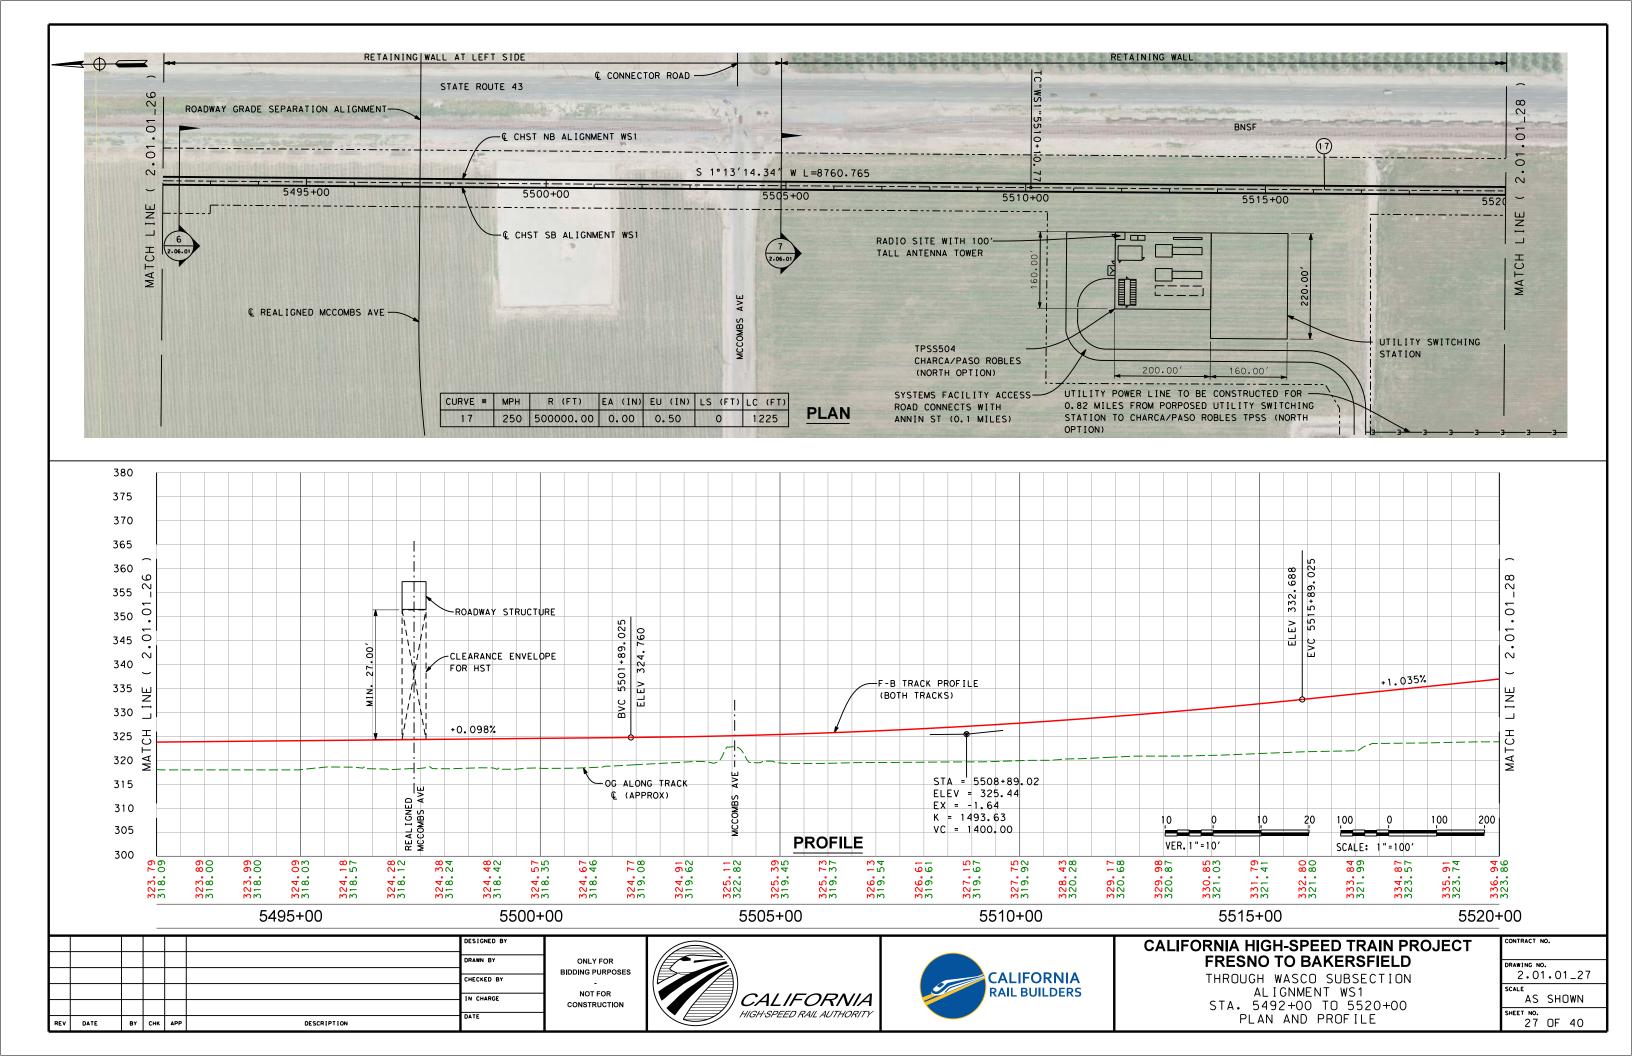


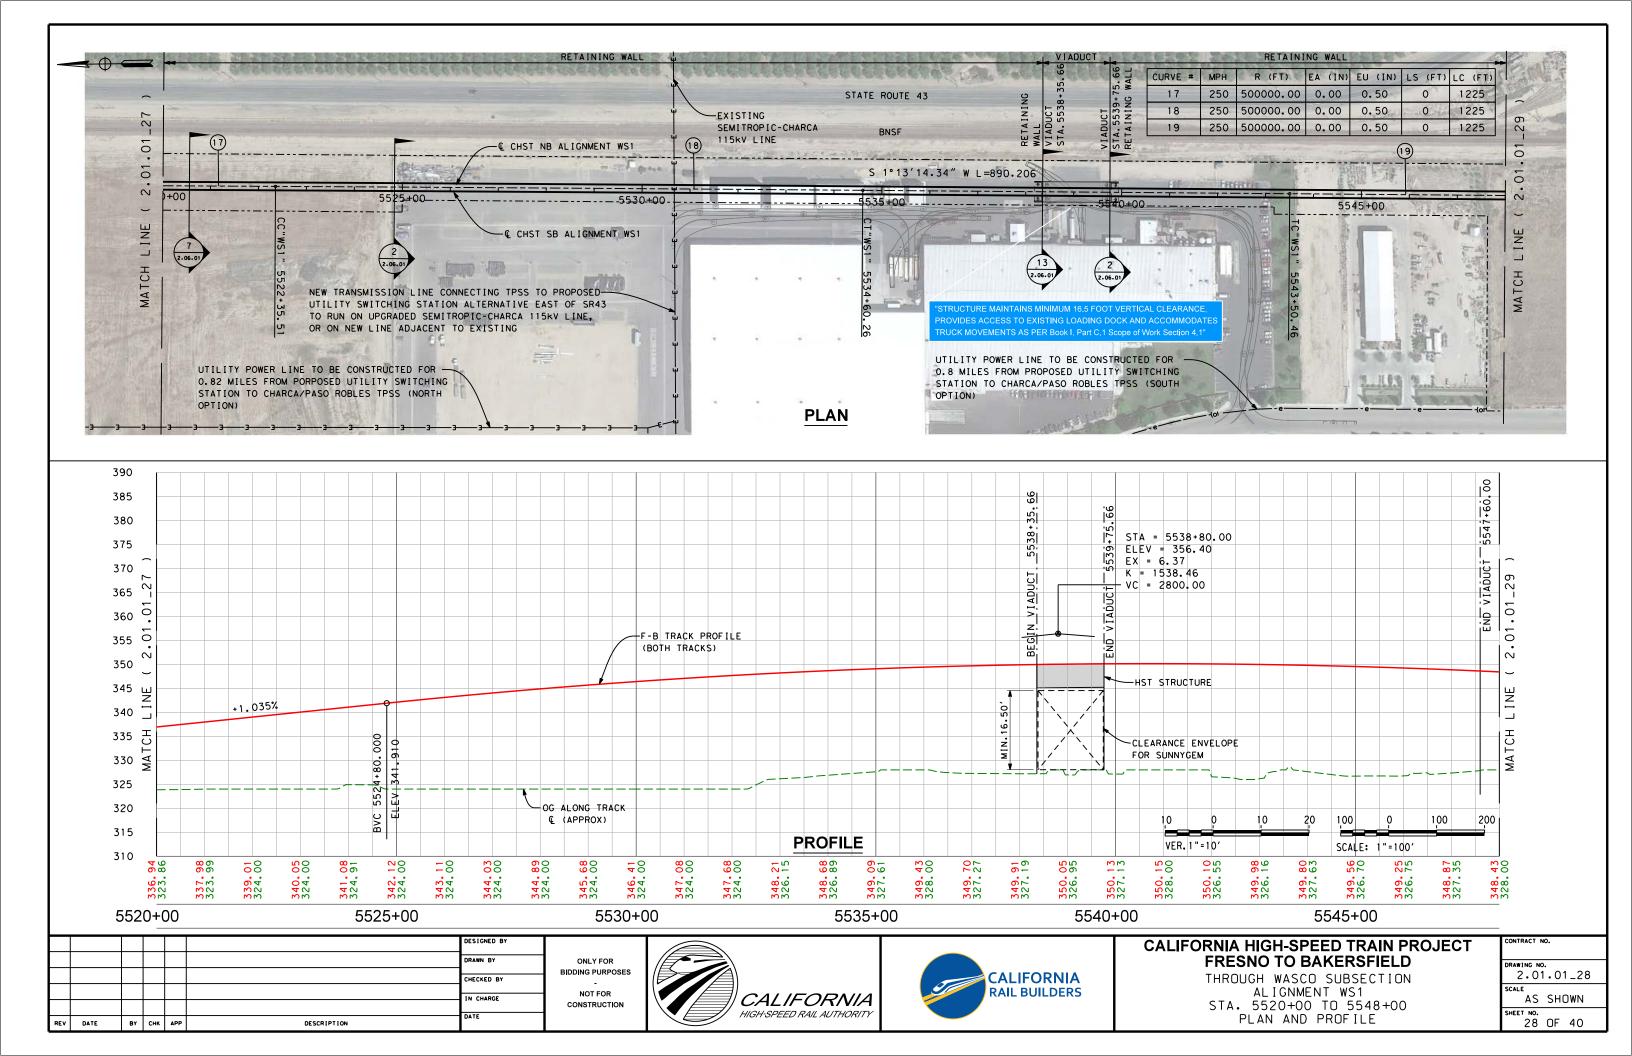


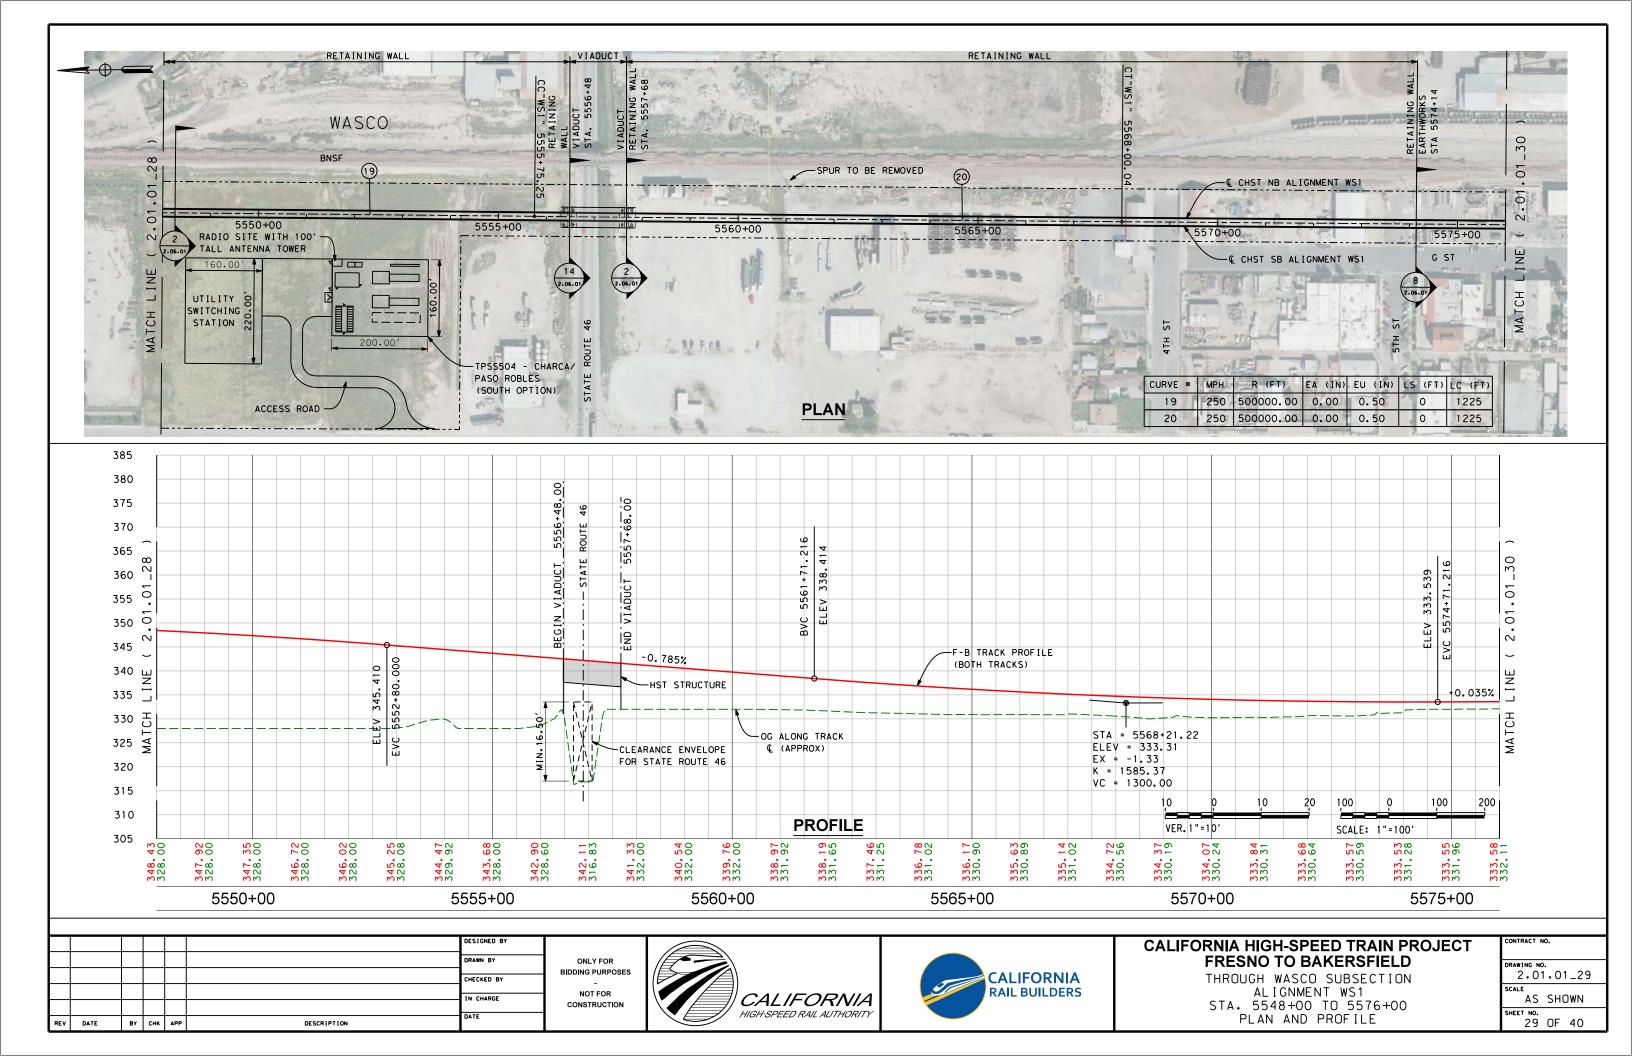


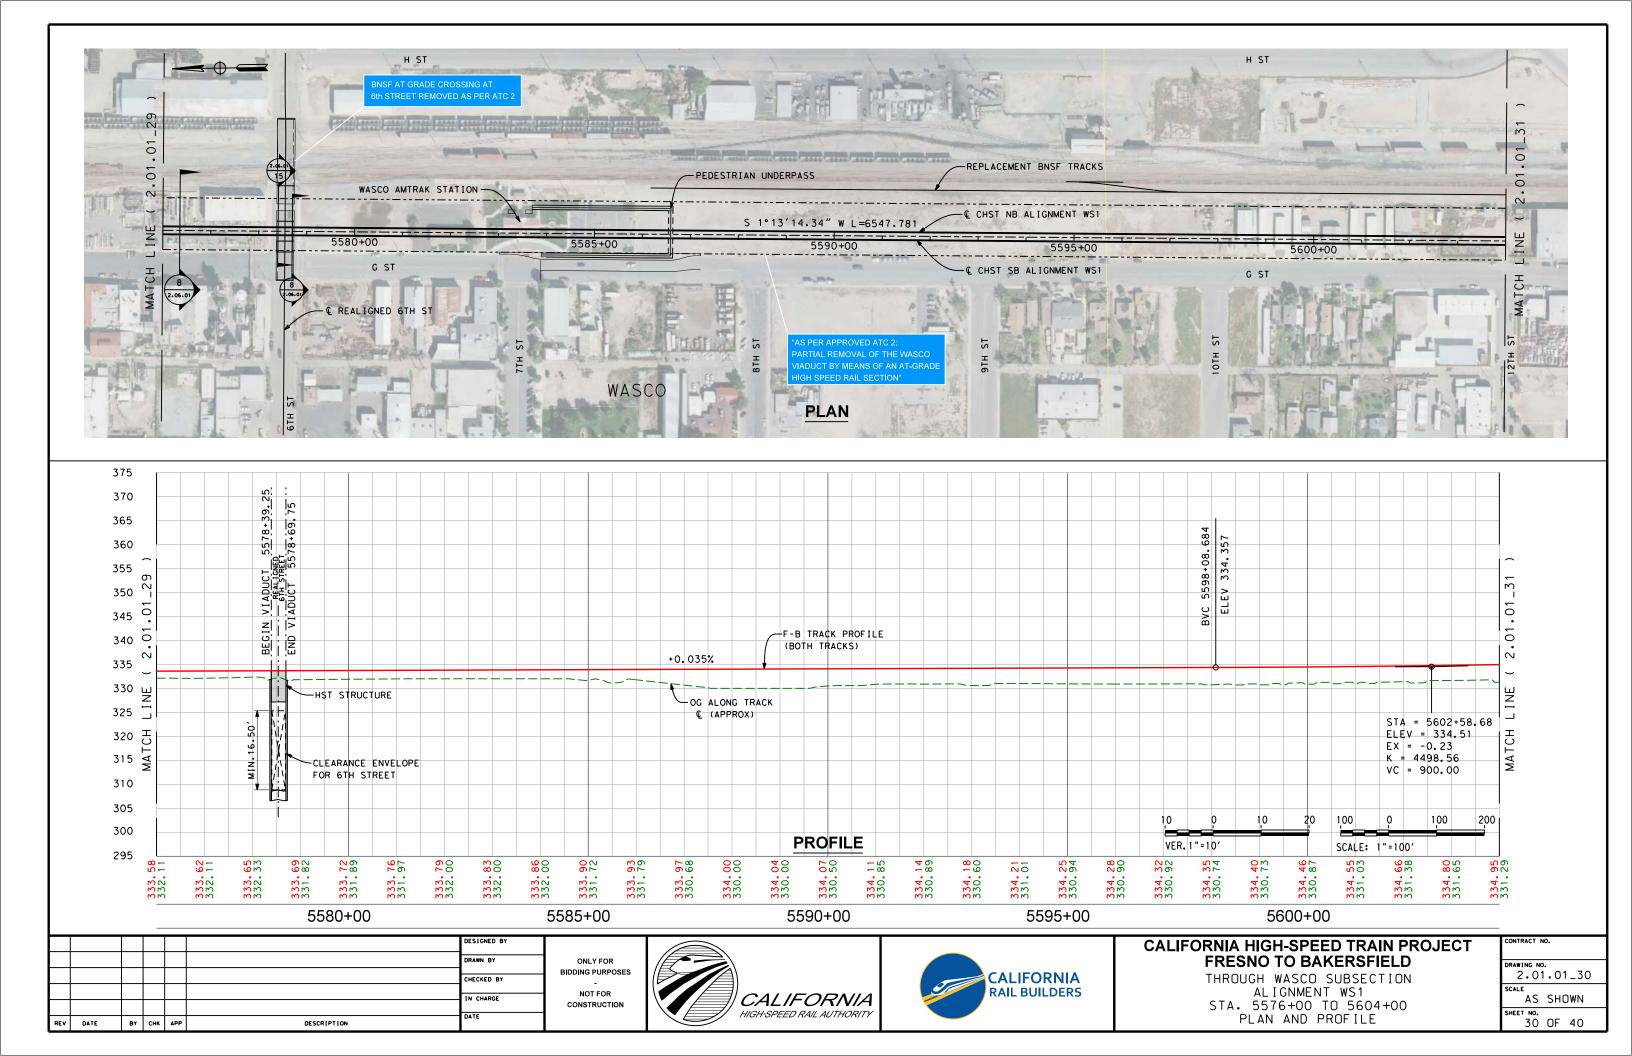


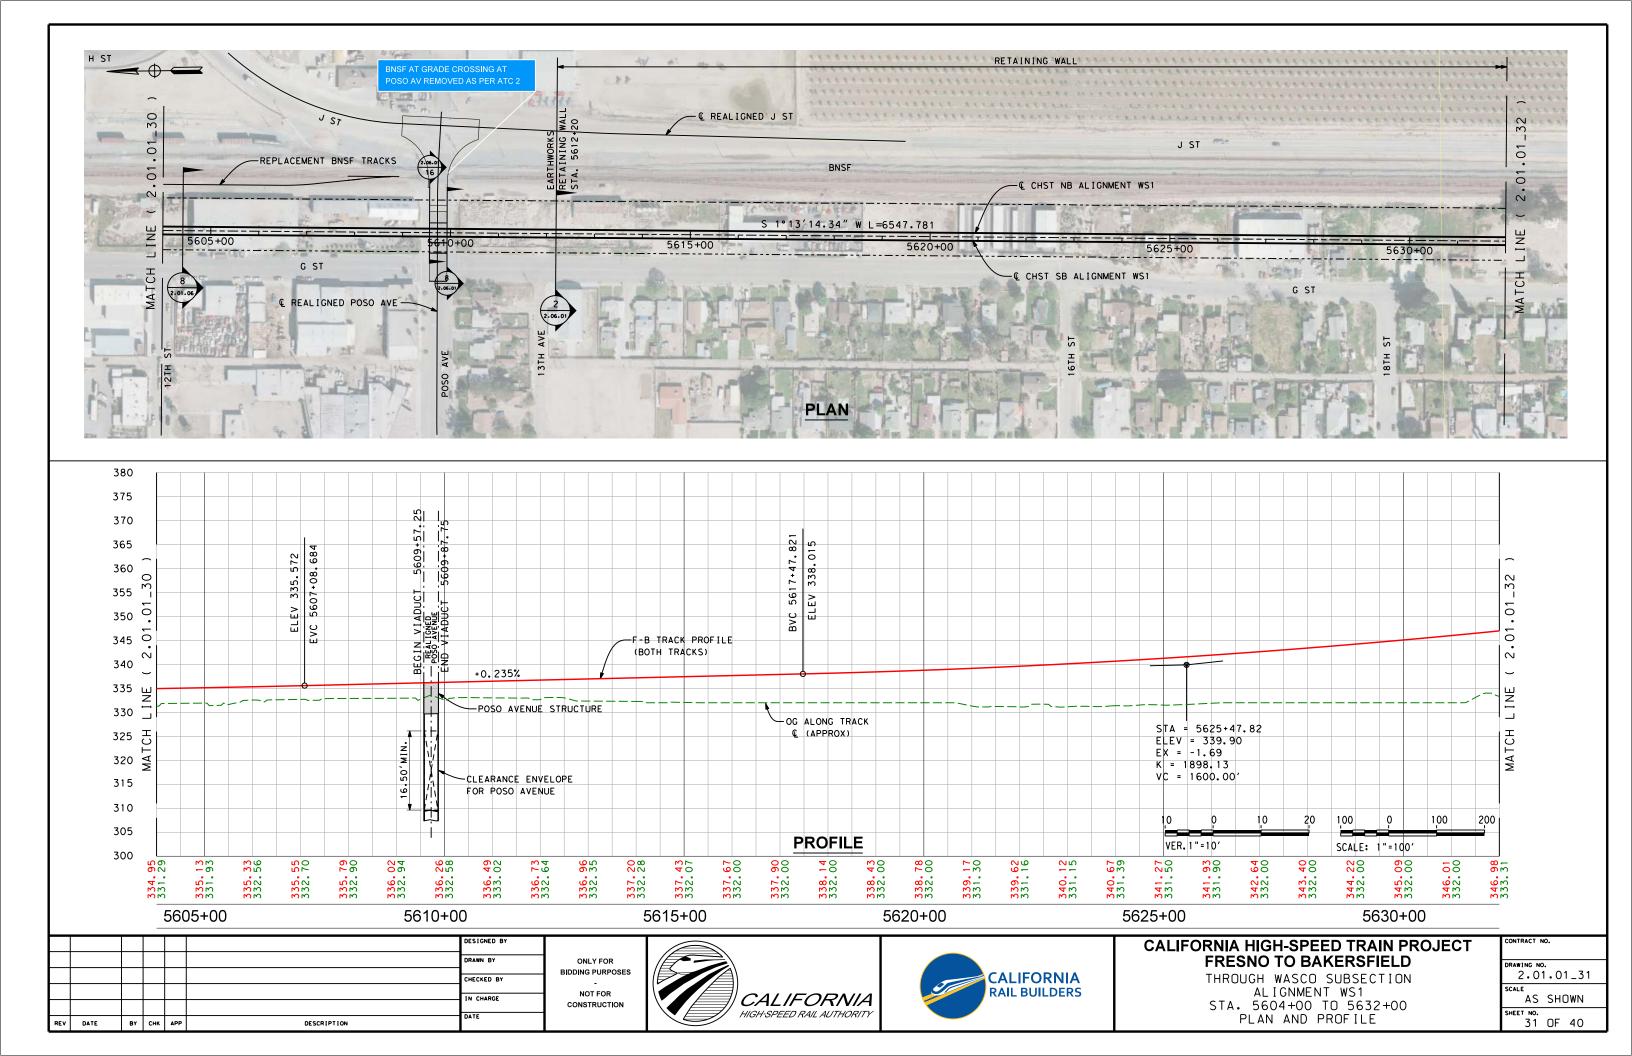


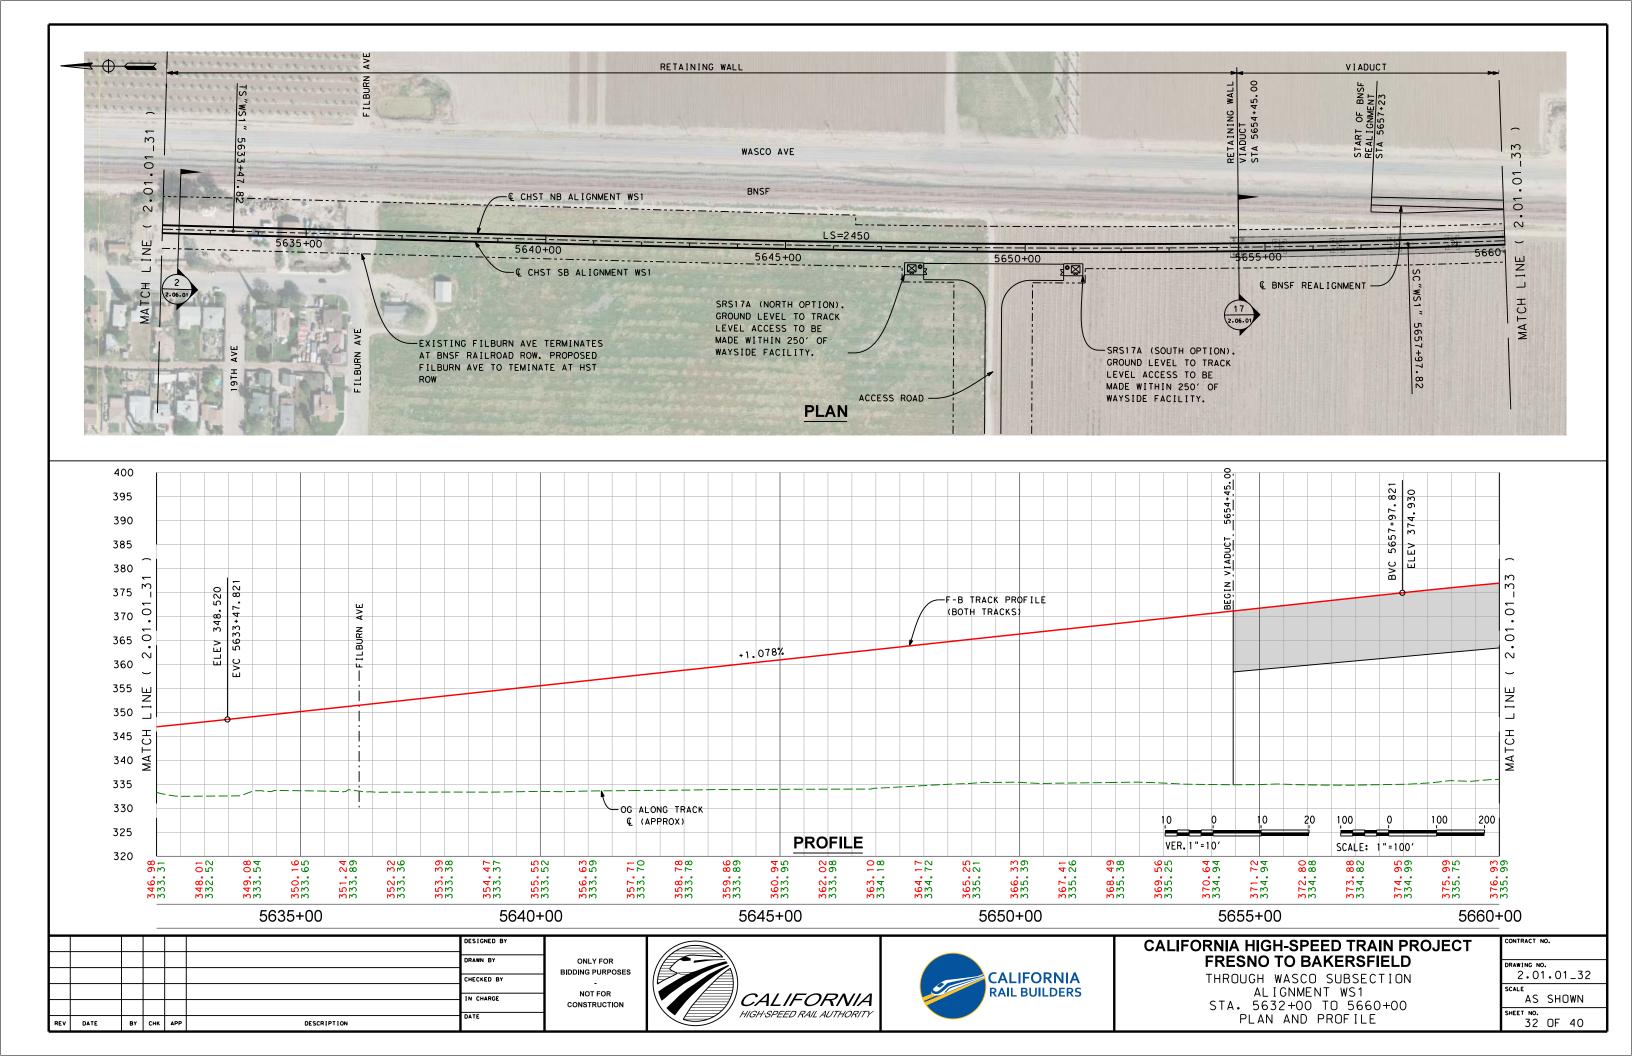


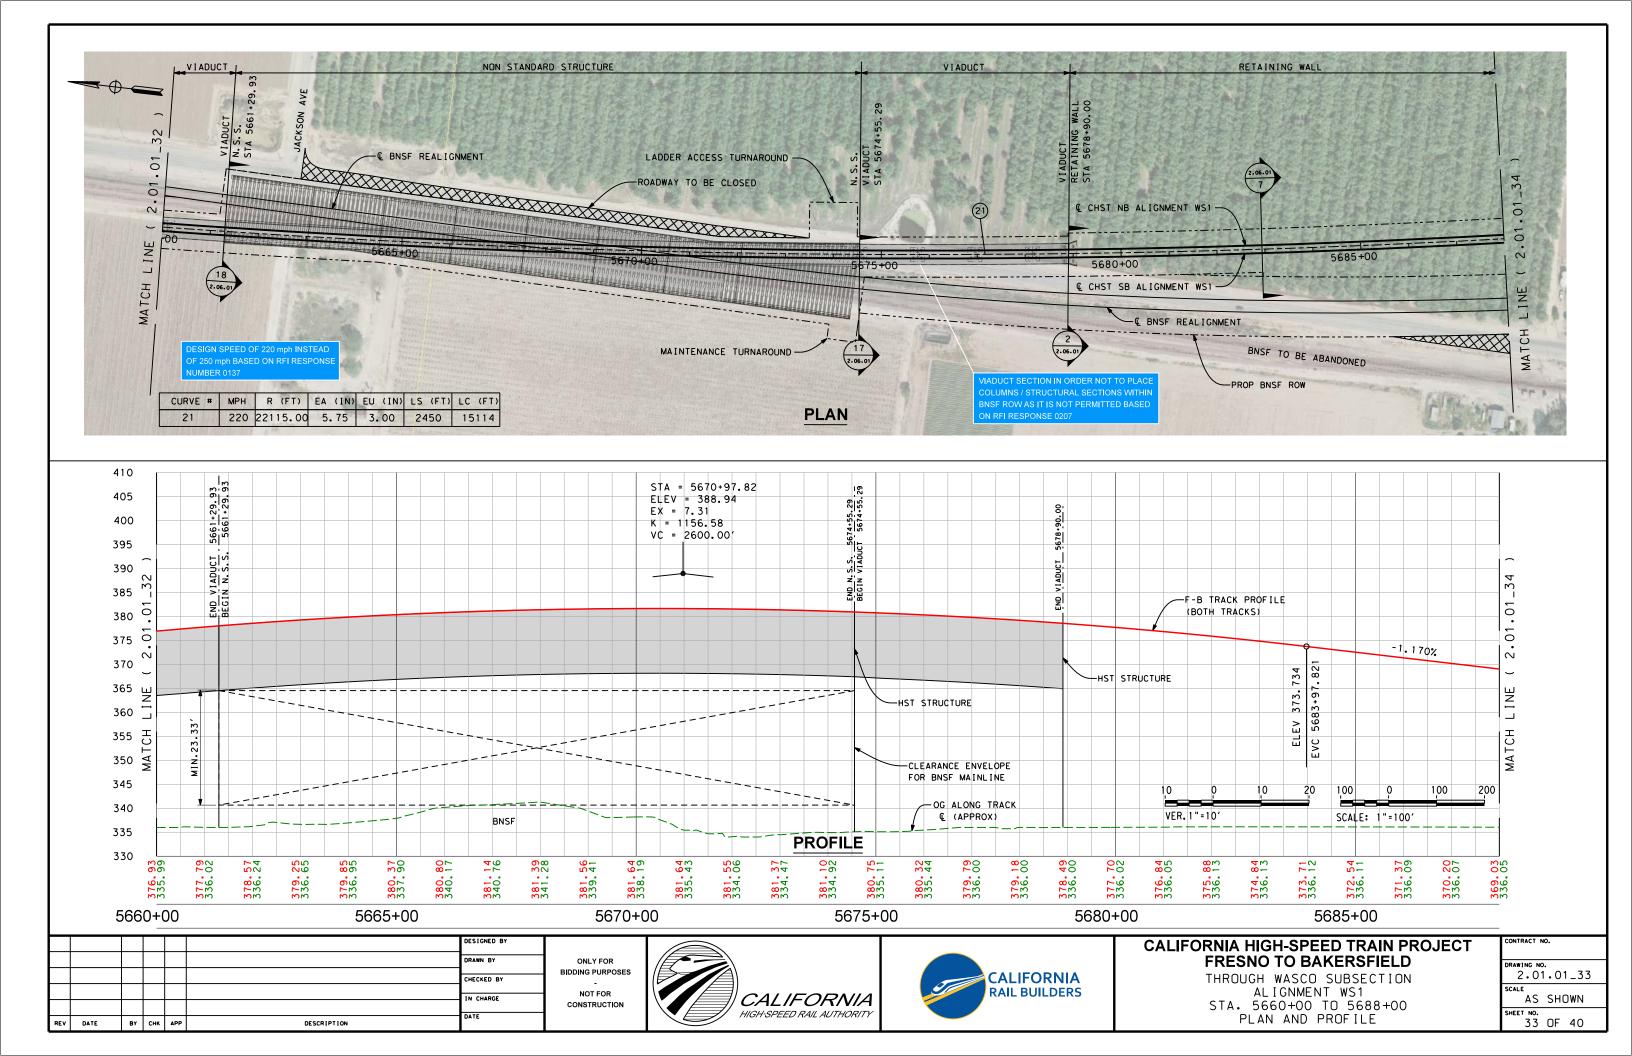


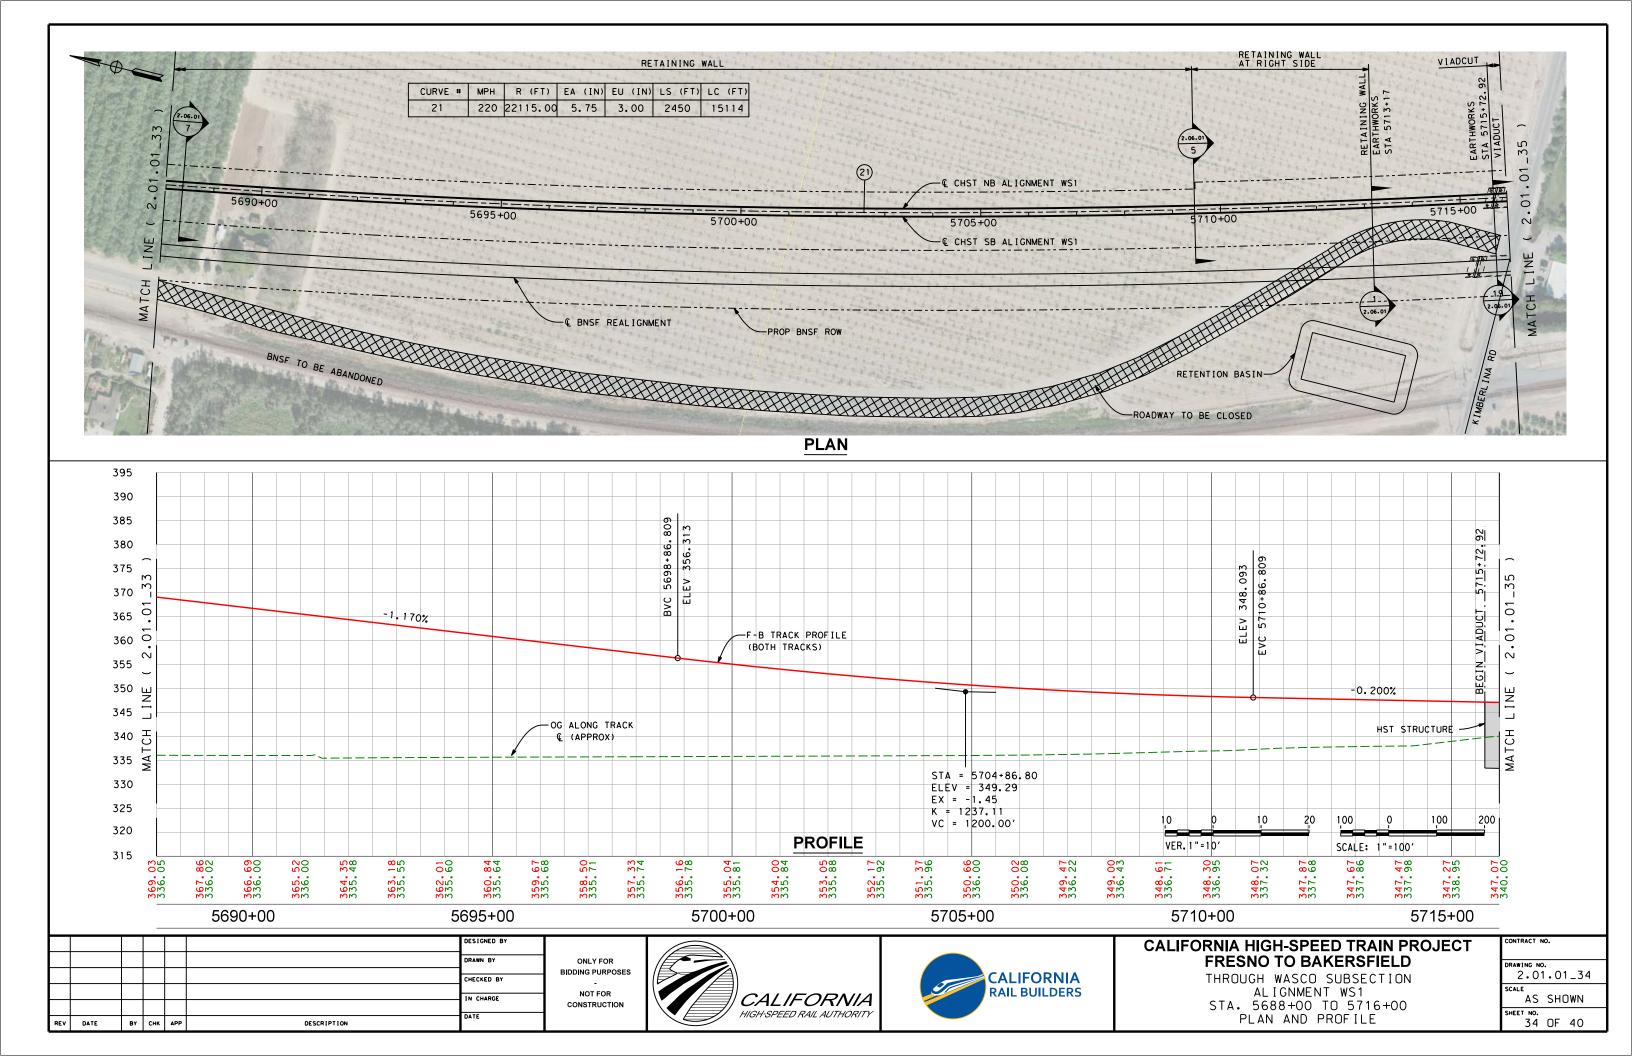


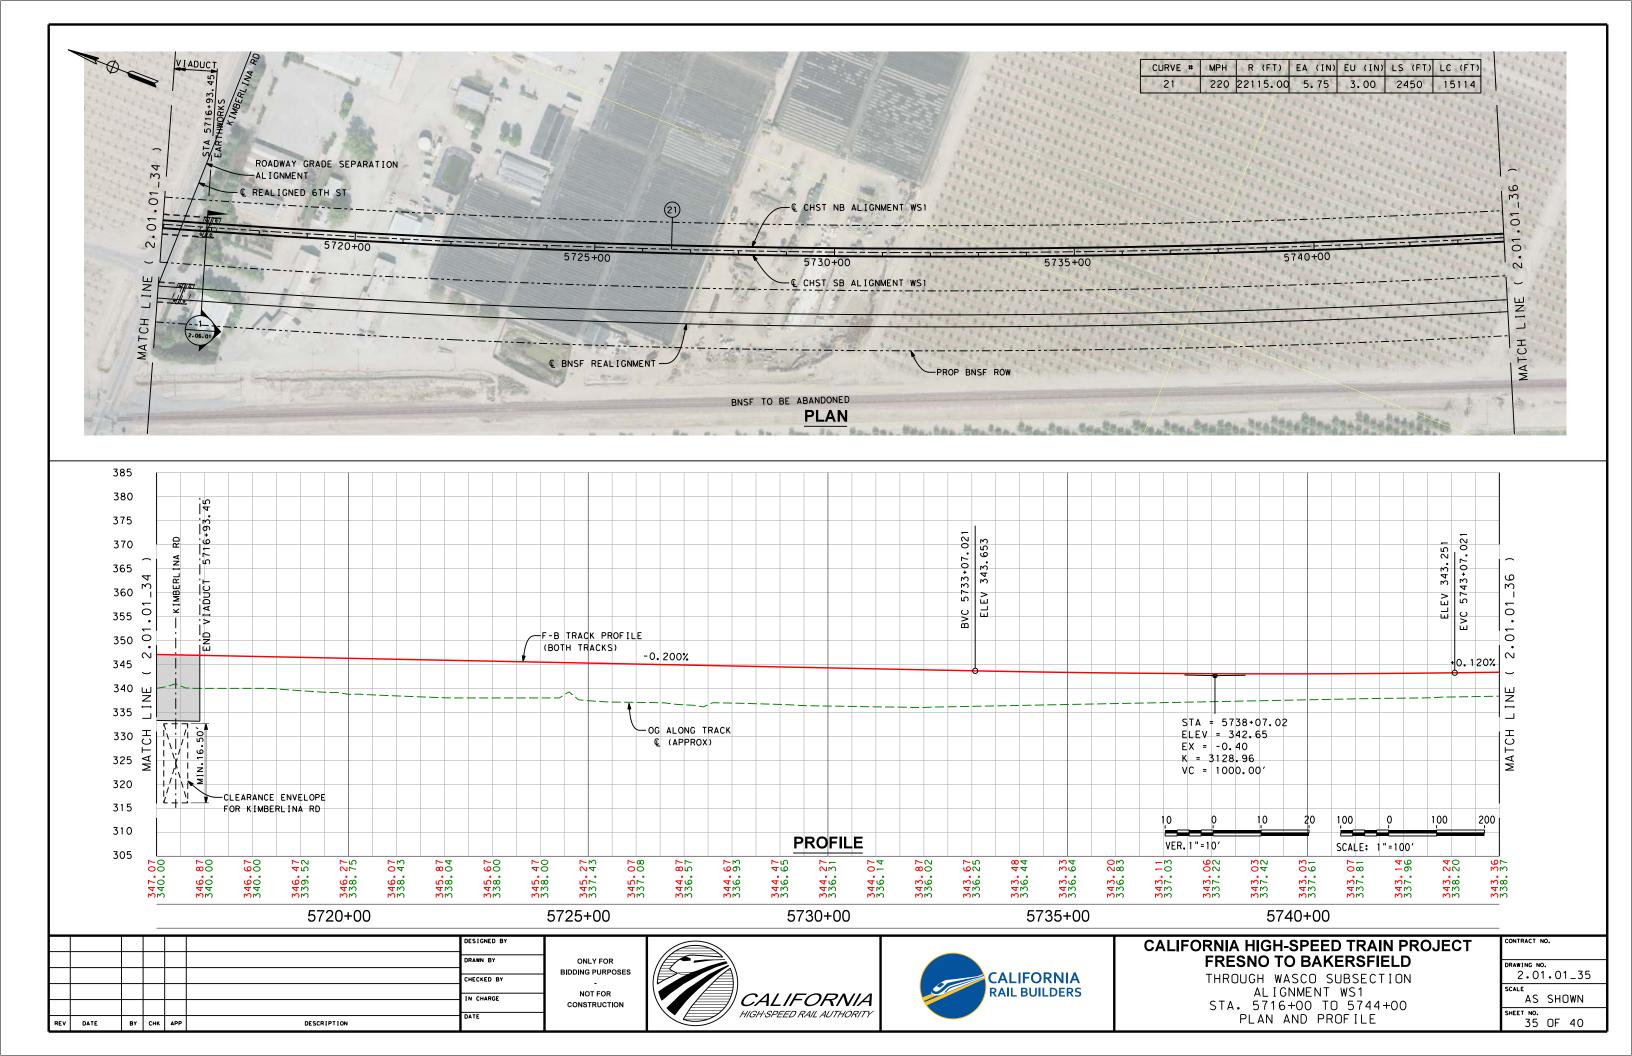


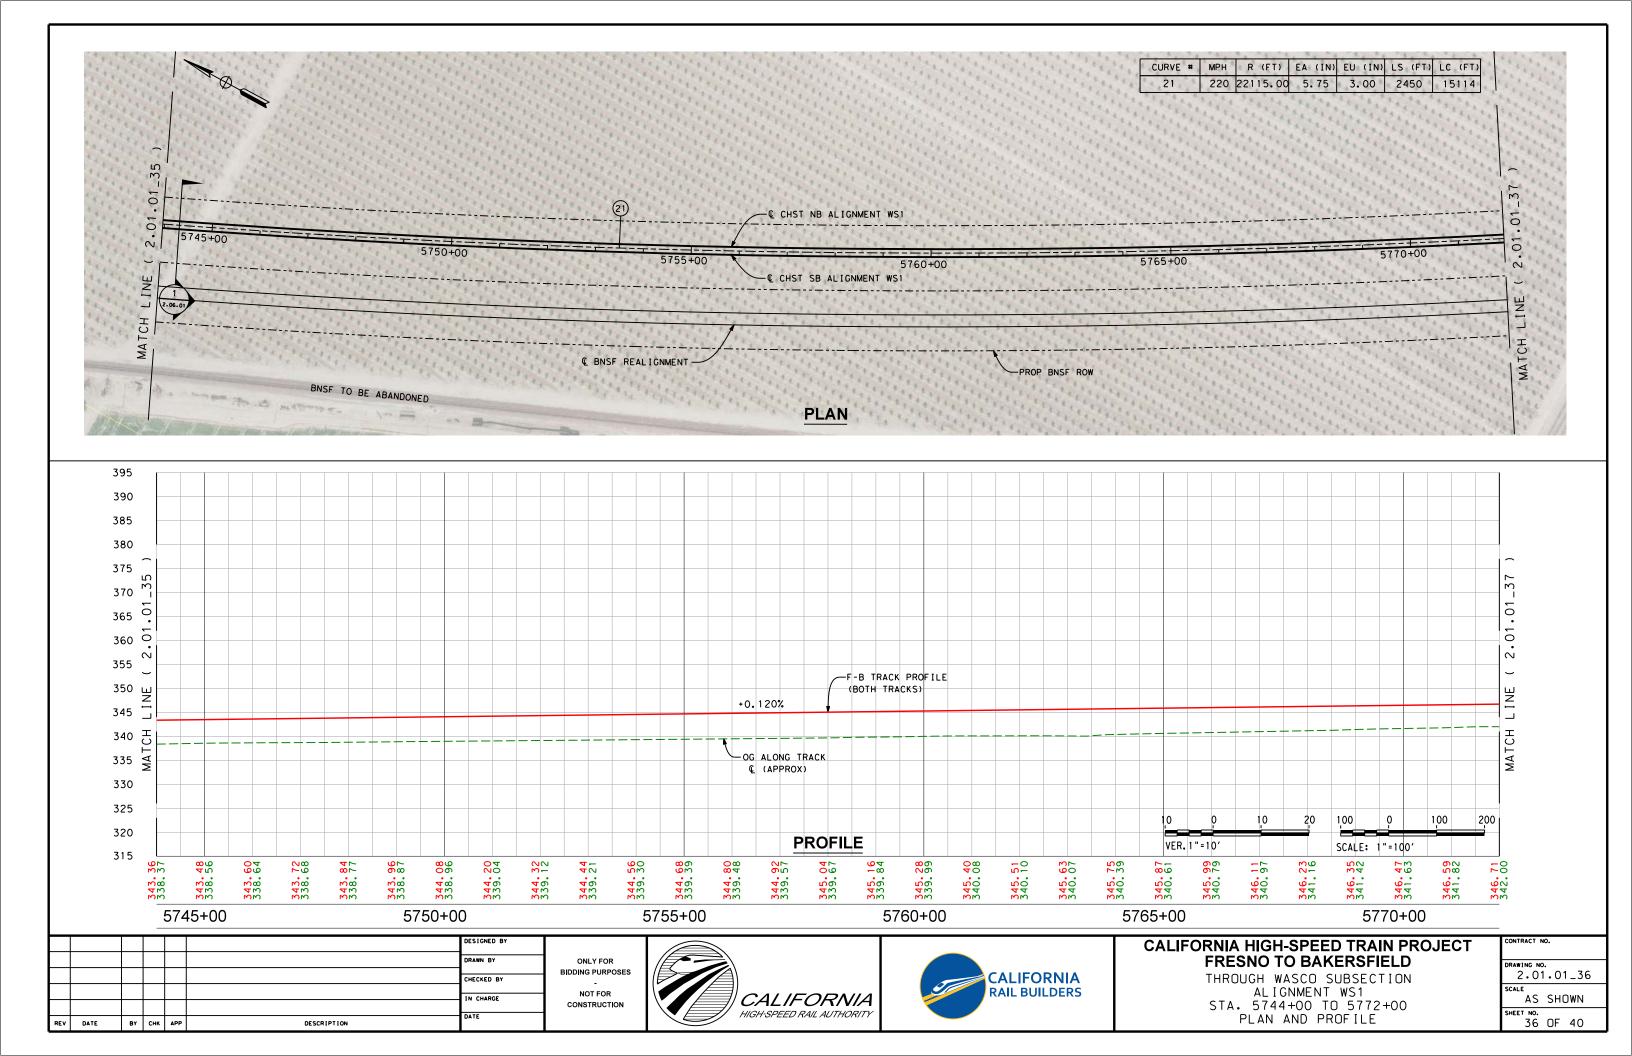

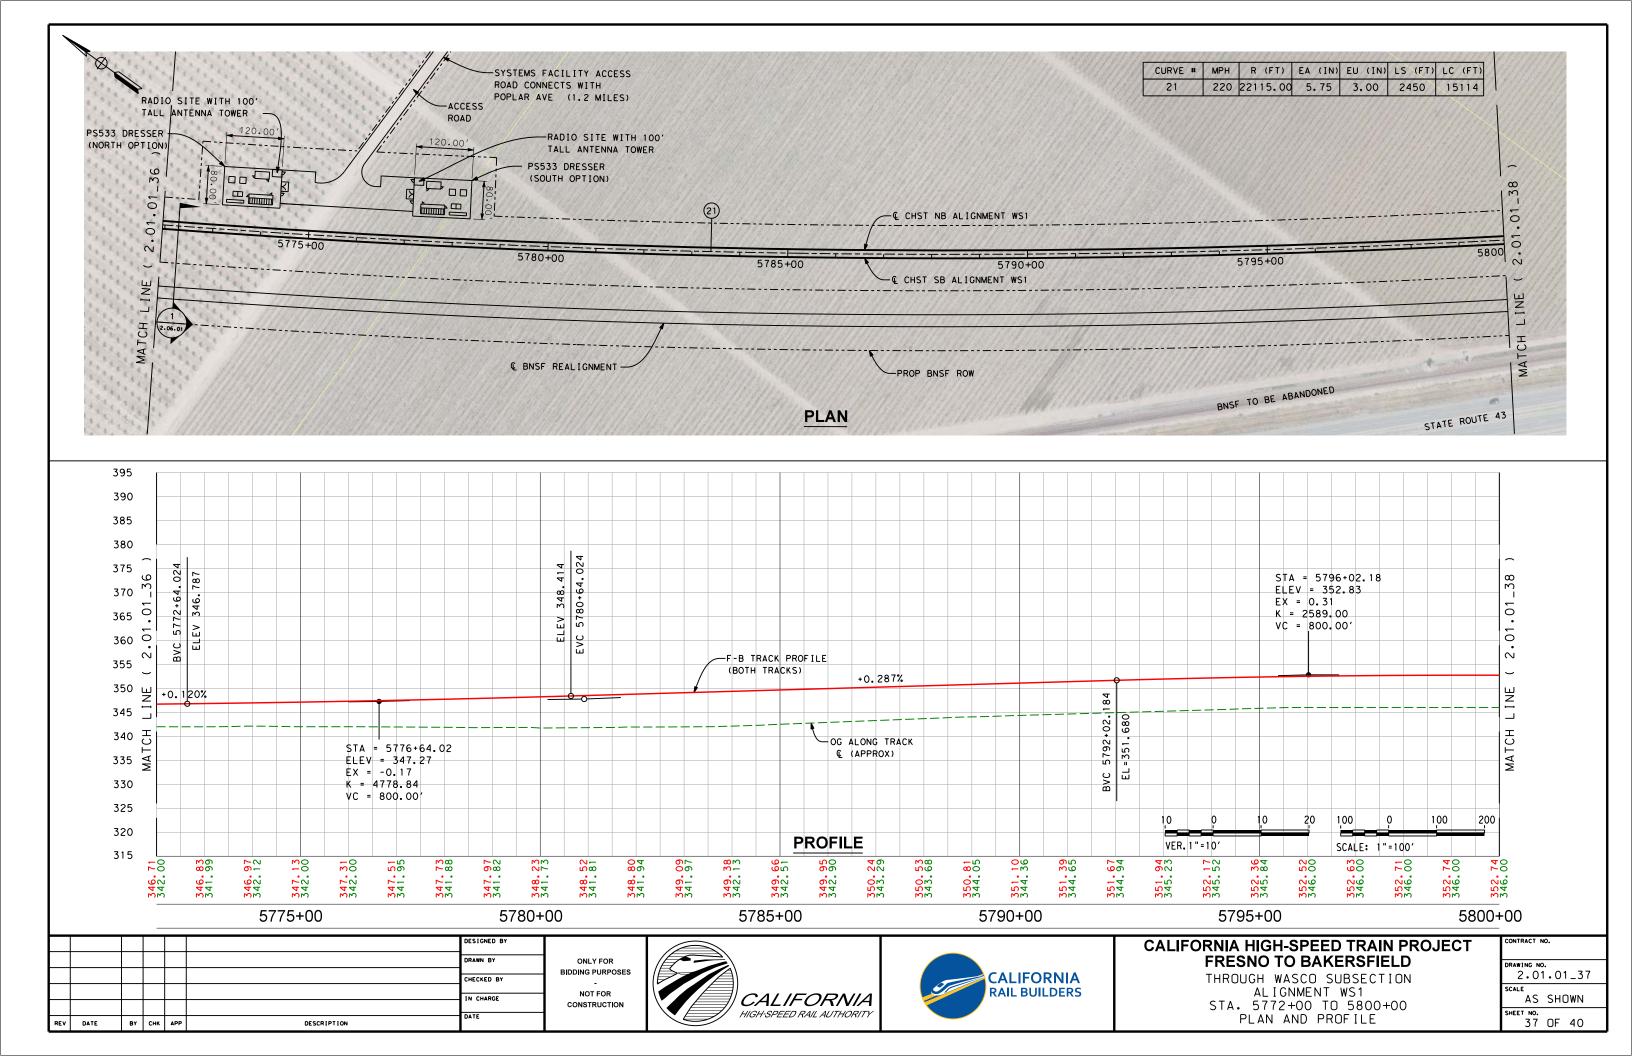

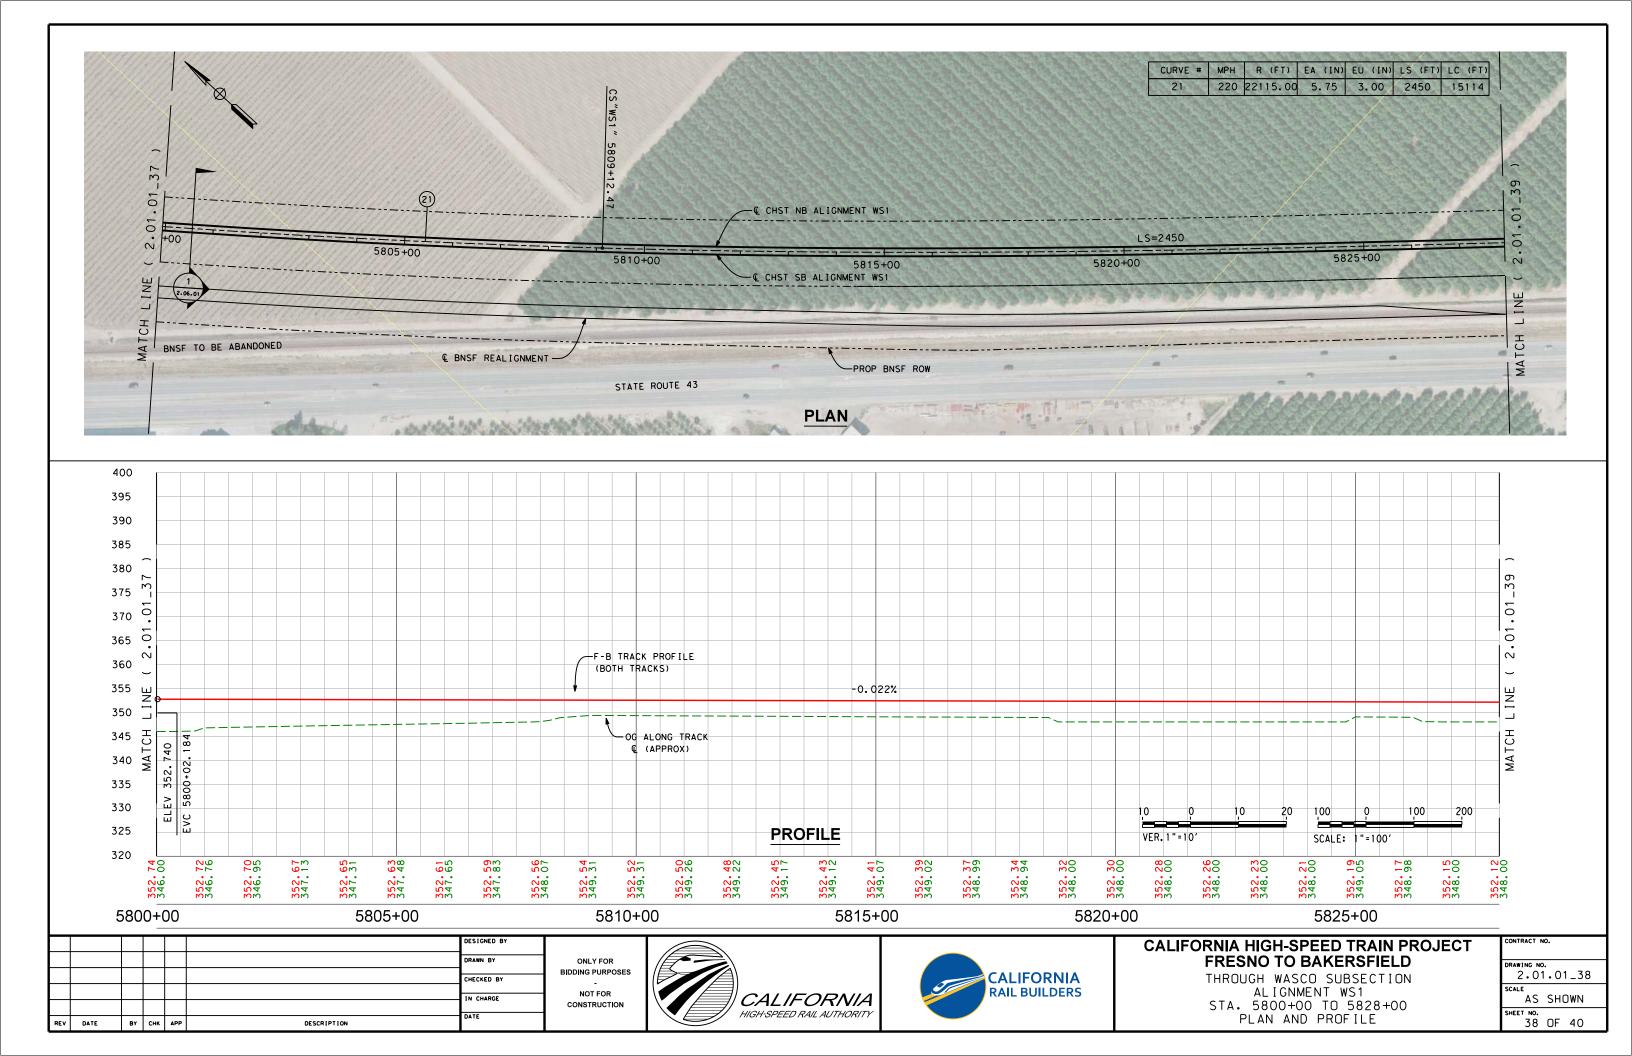


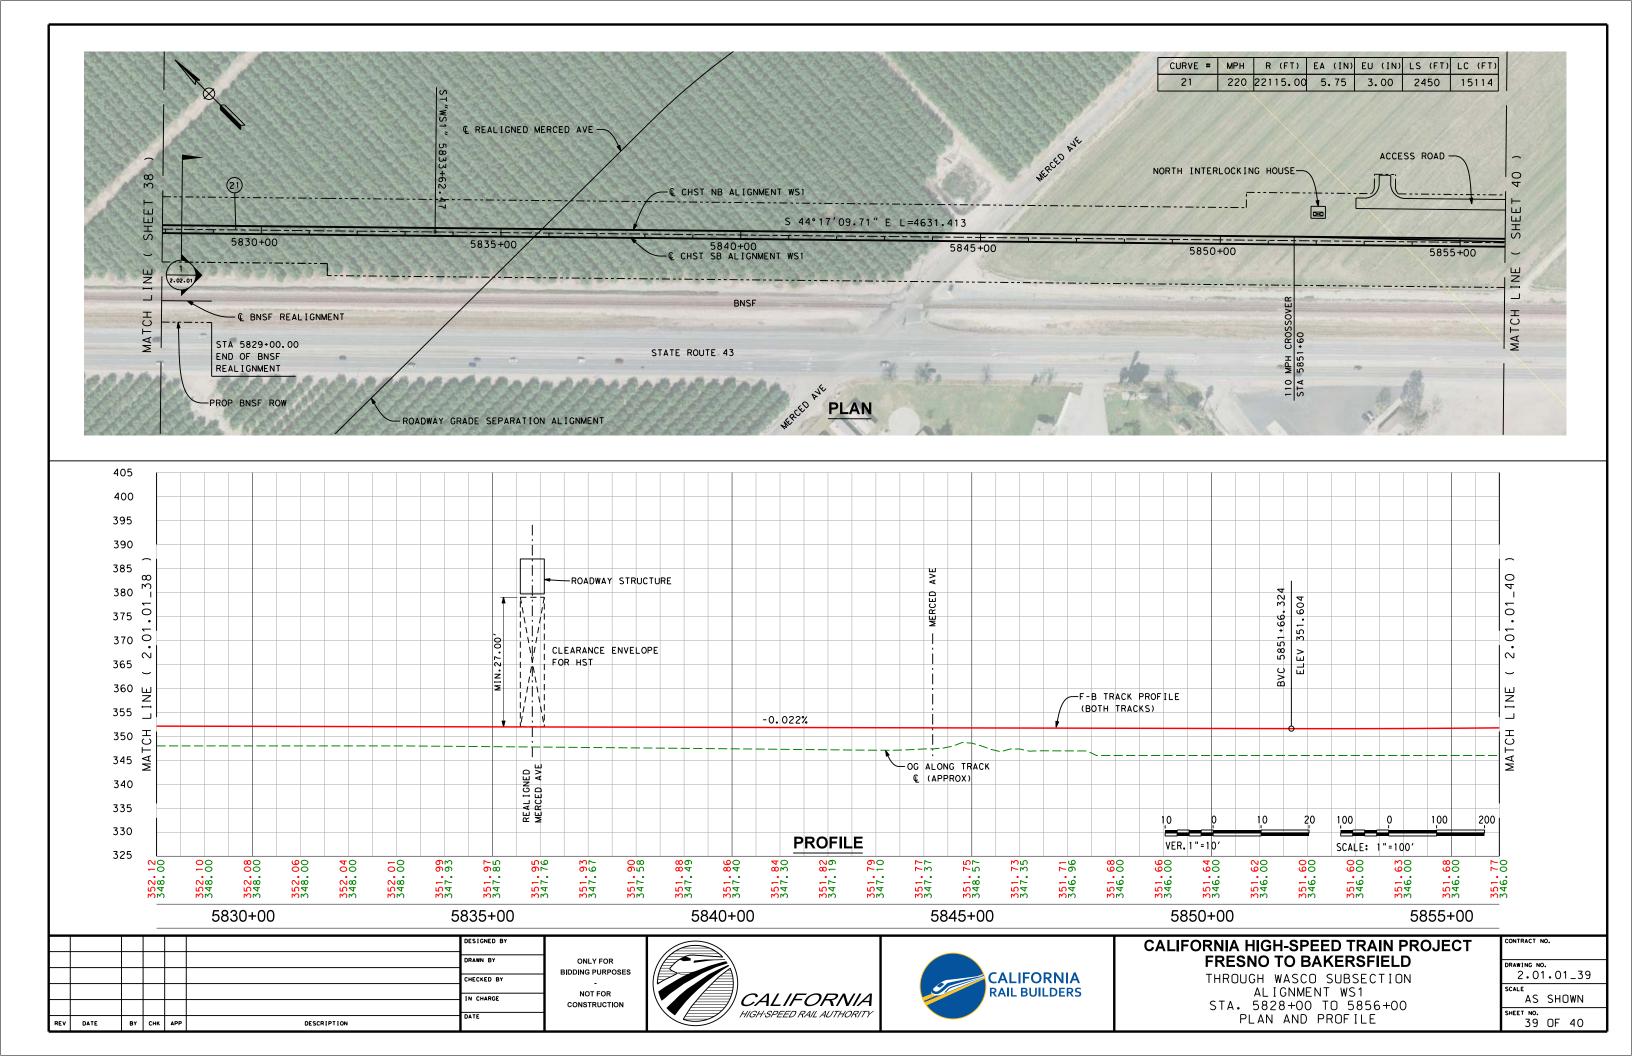


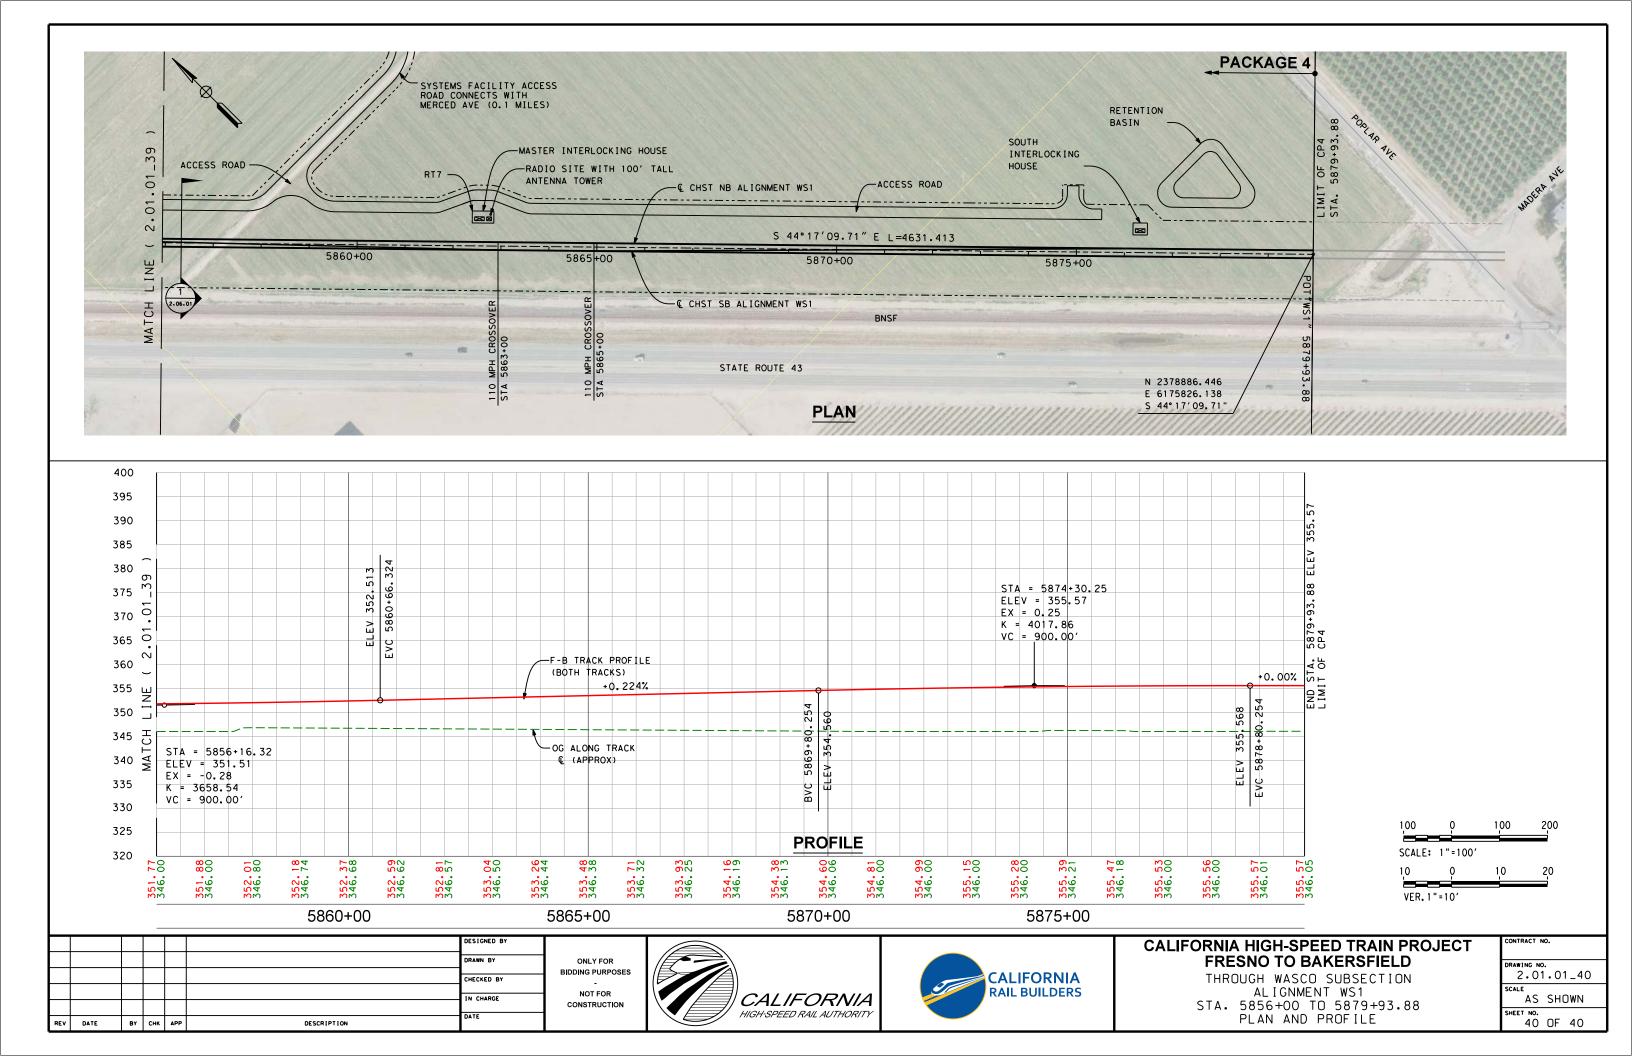



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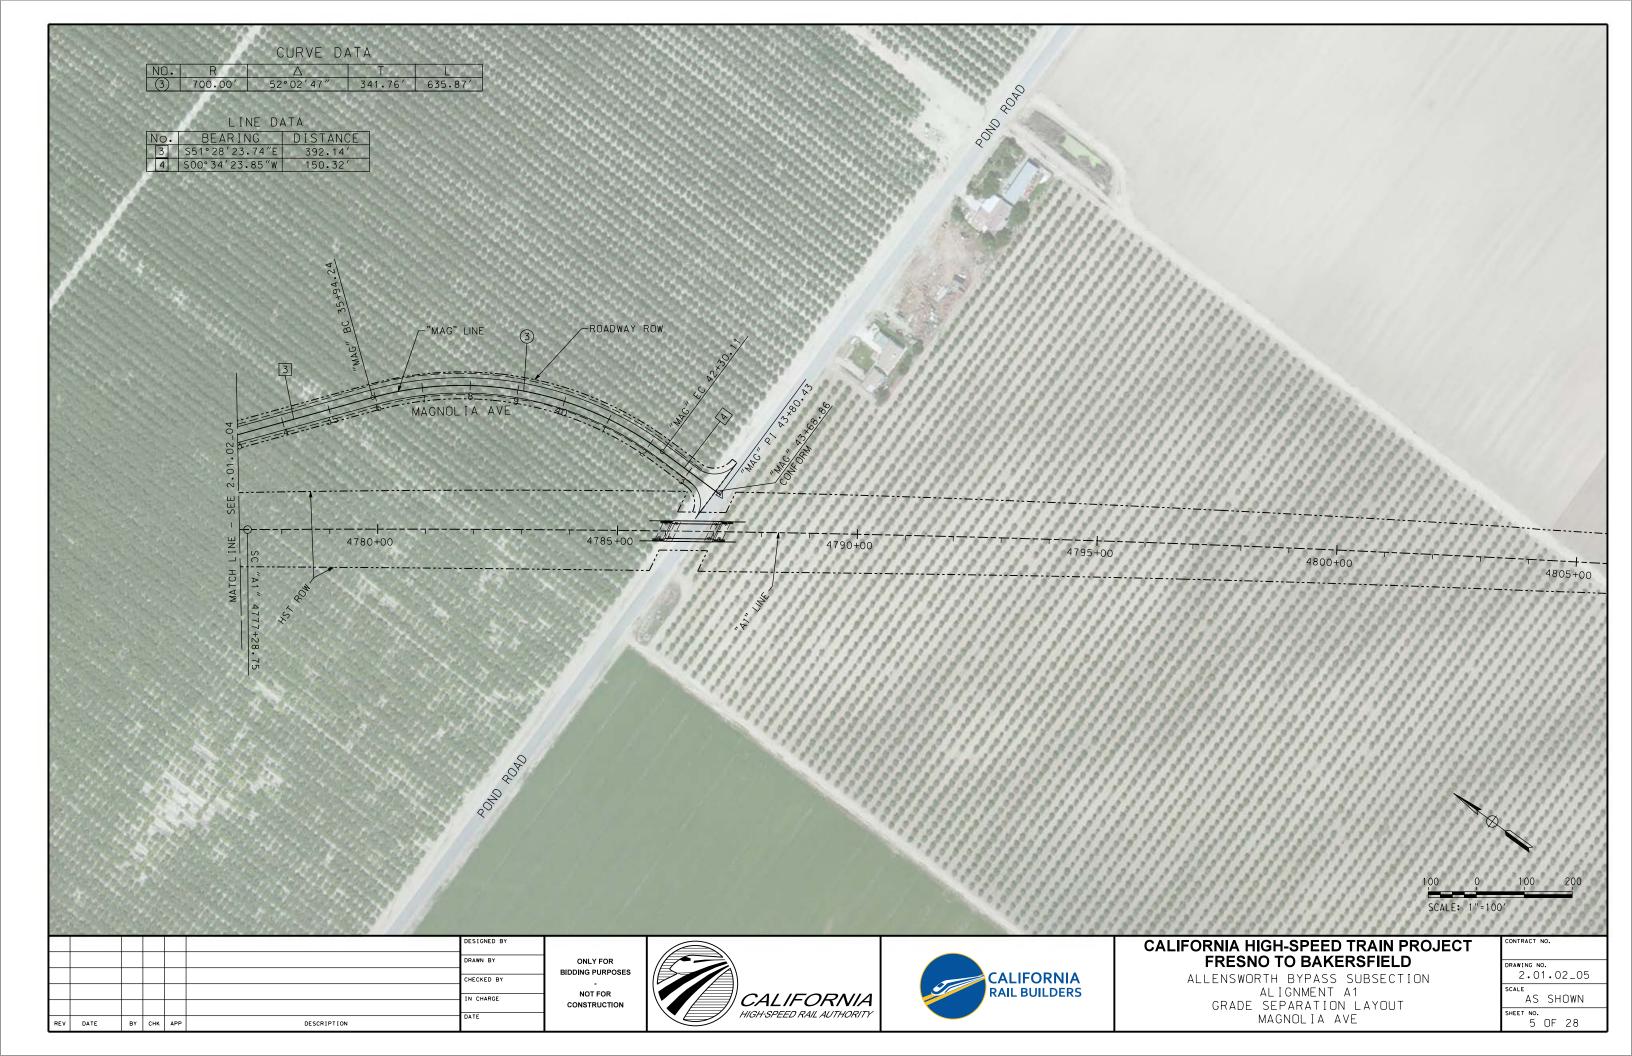





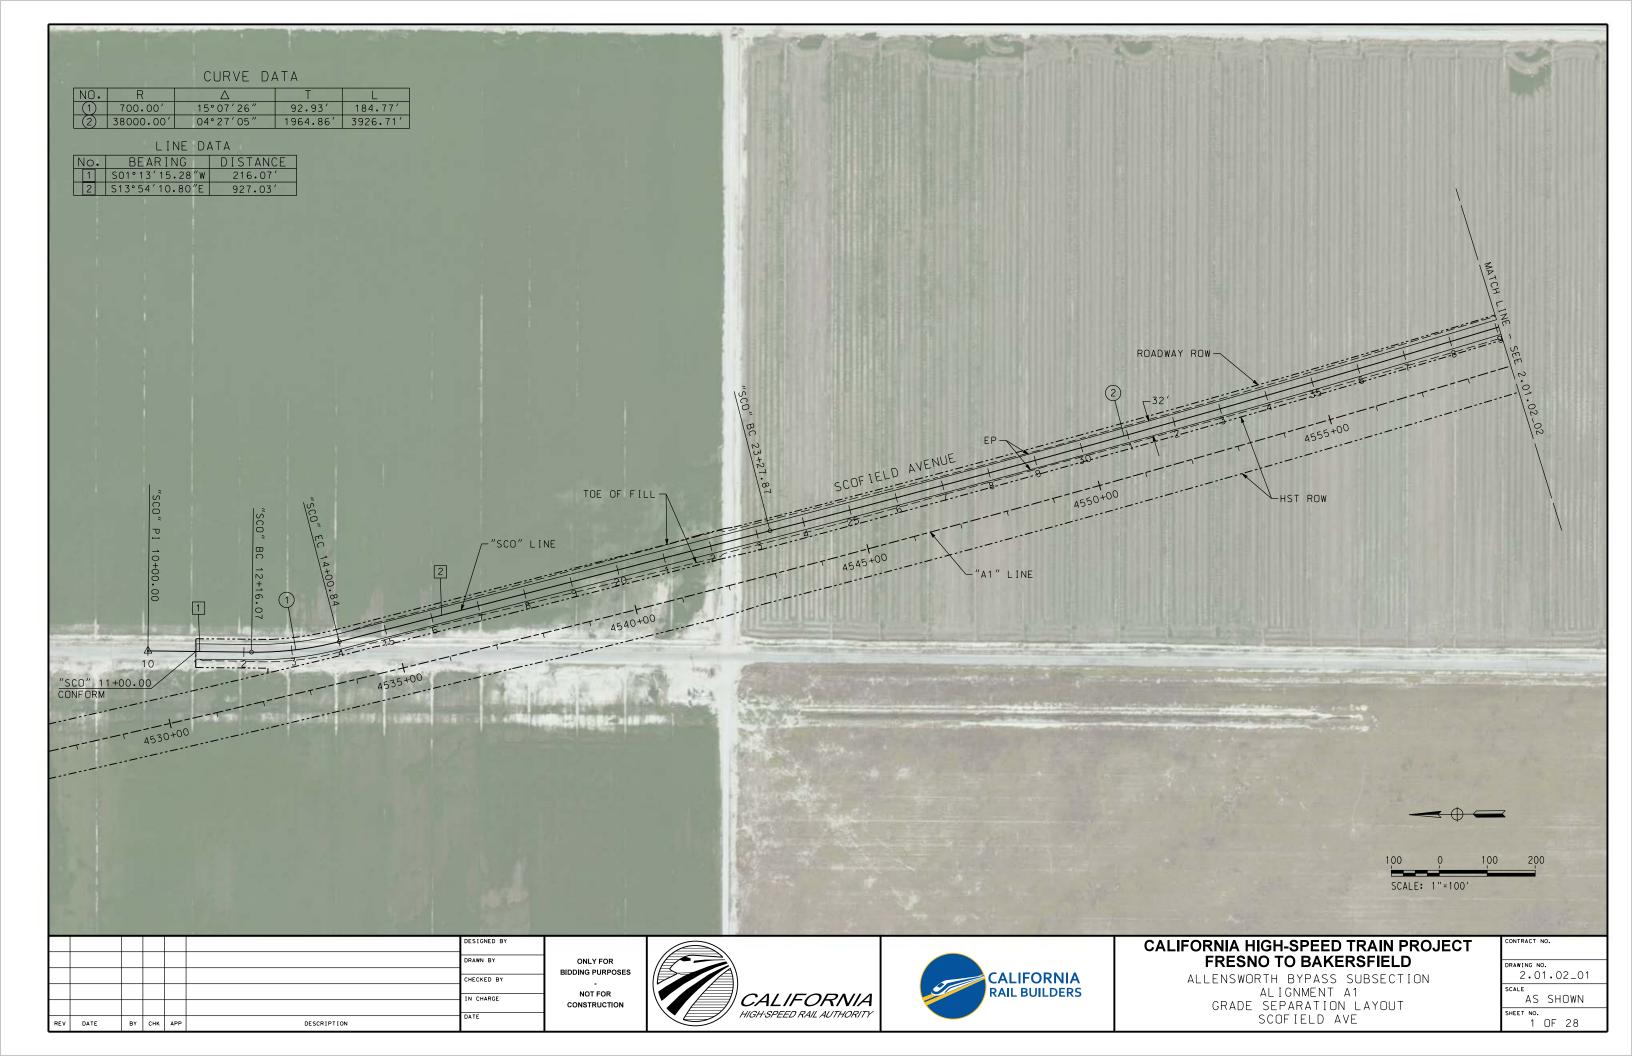


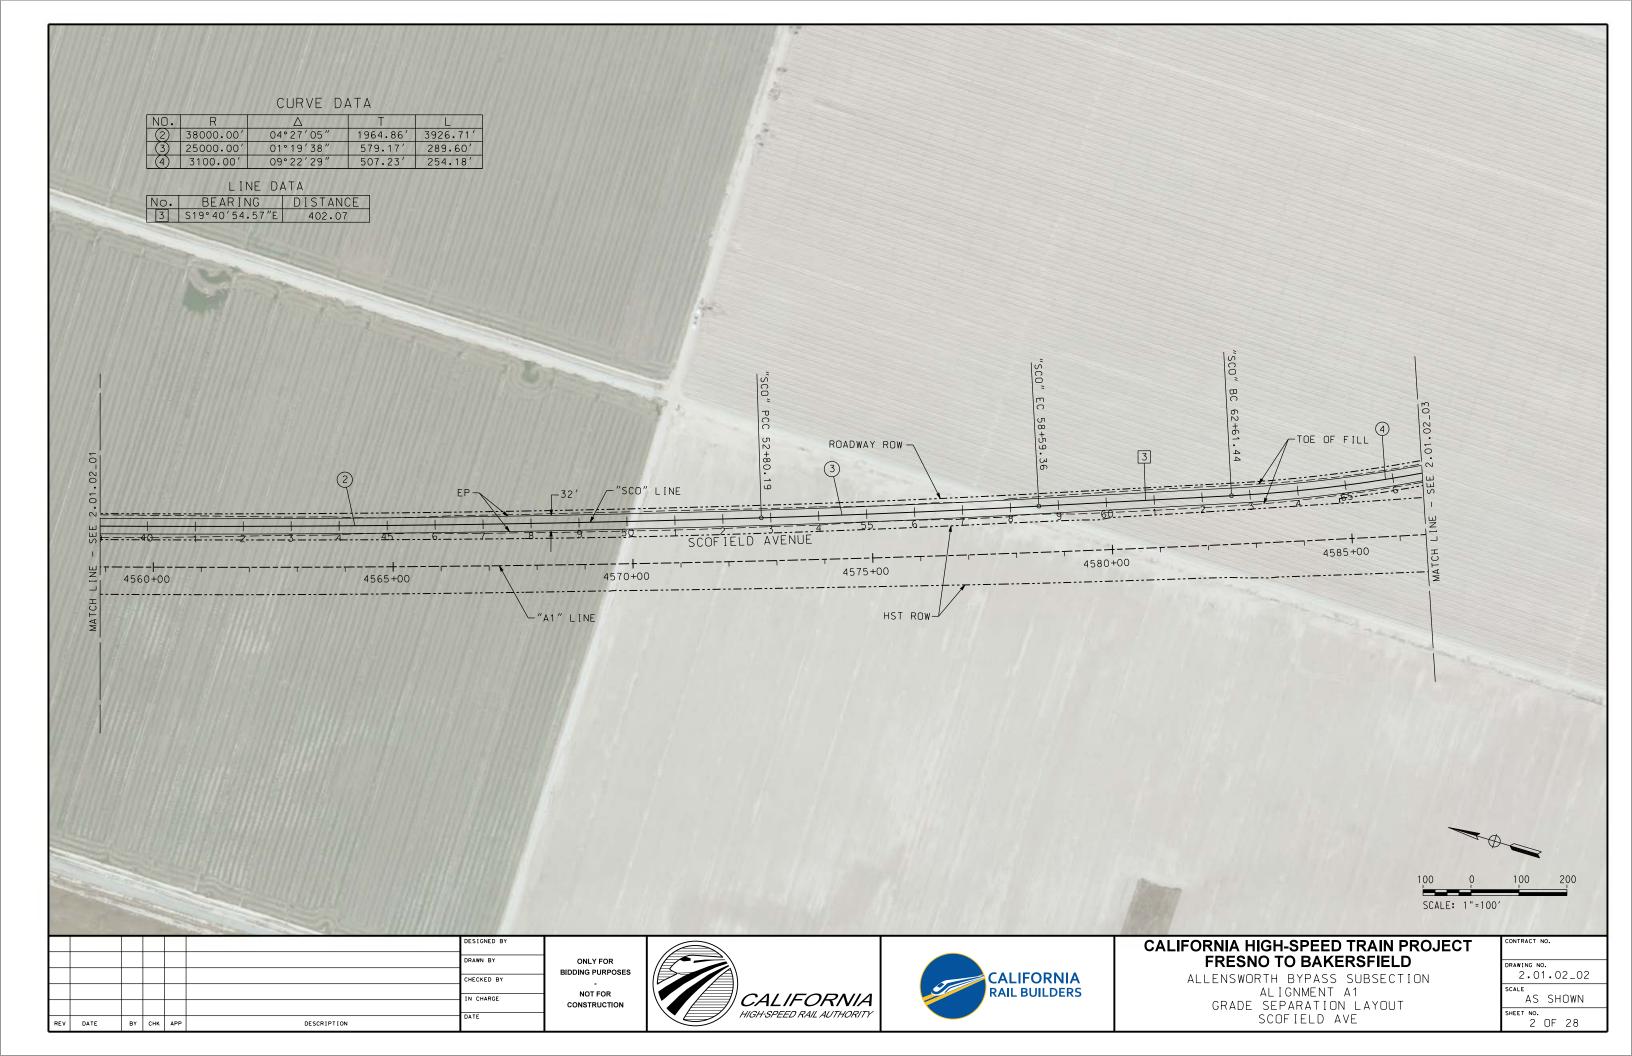


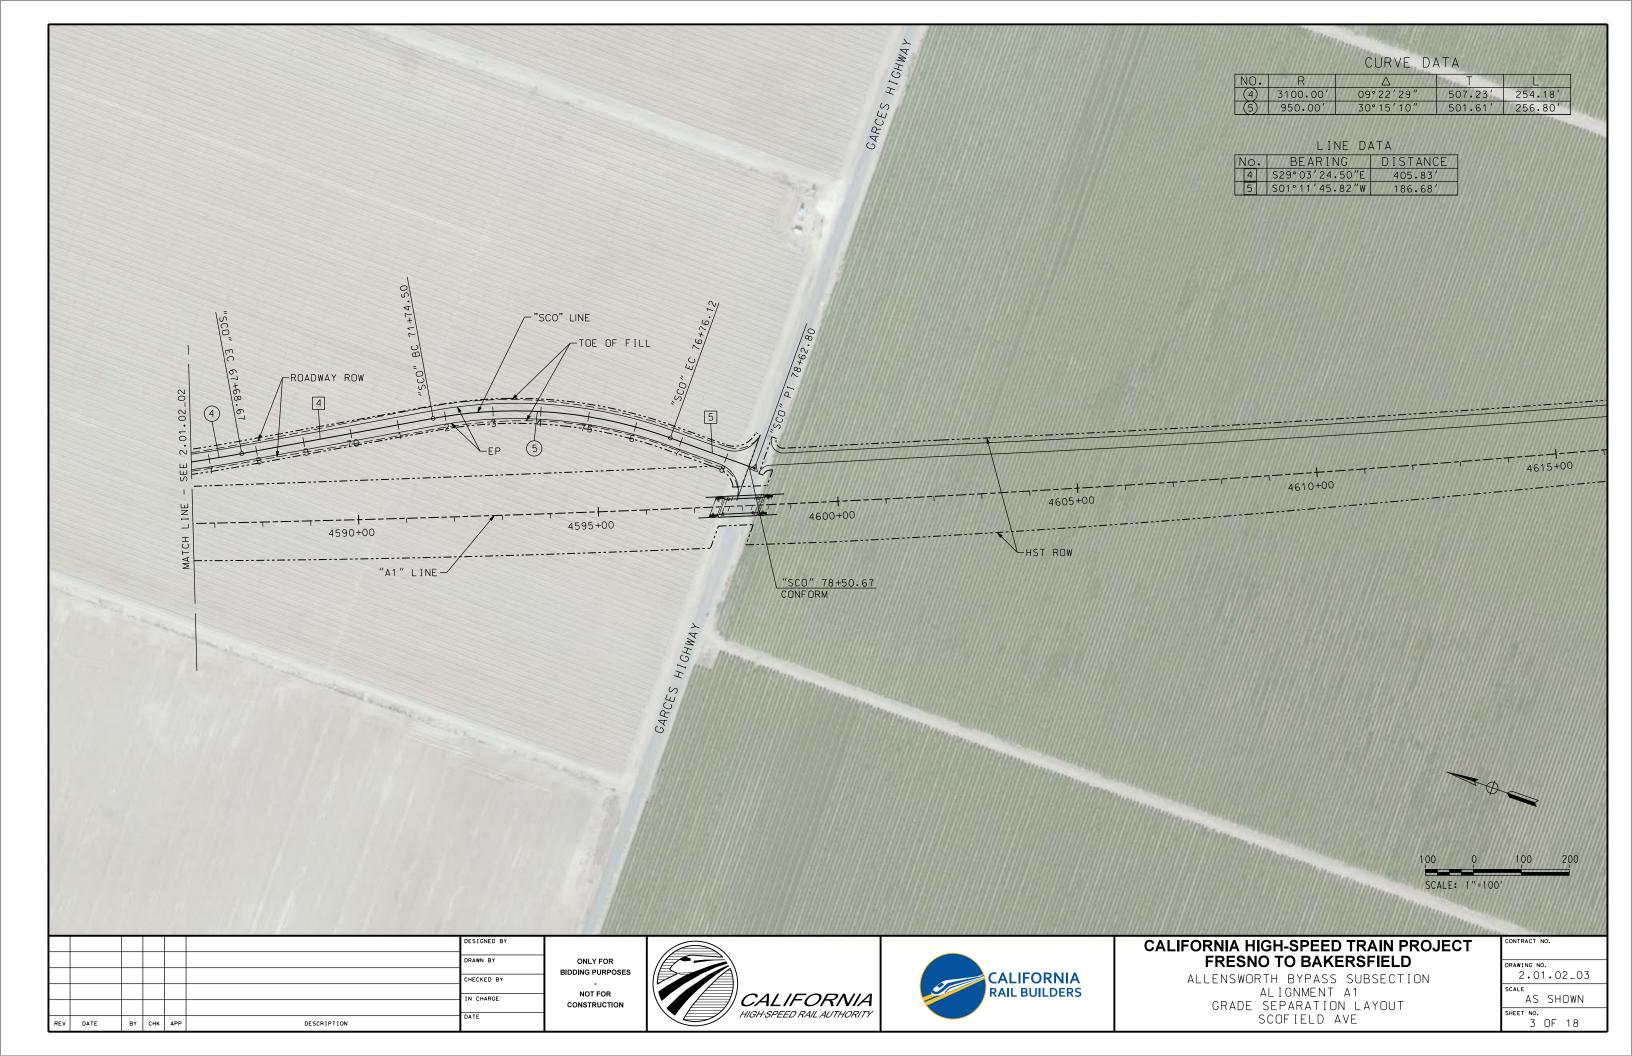


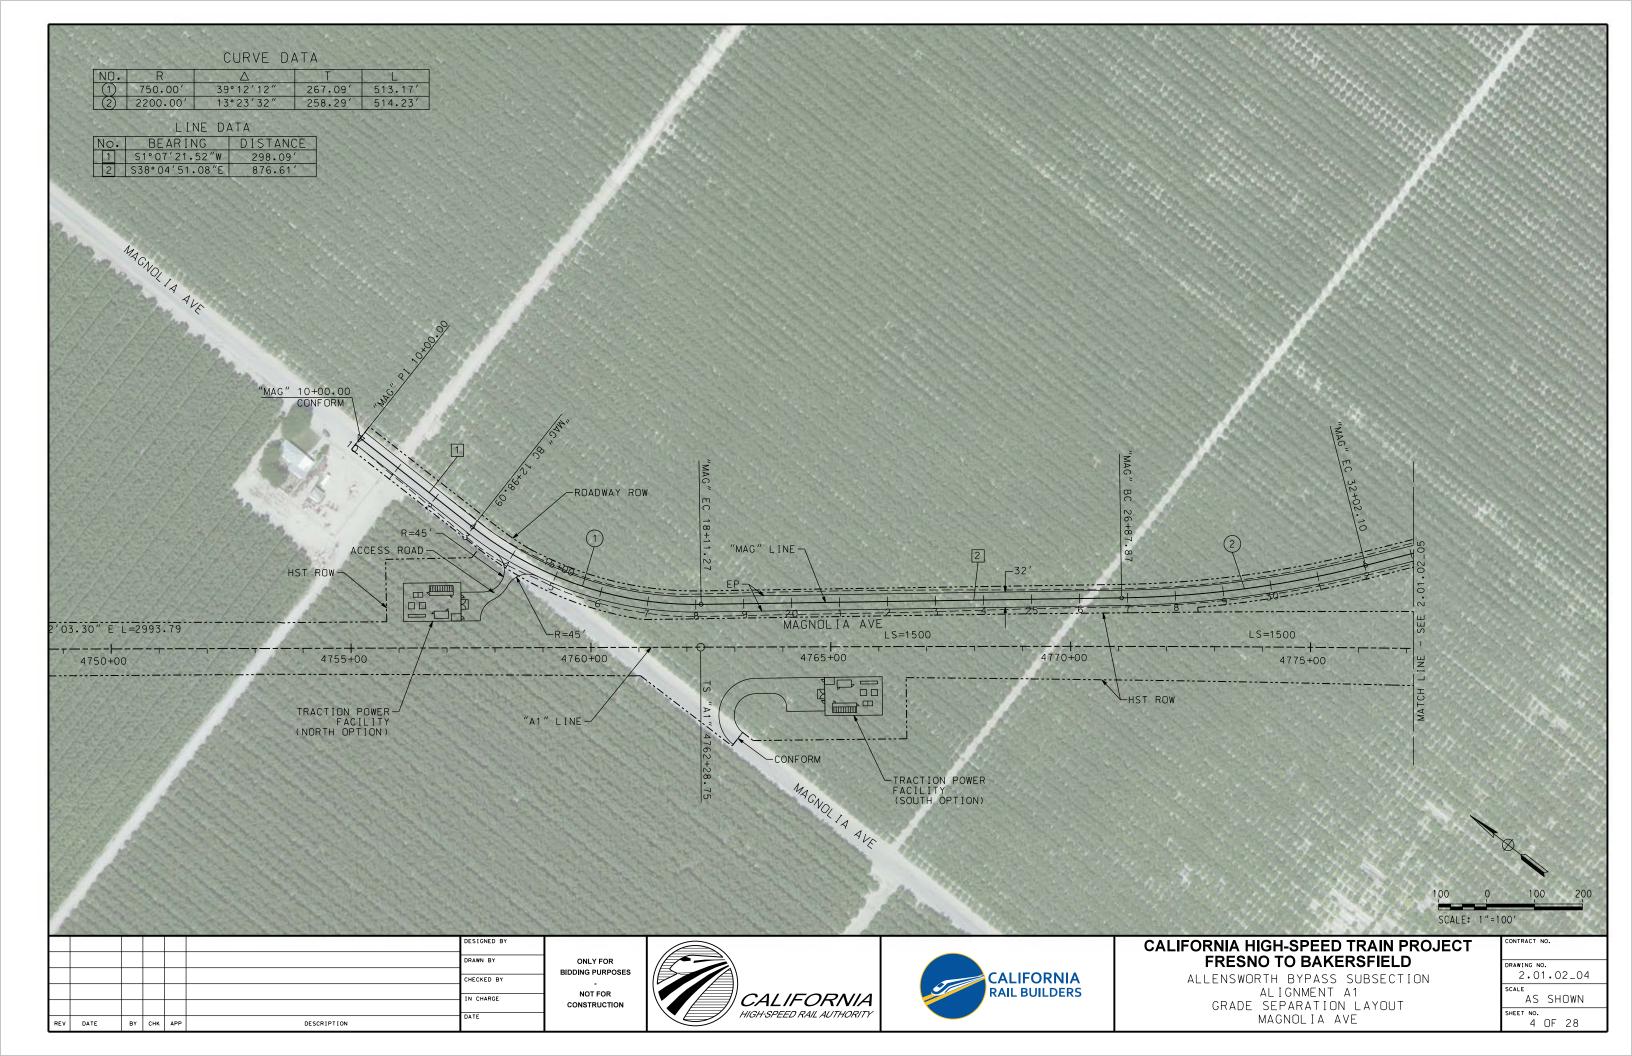


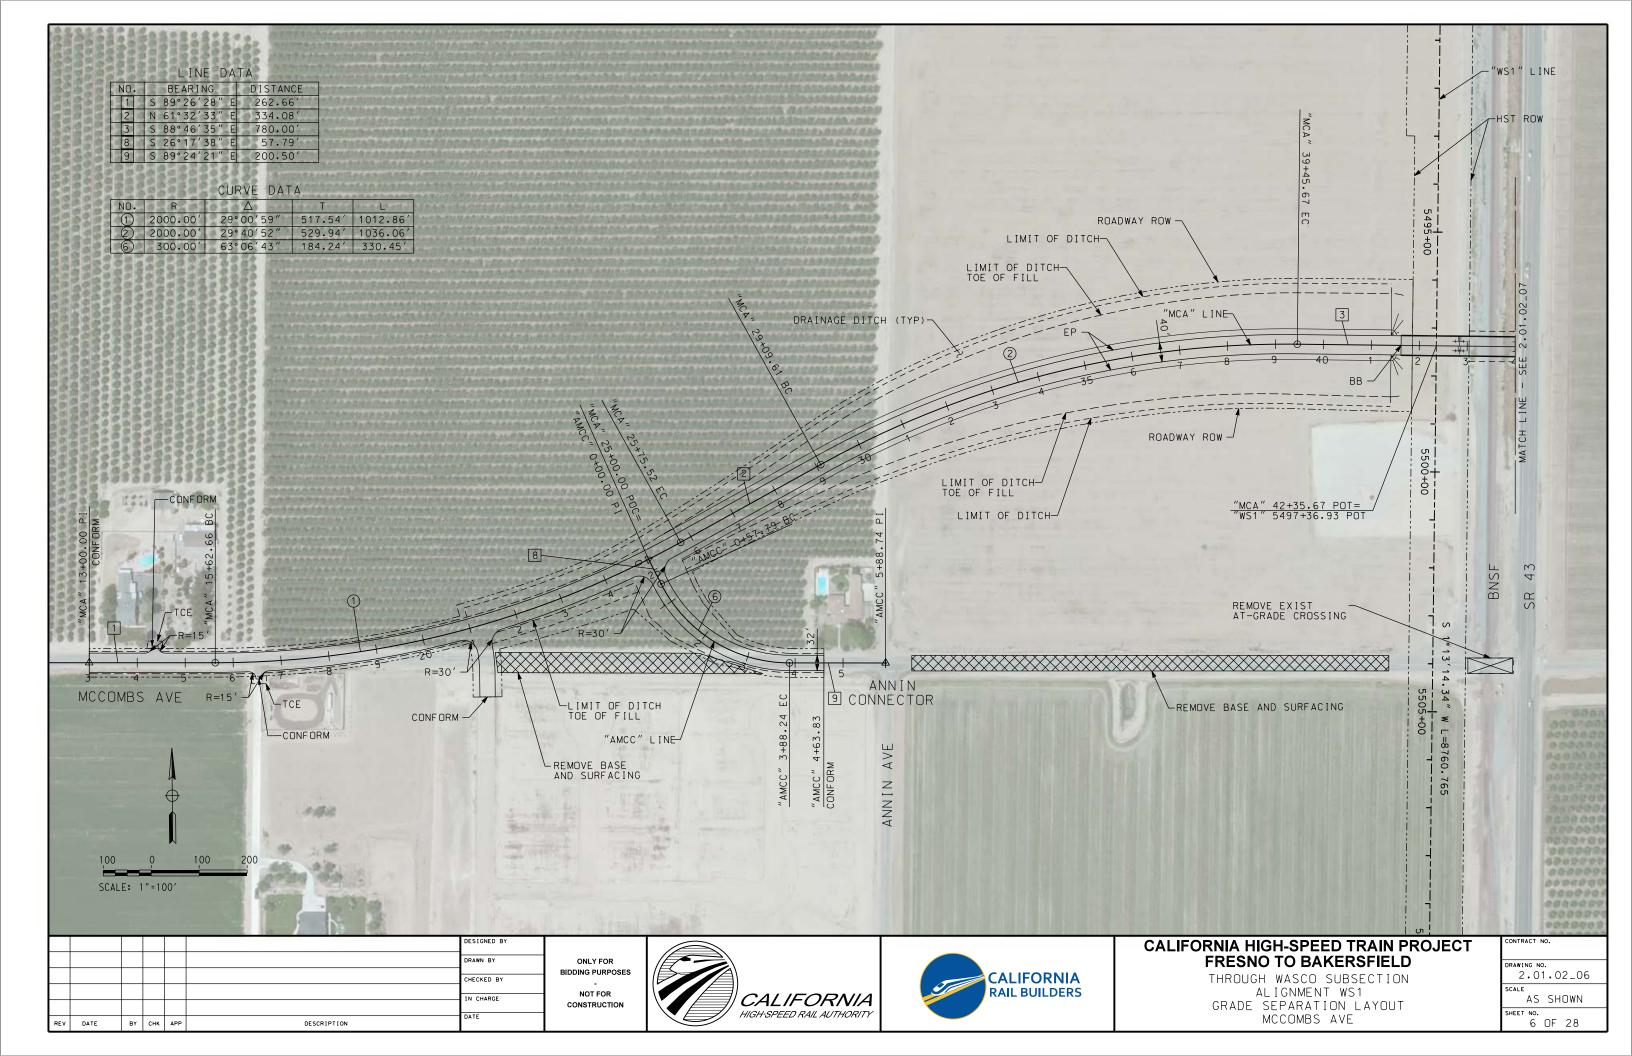


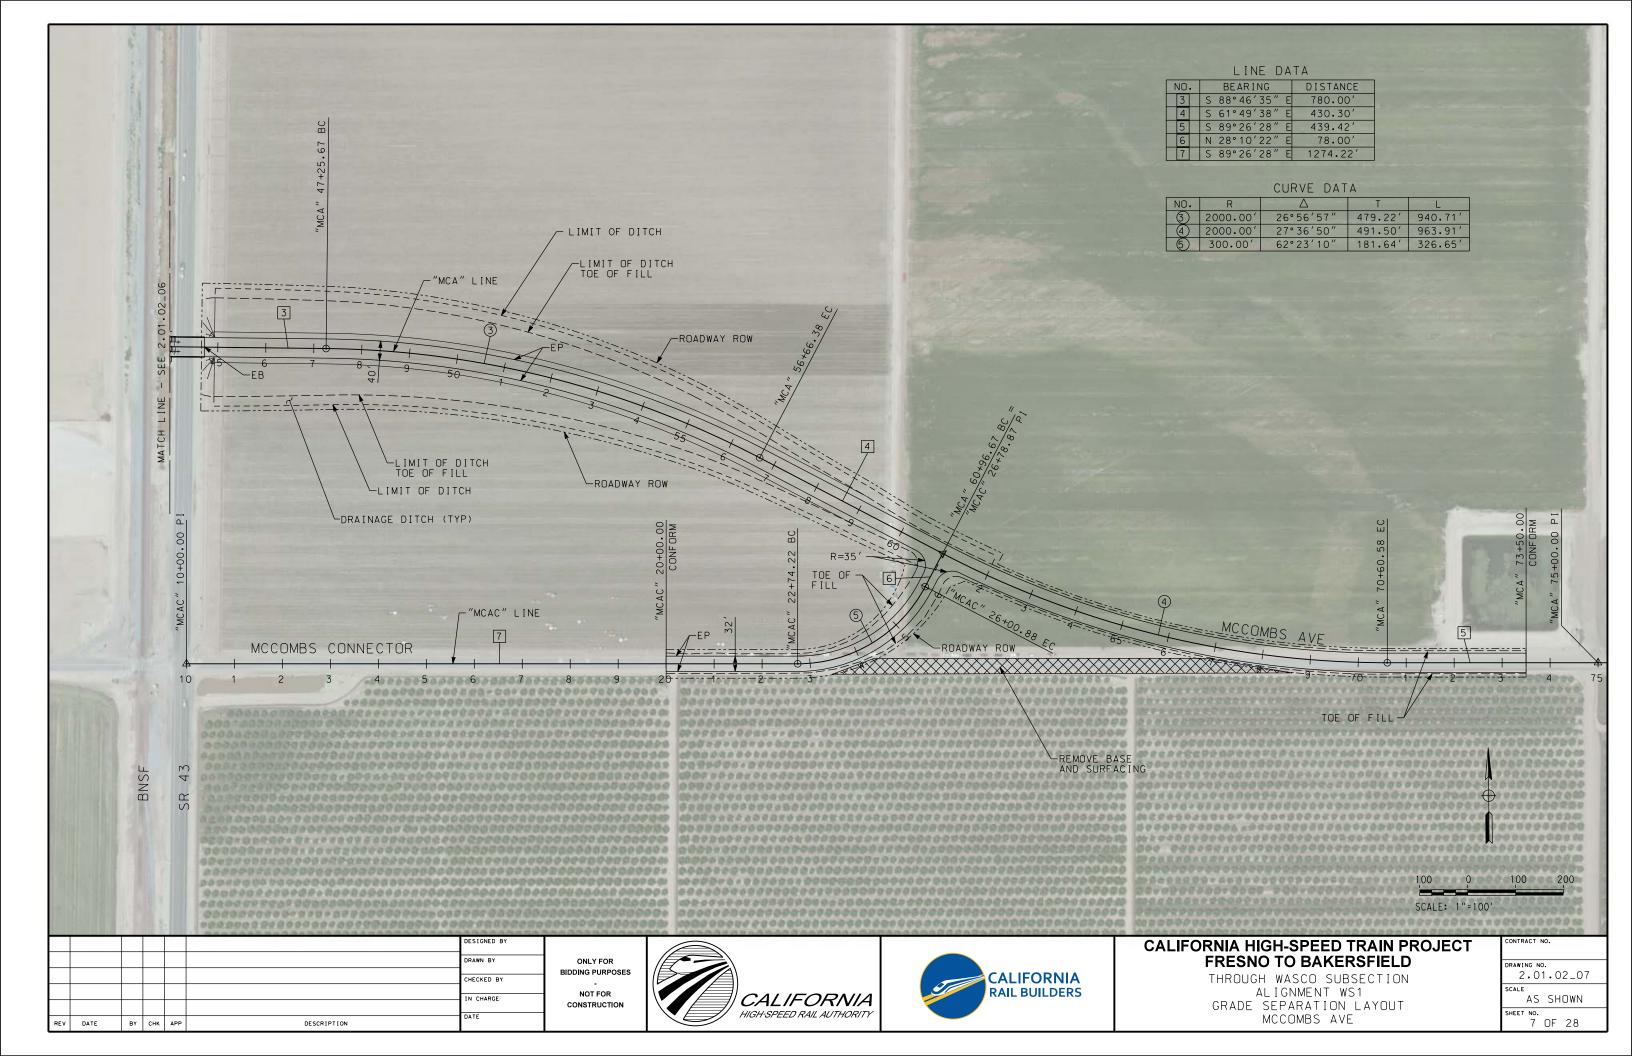


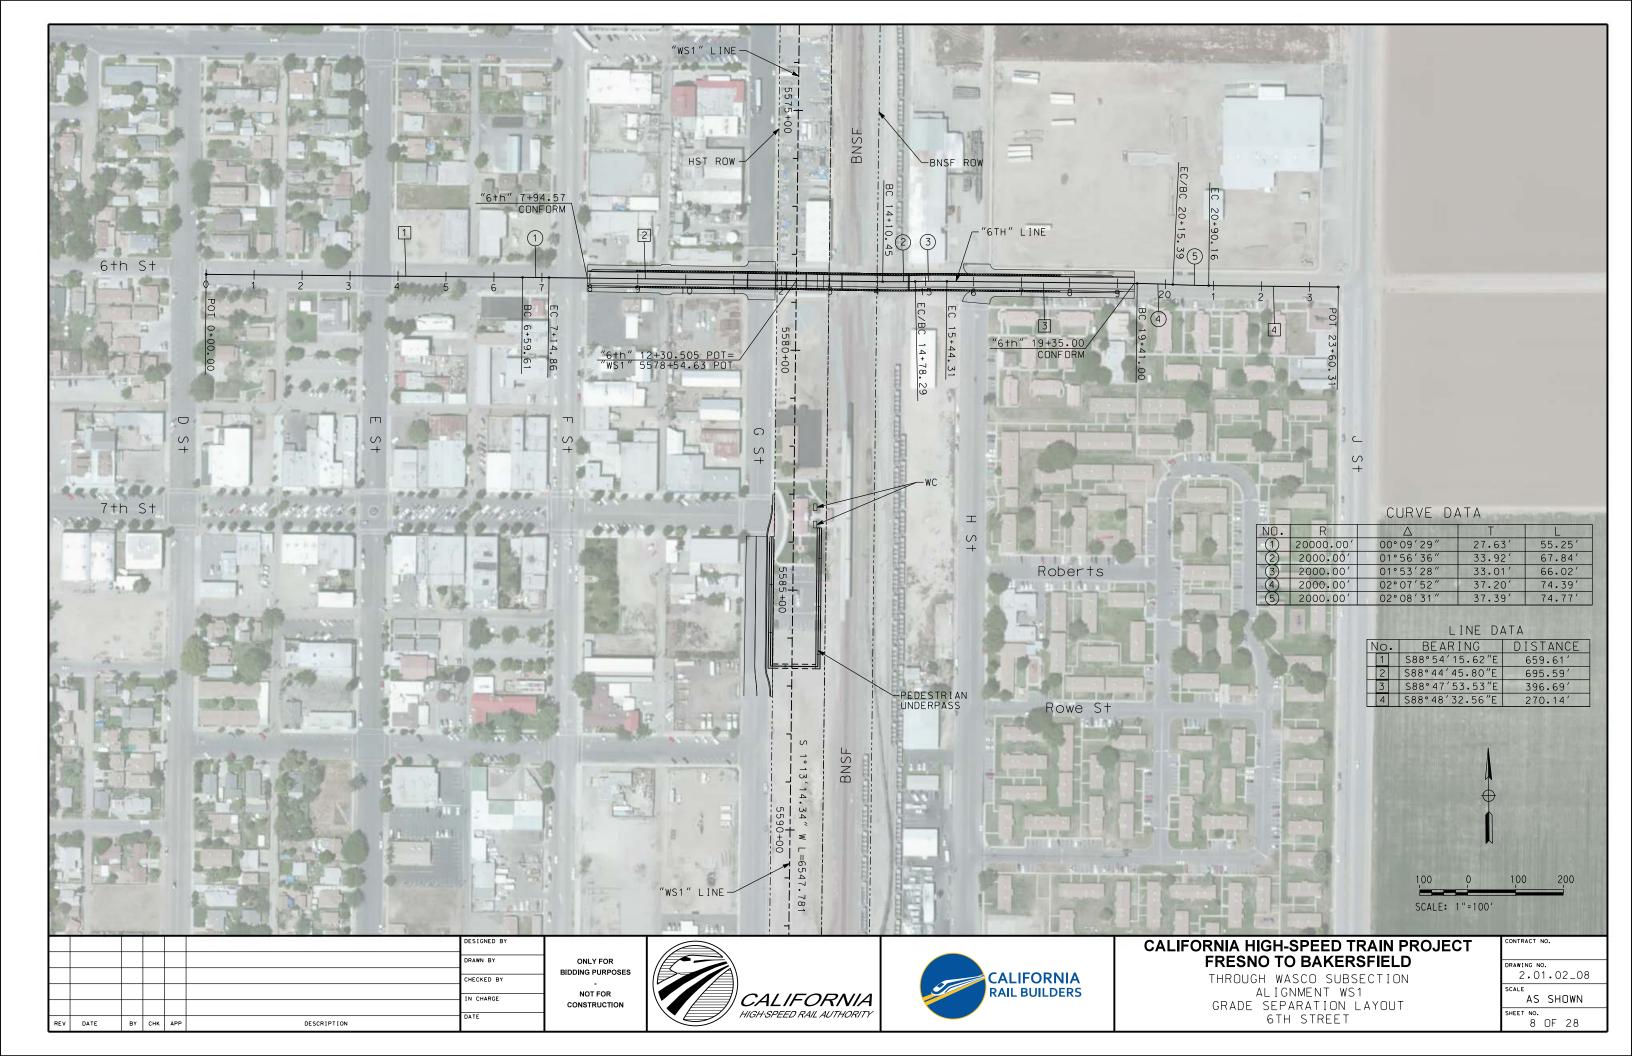


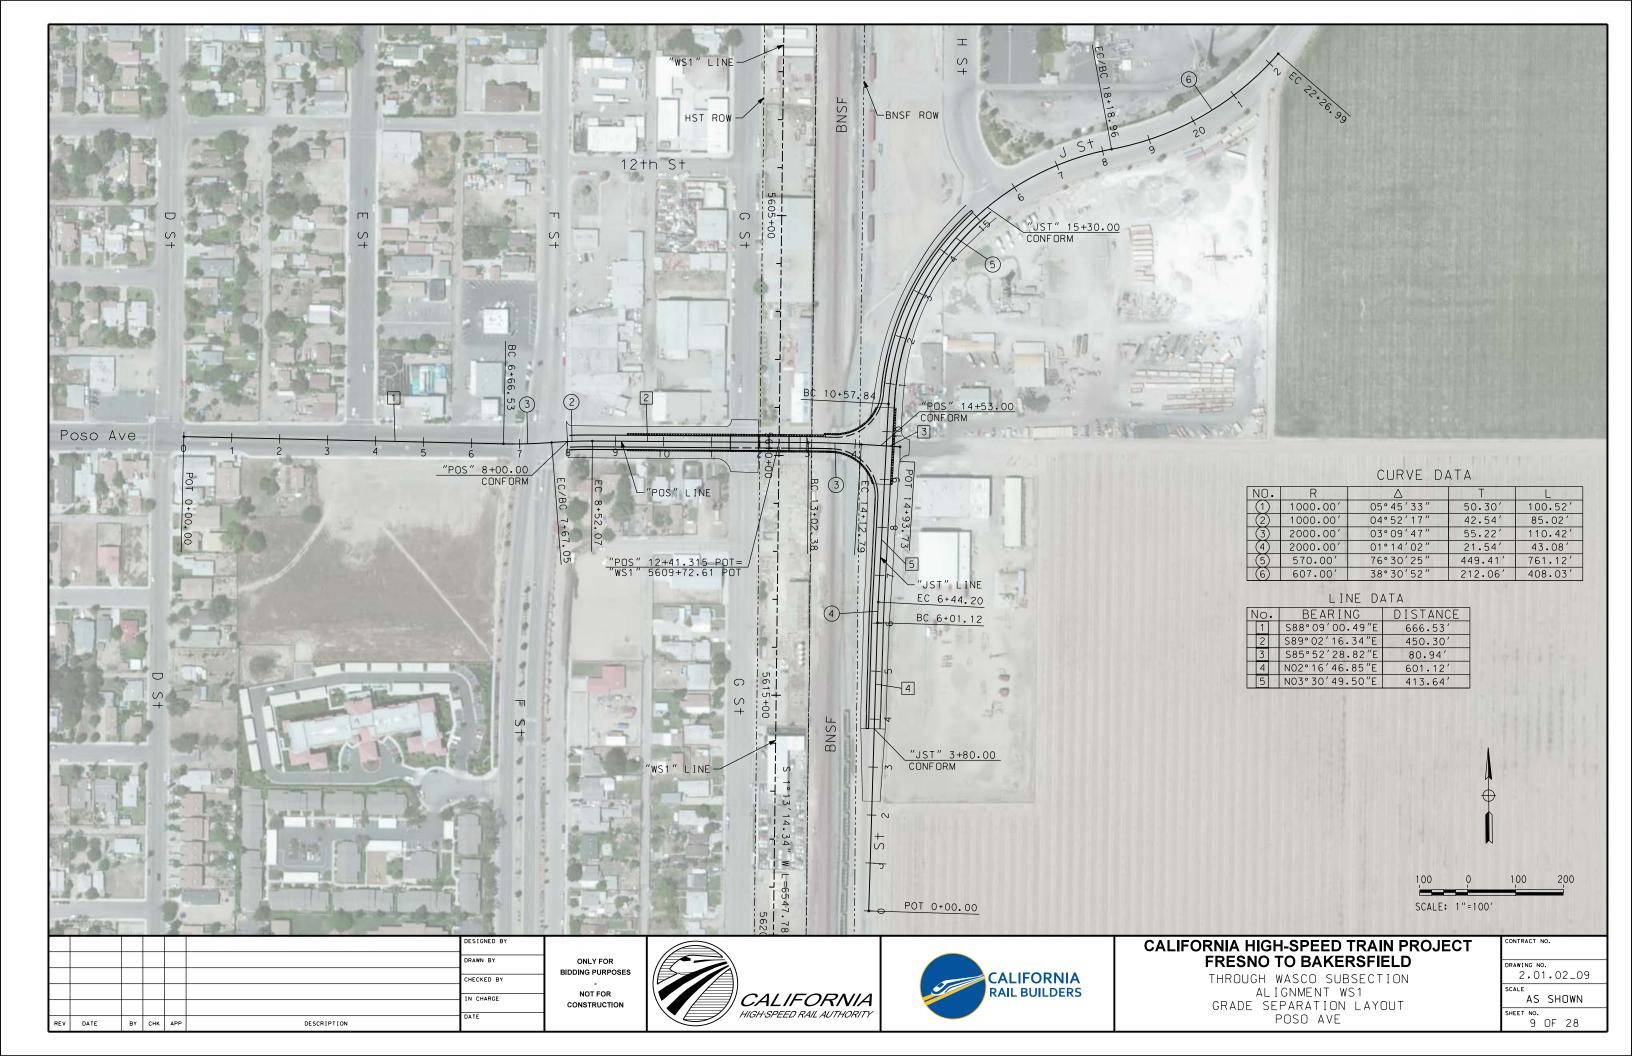

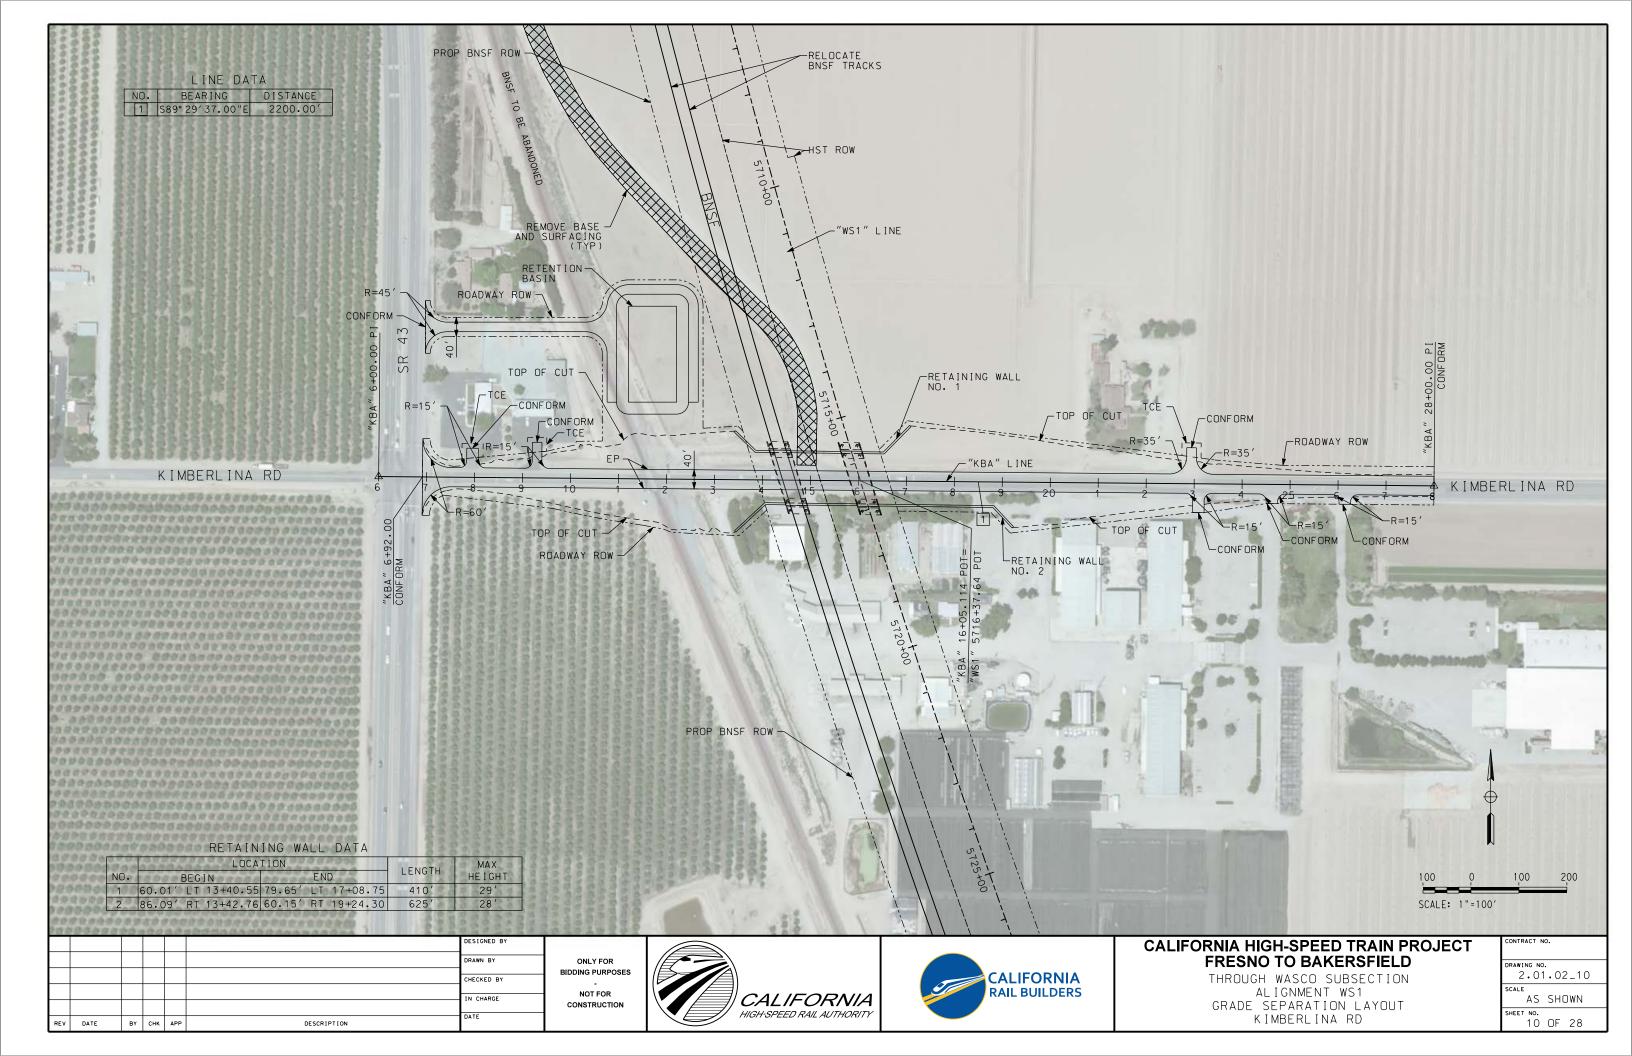


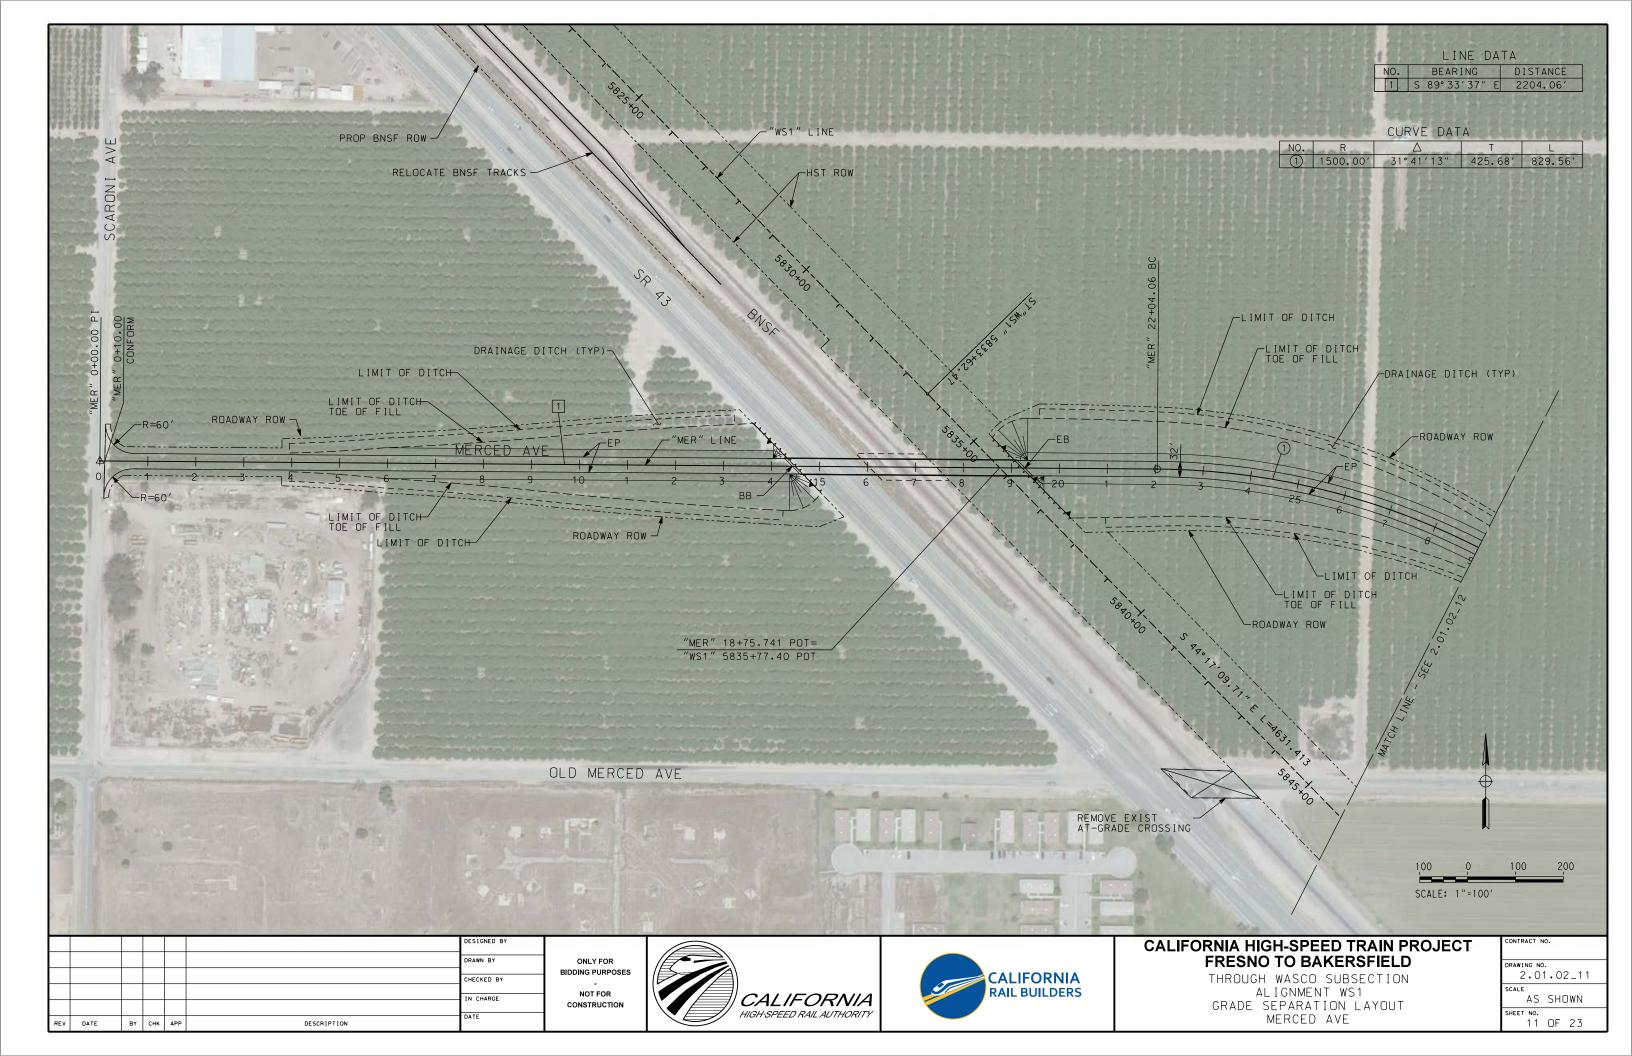

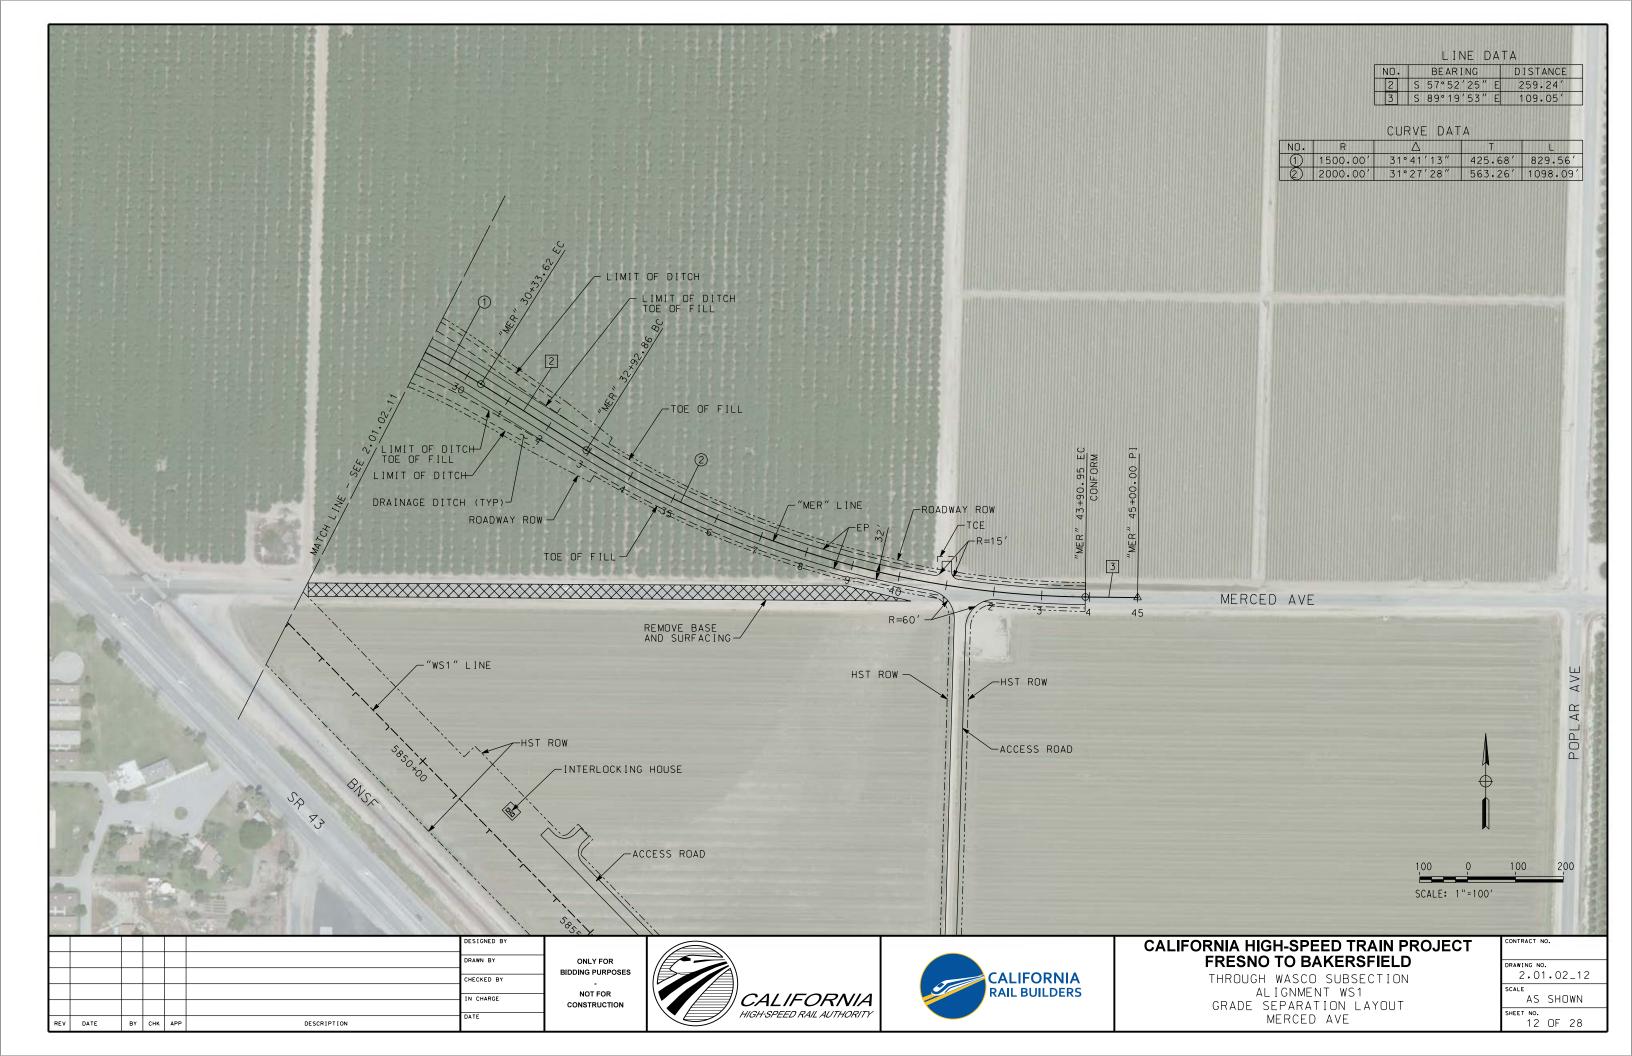

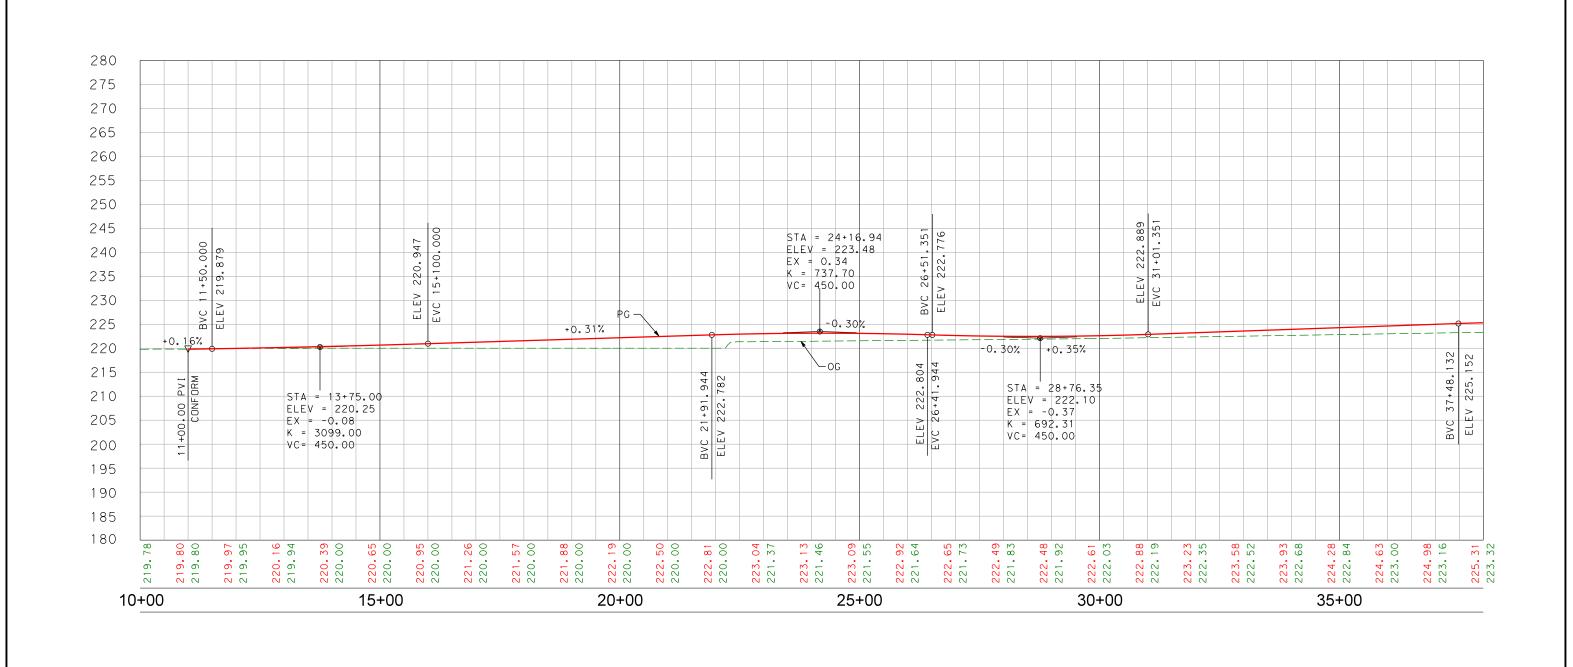

PROFILE
"SCO" LINE

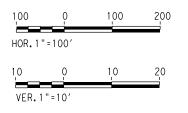

REV	DATE	BY	СНК	APP	DESCRIPTION	DATE	
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CONSTRUCTION







### CALIFORNIA HIGH-SPEED TRAIN PROJECT FRESNO TO BAKERSFIELD

ALLENSWORTH BYPASS SUBSECTION
ALIGNMENT A1
GRADE SEPERATION PROFILE
SCOFIELD AVE

CONTRACT NO.
DRAWING NO. 2.01.02_13
SCALE
AS SHOWN
SHEET NO.
13 OF 28

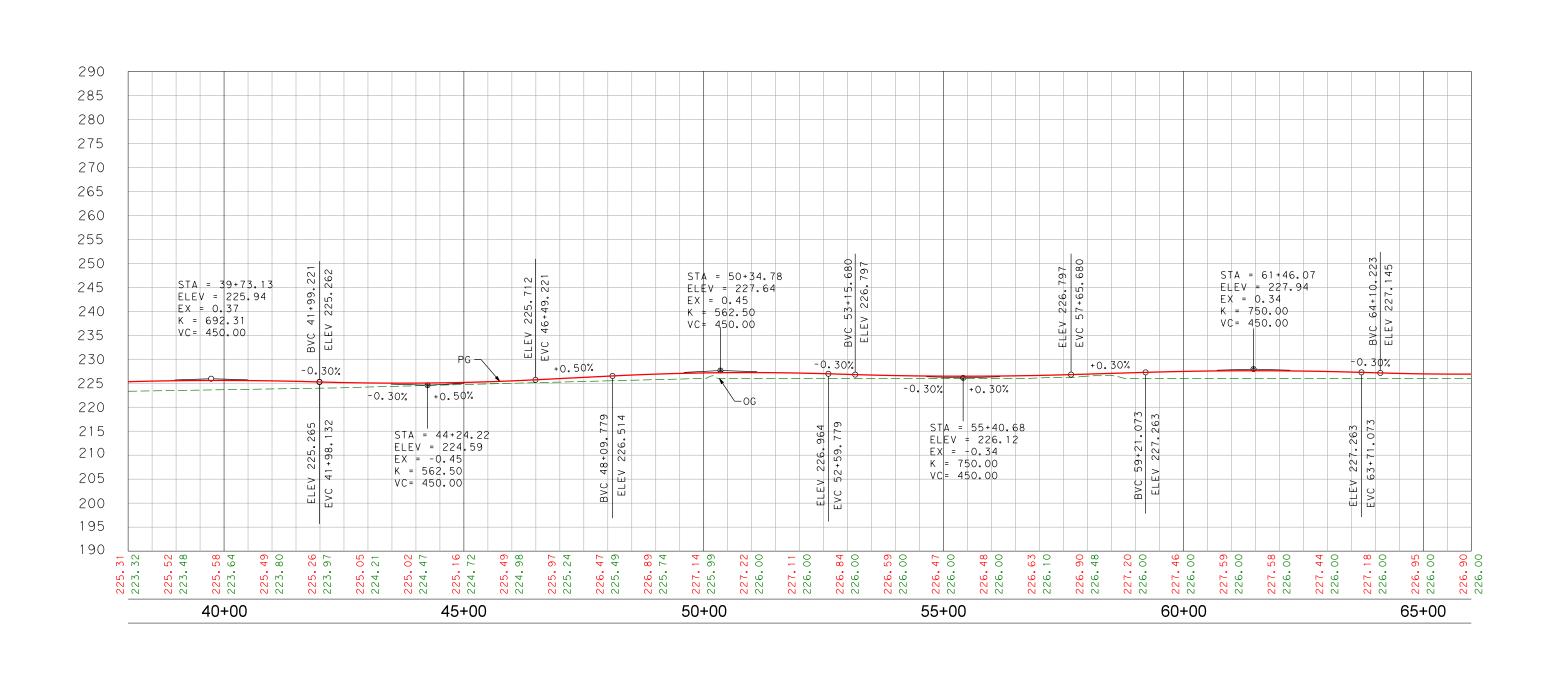

PROFILE
"SCO" LINE

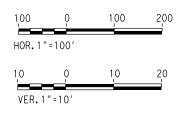

REV	DATE	BY	СНК	APP	DESCRIPTION	DATE	
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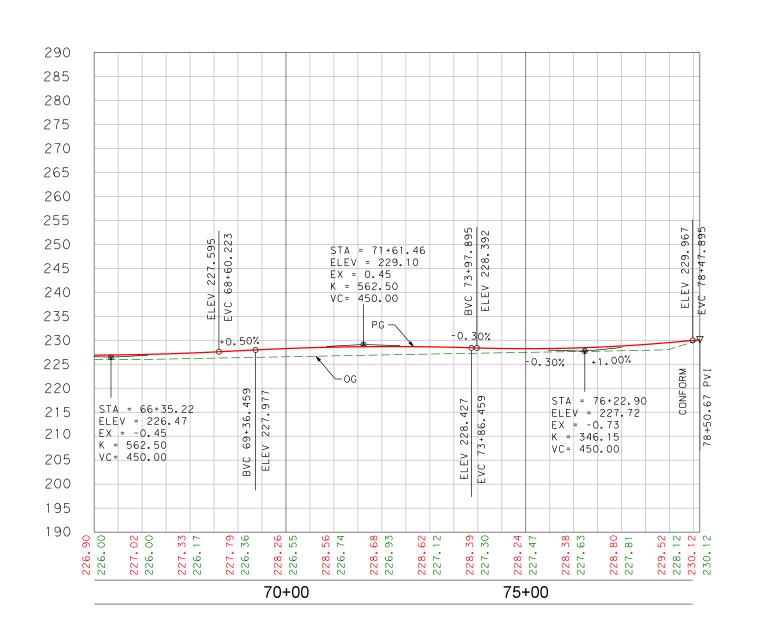





### CALIFORNIA HIGH-SPEED TRAIN PROJECT FRESNO TO BAKERSFIELD

ALLENSWORTH BYPASS SUBSECTION
ALIGNMENT A1
GRADE SEPERATION PROFILE
SCOFIELD AVE

CONTRACT NO.
DRAWING NO. 2.01.02_14
SCALE
AS SHOWN
SHEET NO.
14 OF 28



PROFILE
"SCO" LINE

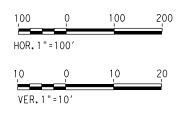

REV	DATE	BY	снк	APP	DESCRIPTION	DATE	
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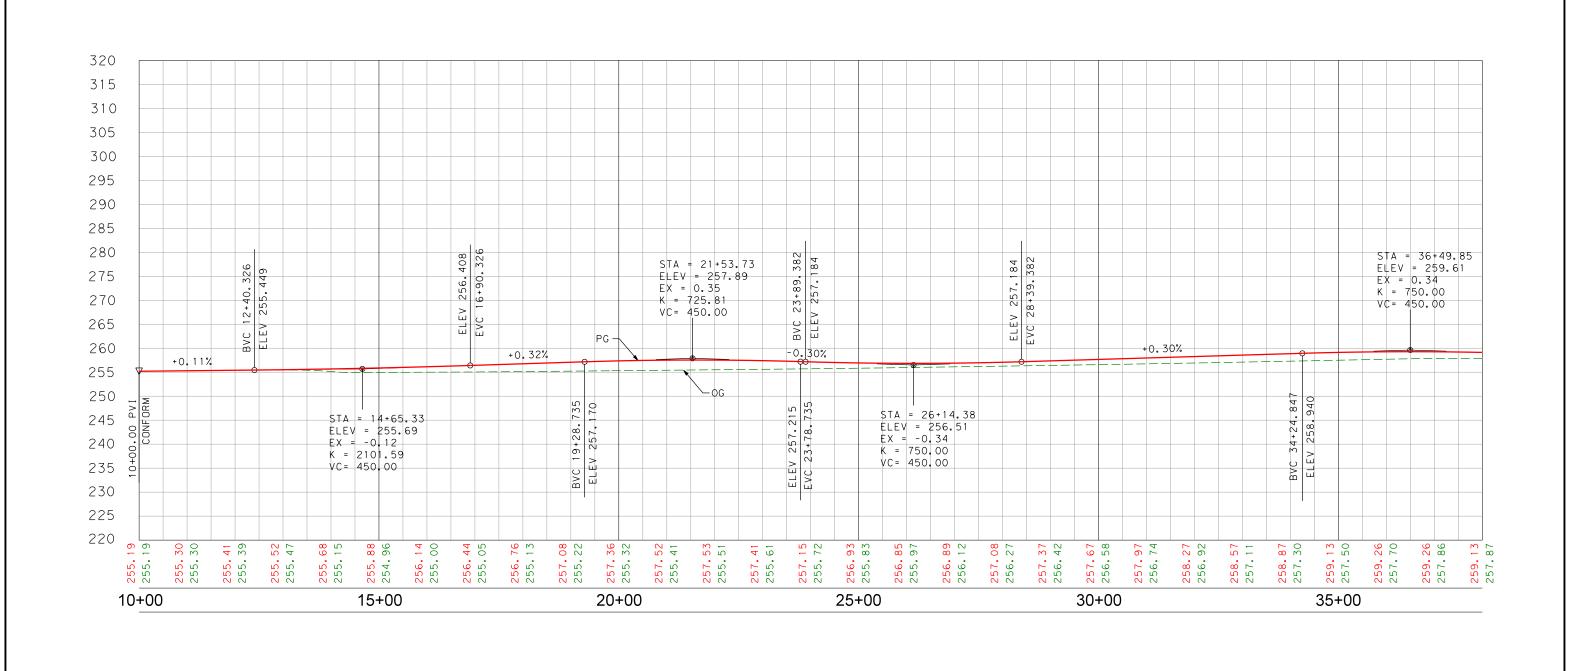





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ALLENSWORTH BYPASS SUBSECTION
ALIGNMENT A1
GRADE SEPERATION PROFILE
SCOFIELD AVE

CONTRACT NO.
DRAWING NO.
2.01.02_15
SCALE
AS SHOWN
SHEET NO.
15 OF 28





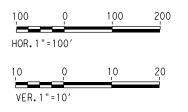

REV	DATE	BY	снк	APP	DESCRIPTION	DATE	
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BIDDING PURPOSES

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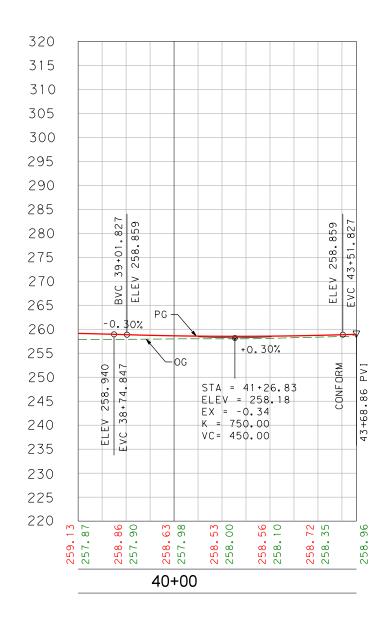





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ALLENSWORTH BYPASS SUBSECTION
ALIGNMENT A1
GRADE SEPERATION PROFILE
MAGNOLIA AVE

CONTRACT NO.
DRAWING NO.
2.01.02_16
SCALE
AS SHOWN
SHEET NO.
16 OF 28



PROFILE
"MAG" LINE

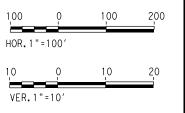

REV	DATE	BY	СНК	APP	DESCRIPTION	DATE
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BIDDING PURPOSES

NOT FOR
CONSTRUCTION







### CALIFORNIA HIGH-SPEED TRAIN PROJECT FRESNO TO BAKERSFIELD

ALLENSWORTH BYPASS SUBSECTION
ALIGNMENT A1
GRADE SEPERATION PROFILE
MAGNOLIA AVE

CONTRACT NO.
DRAWING NO. 2.01.02_17
SCALE AS SHOWN
SHEET NO. 17 OF 28

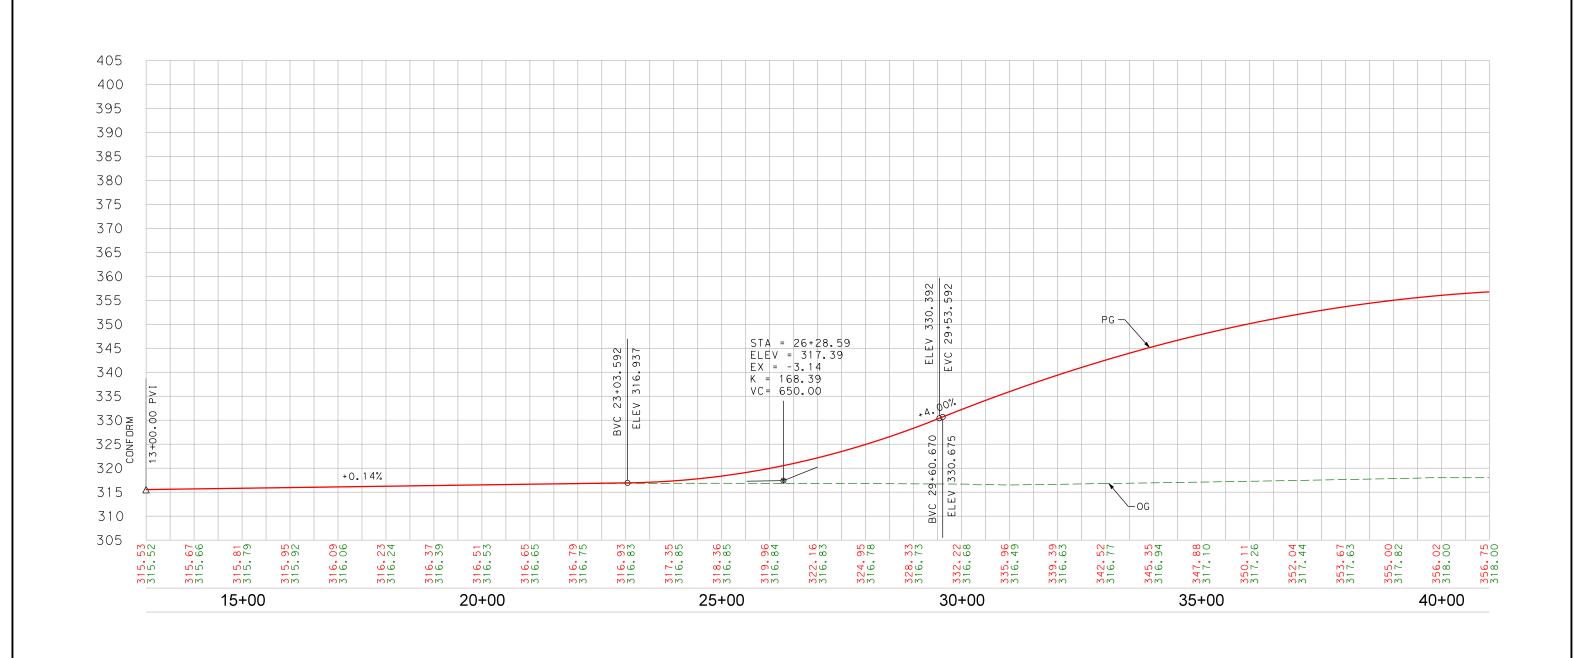

PROFILE
"MCA" LINE

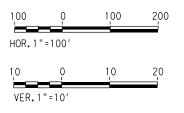

REV	DATE	ВҮ	СНК	APP	DESCRIPTION	DATE
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CONSTRUCTION







### CALIFORNIA HIGH-SPEED TRAIN PROJECT FRESNO TO BAKERSFIELD

THROUGH WASCO SUBSECTION
ALIGNMENT WS1
GRADE SEPERATION PROFILE
MCCOMBS AVE

CONTRACT NO.
DRAWING NO. 2.01.02_18
AS SHOWN
SHEET NO. 18 OF 28

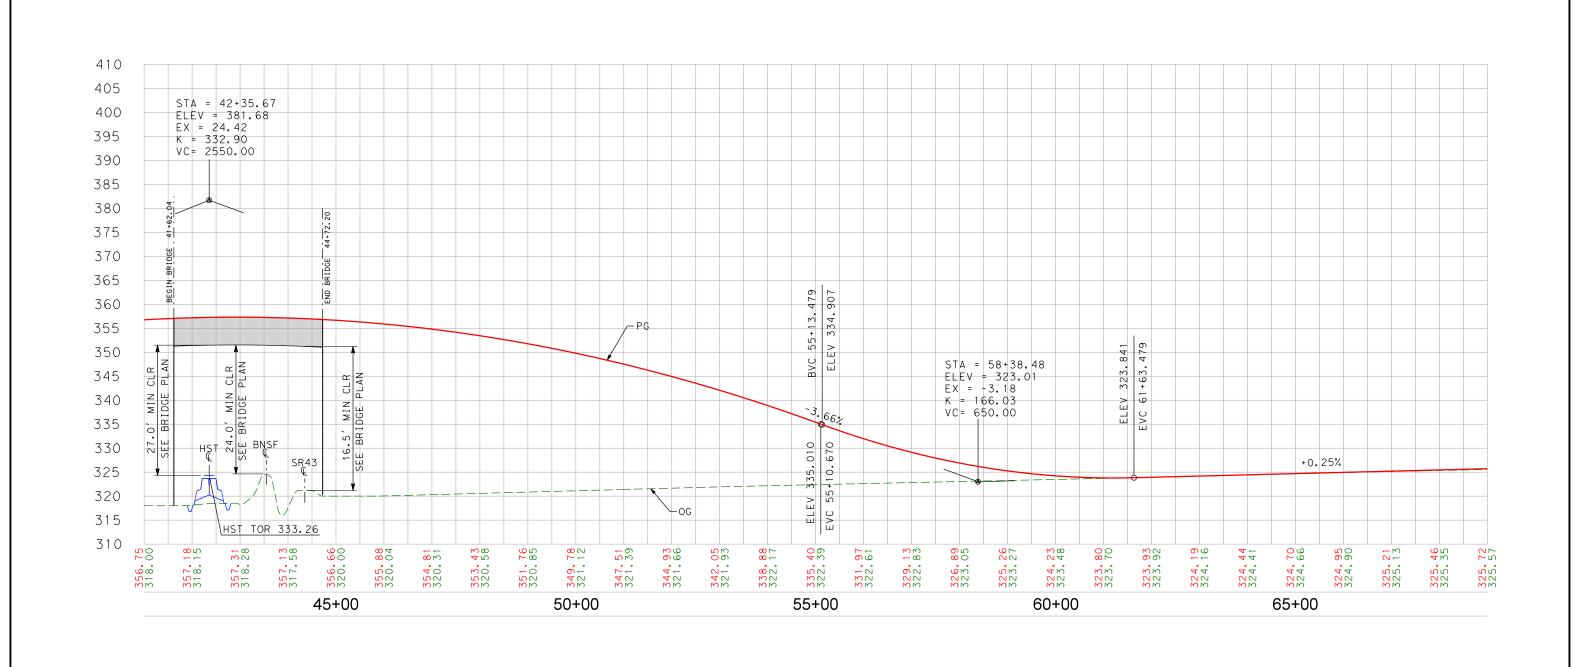

PROFILE
"MCA" LINE

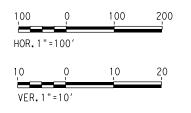

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CONSTRUCTION






### CALIFORNIA HIGH-SPEED TRAIN PROJECT FRESNO TO BAKERSFIELD

THROUGH WASCO SUBSECTION
ALIGNMENT WS1
GRADE SEPERATION PROFILE
MCCOMBS AVE

CONTRACT NO.
DRAWING NO.
2.01.02_19
2.01.02_13
SCALE
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SHEET NO.
l 19 OF 28



PROFILE
"MCA" LINE

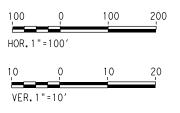

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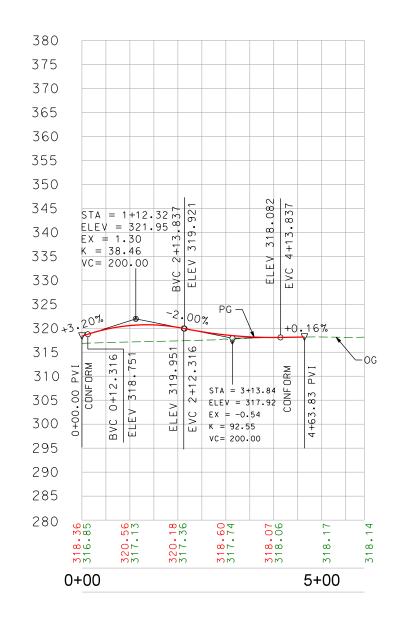





#### CALIFORNIA HIGH-SPEED TRAIN PROJECT FRESNO TO BAKERSFIELD

THROUGH WASCO SUBSECTION
ALIGNMENT WS1
GRADE SEPERATION PROFILE
MCCOMBS AVE

CONTRACT NO.
DRAWING NO. 2.01.02_20
AS SHOWN
SHEET NO. 20 OF 28



PROFILE
"AMCC" LINE

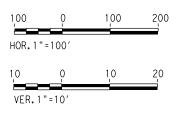

						DESIGNED BY	
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BIDDING PURPOSES
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CONSTRUCTION







### CALIFORNIA HIGH-SPEED TRAIN PROJECT FRESNO TO BAKERSFIELD

THROUGH WASCO SUBSECTION
ALIGNMENT WS1
GRADE SEPERATION PROFILE
ANNIN CONNECTOR

CONTRACT NO.
DRAWING NO. 2.01.02_21
AS SHOWN
SHEET NO. 21 OF 28

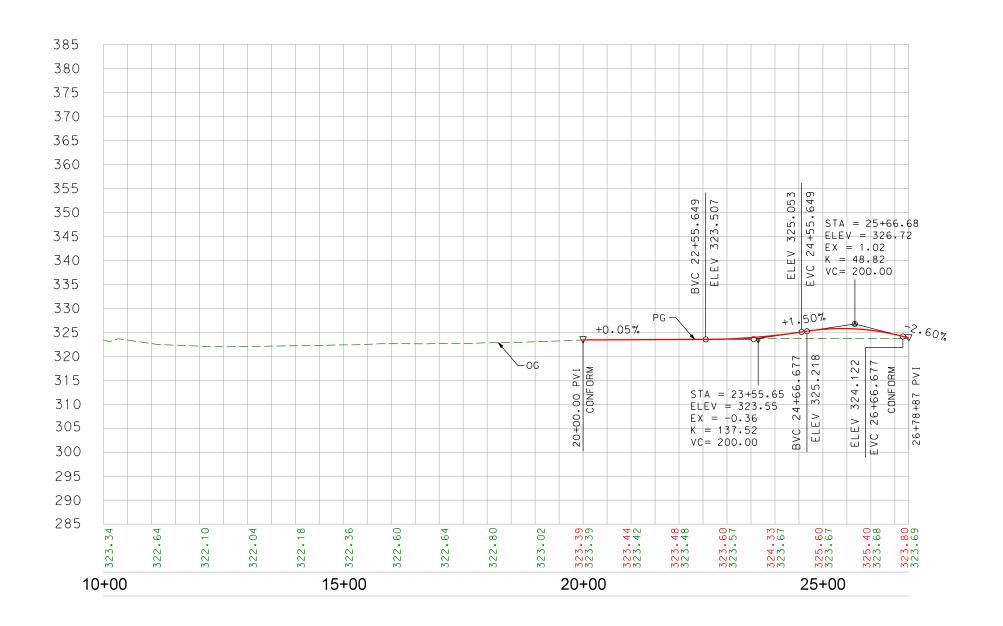

PROFILE
"MCAC" LINE

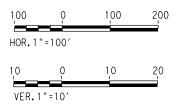

REV	DATE	BY	СНК	APP	DESCRIPTION	DATE	
						DATE	4
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BIDDING PURPOSES
NOT FOR
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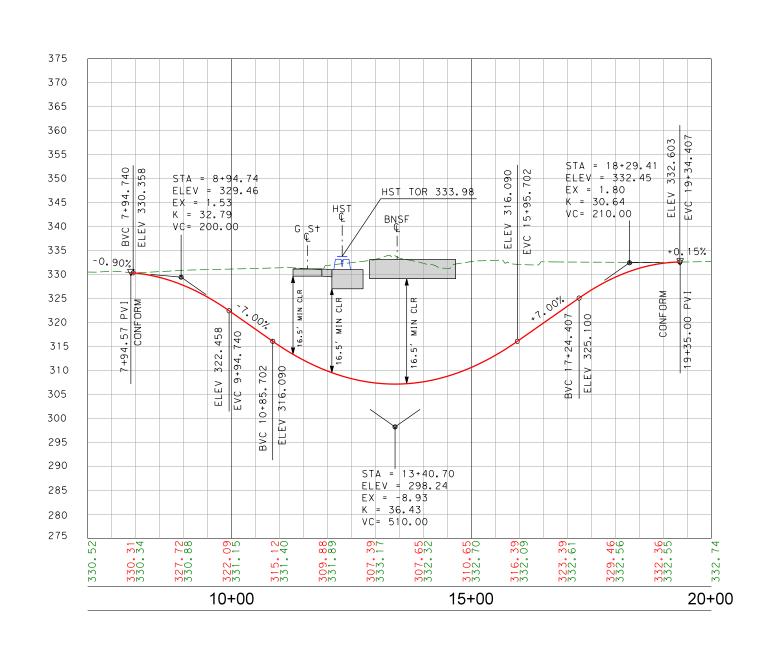





# CALIFORNIA HIGH-SPEED TRAIN PROJECT FRESNO TO BAKERSFIELD

THROUGH WASCO SUBSECTION
ALIGNMENT WS1
GRADE SEPERATION PROFILE
MCCOMBS CONNECTOR

CONTRACT NO.
DRAWING NO. 2.01.02_22
AS SHOWN
SHEET NO. 22 OF 28



PROFILE
"6TH" LINE

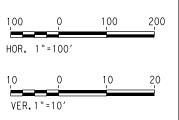

REV	DATE	BY	СНК	APP	DESCRIPTION	DATE	
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BIDDING PURPOSES
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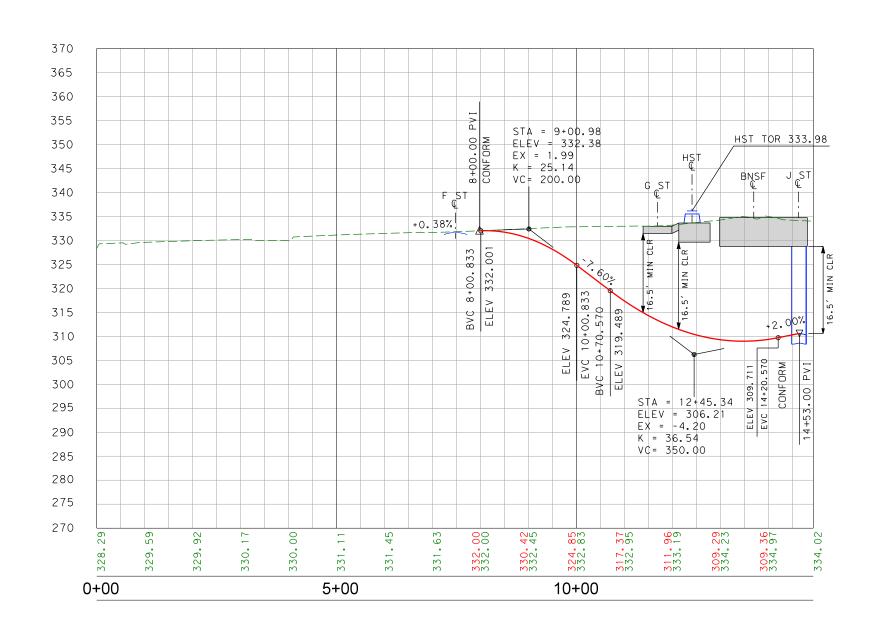





# CALIFORNIA HIGH-SPEED TRAIN PROJECT FRESNO TO BAKERSFIELD

THROUGH WASCO SUBSECTION
ALIGNMENT WS1
GRADE SEPERATION PROFILE
6TH STREET

CONTRACT NO.
DRAWING NO.
2.01.02_23
SCALE
AS SHOWN
SHEET NO.
23 OF 28



PROFILE
"POS" LINE

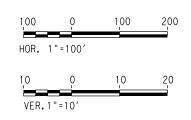

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BIDDING PURPOSES
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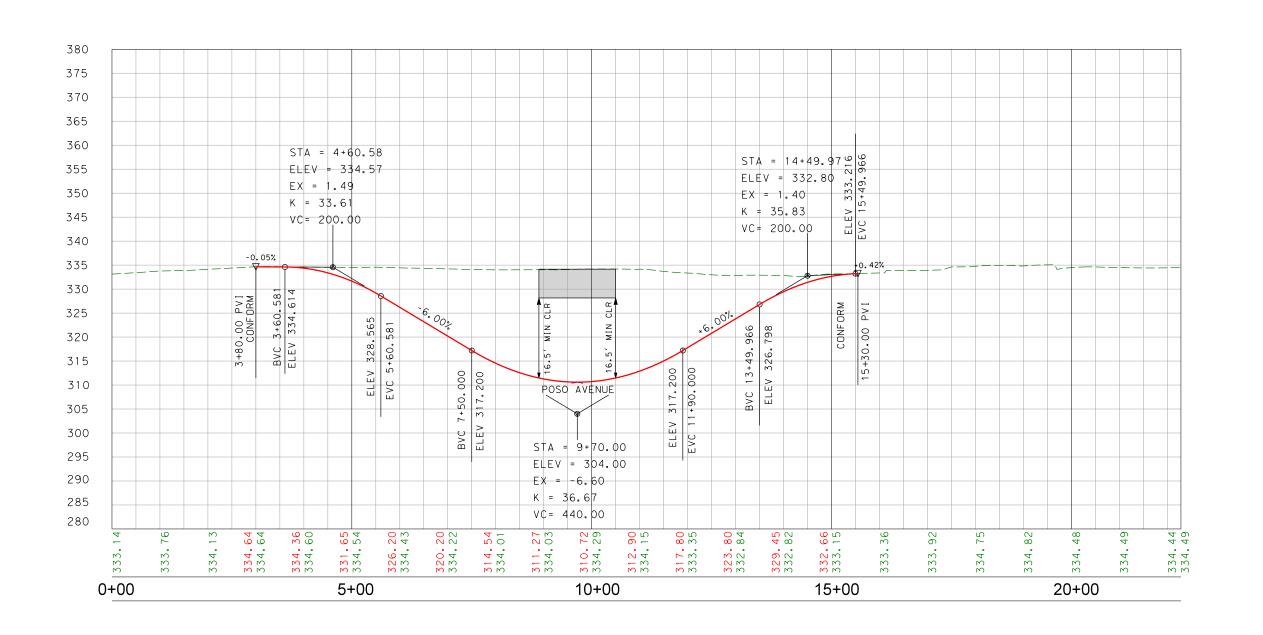





### CALIFORNIA HIGH-SPEED TRAIN PROJECT FRESNO TO BAKERSFIELD

THROUGH WASCO SUBSECTION
ALIGNMENT WS1
GRADE SEPERATION PROFILE
POSO AVENUE

CONTRACT NO.
DRAWING NO. 2.01.02_24
AS SHOWN
SHEET NO. 24 OF 28



PROFILE
"JST" LINE

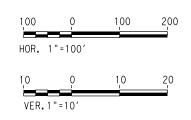

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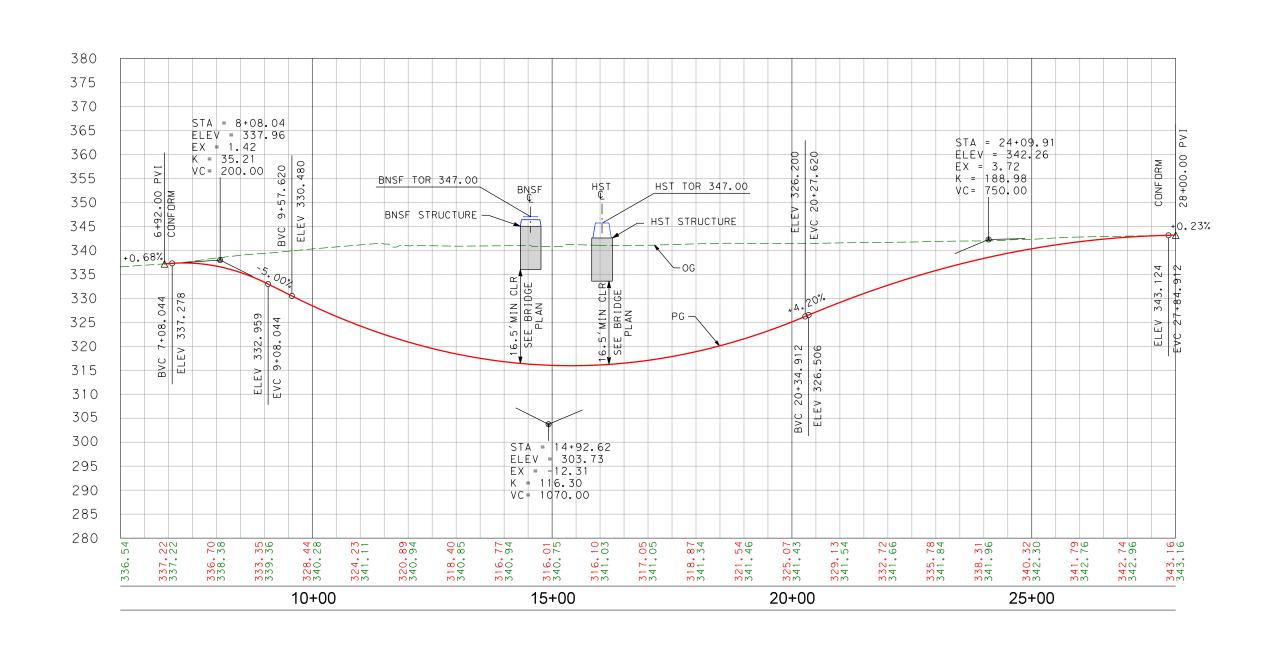





## CALIFORNIA HIGH-SPEED TRAIN PROJECT FRESNO TO BAKERSFIELD

THROUGH WASCO SUBSECTION
ALIGNMENT WS1
GRADE SEPERATION PROFILE
J STREET

CONTRACT NO.
DRAWING NO.
2.01.02_25
SCALE
AS SHOWN
SHEET NO.
25 OF 28



PROFILE
"KBA" LINE

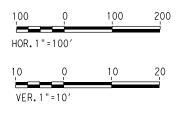

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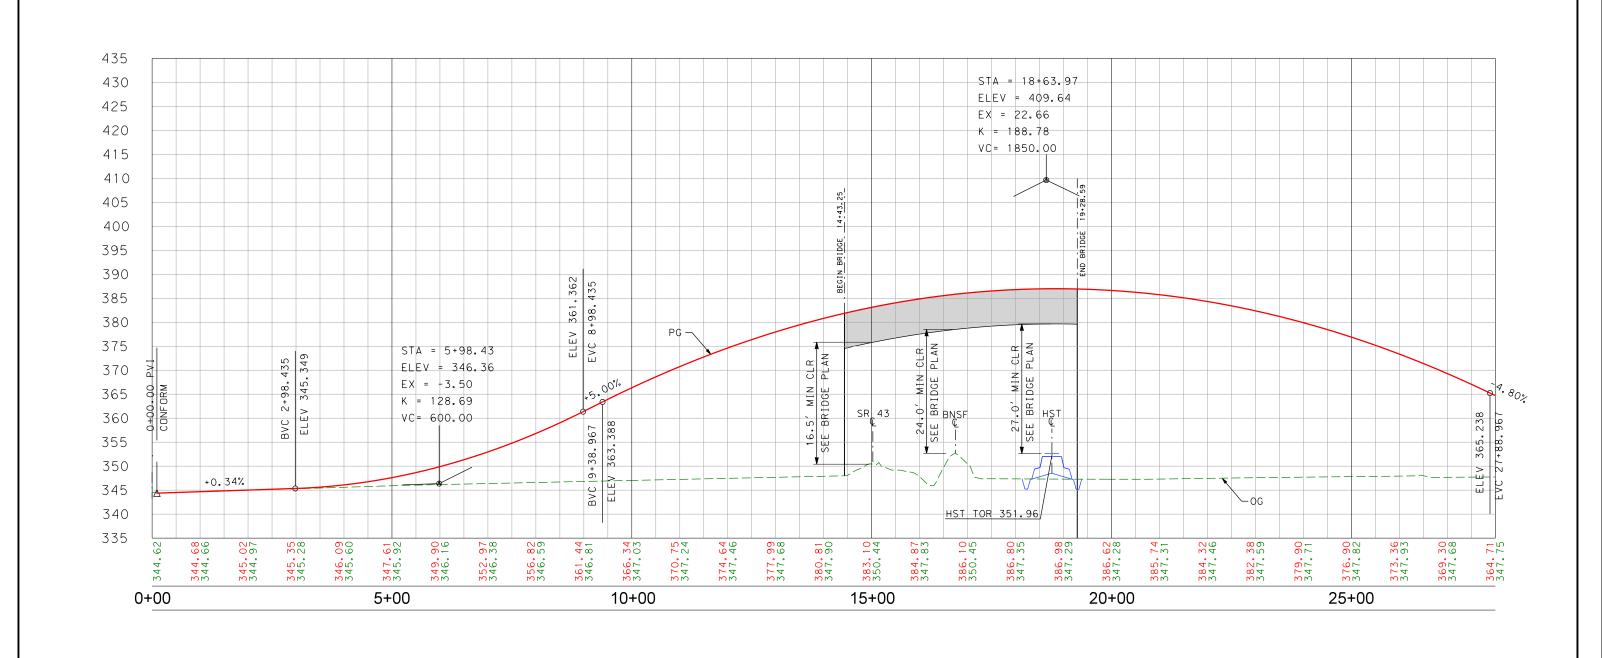





### CALIFORNIA HIGH-SPEED TRAIN PROJECT FRESNO TO BAKERSFIELD

THROUGH WASCO SUBSECTION
ALIGNMENT WS1
GRADE SEPERATION PROFILE
KIMBERLINA RD

CONTRACT NO.
DRAWING NO. 2.01.02_26
AS SHOWN
SHEET NO. 26 OF 28



PROFILE
"MER" LINE

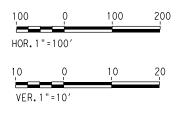

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CONSTRUCTION







## CALIFORNIA HIGH-SPEED TRAIN PROJECT FRESNO TO BAKERSFIELD

THROUGH WASCO SUBSECTION
ALIGNMENT WS1
GRADE SEPERATION PROFILE
MERCED AVE

CONTRACT NO.
DRAWING NO.
2.01.02_27
AS SHOWN
SHEET NO. 27 OF 28

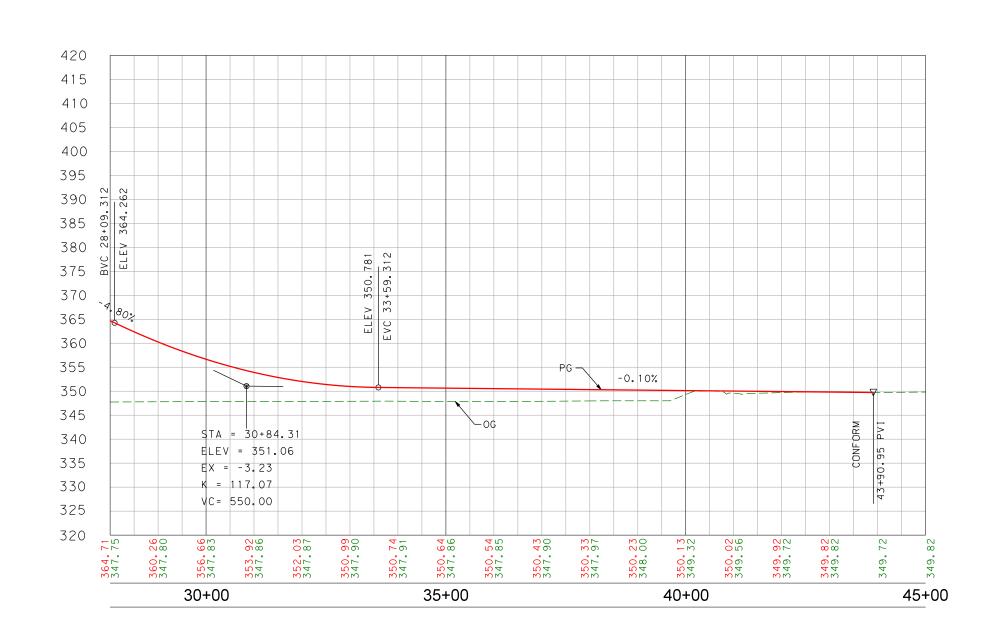

PROFILE
"MER" LINE

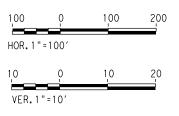

REV	DATE	BY	СНК	APP	DESCRIPTION	DATE	
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NOT FOR
CONSTRUCTION






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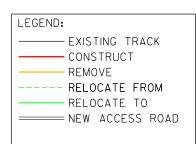
THROUGH WASCO SUBSECTION
ALIGNMENT WS1
GRADE SEPERATION PROFILE
MERCED AVE

CONTRACT NO.
DRAWING NO. 2.01.02_28
AS SHOWN
SHEET NO. 28 OF 28

# BNSF RAILWAY REALIGNMENT





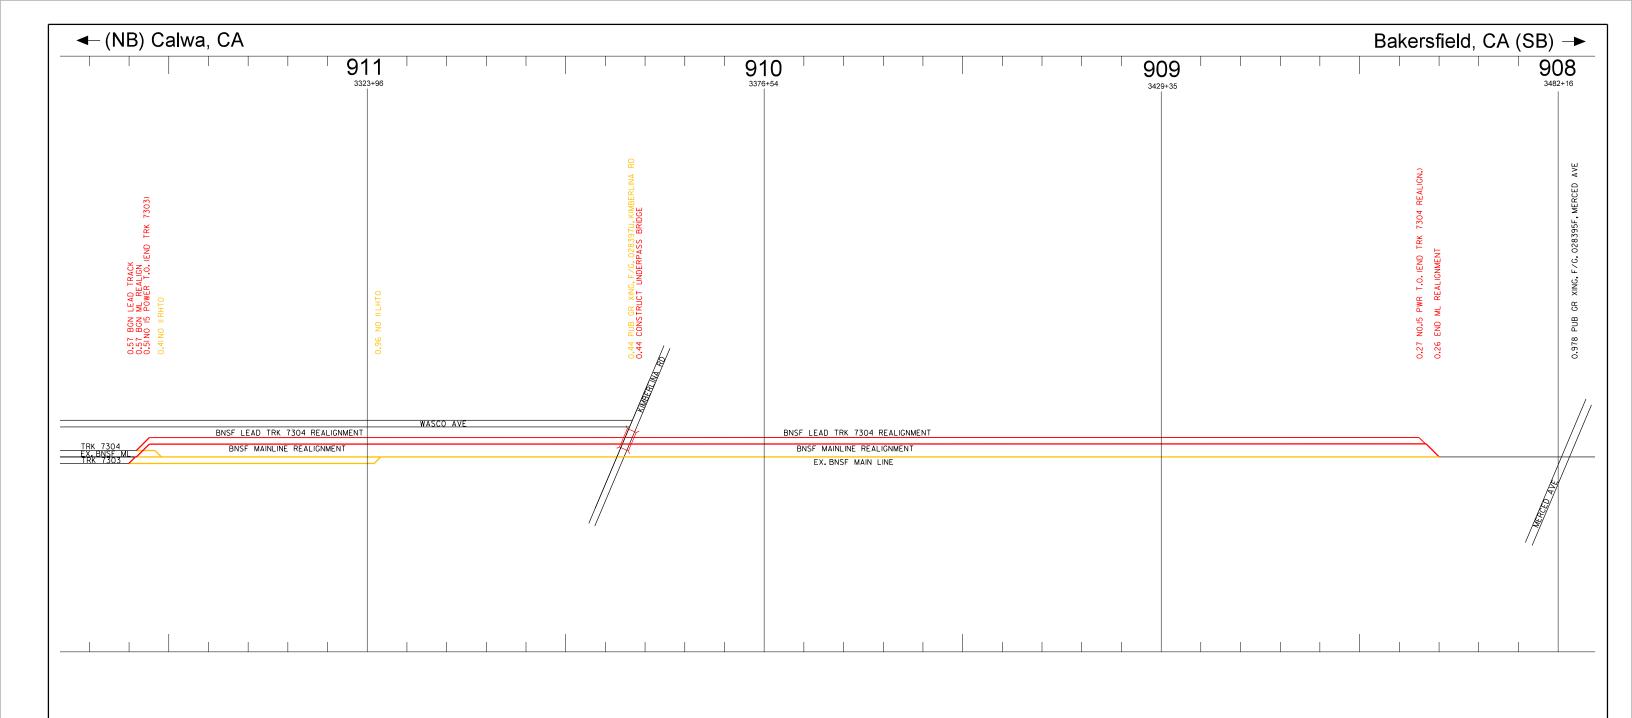

SCOPE OF WORK:
REALIGN MAIN AND LEAD TRACK 7304.
INSTALL 2 NO.15 TURNOUTS
CONSTRUCT I BRIDGE UNDERPASS
REMOVE PORTION OF TRACKS 7303, 7304,
2 TURNOUTS

NOTES ON OPERATIONS:
TYPE OF OPERATION IS CTC
SIGNAL FACILITIES TO BE RELOCATED TO
ACCOMODATE TRACK REALIGNMENT
REDUCE CLEAR LENGTH ON TRACKS
7303 STORAGE.



- PRELIMINARY - SUBJECT TO RAILROAD / STAKEHOLDER REVIEW



CALIFORNIA DIVISION BAKERSFIELD SUBDIVISION LINE SEGMENT 7200

00	10/29/15				CONCEPTUAL DESIGN - BID SUBMITTAL	DESIGNED BY	
01	11/04/15				DESIGN REVISIONS	DRAWN BY	
						CHECKED BY	1
						IN CHARGE	-
						DATE	
REV	DATE	ВҮ	СНК	APP	DESCRIPTION	DATE	

ONLY FOR
BIDDING PURPOSES
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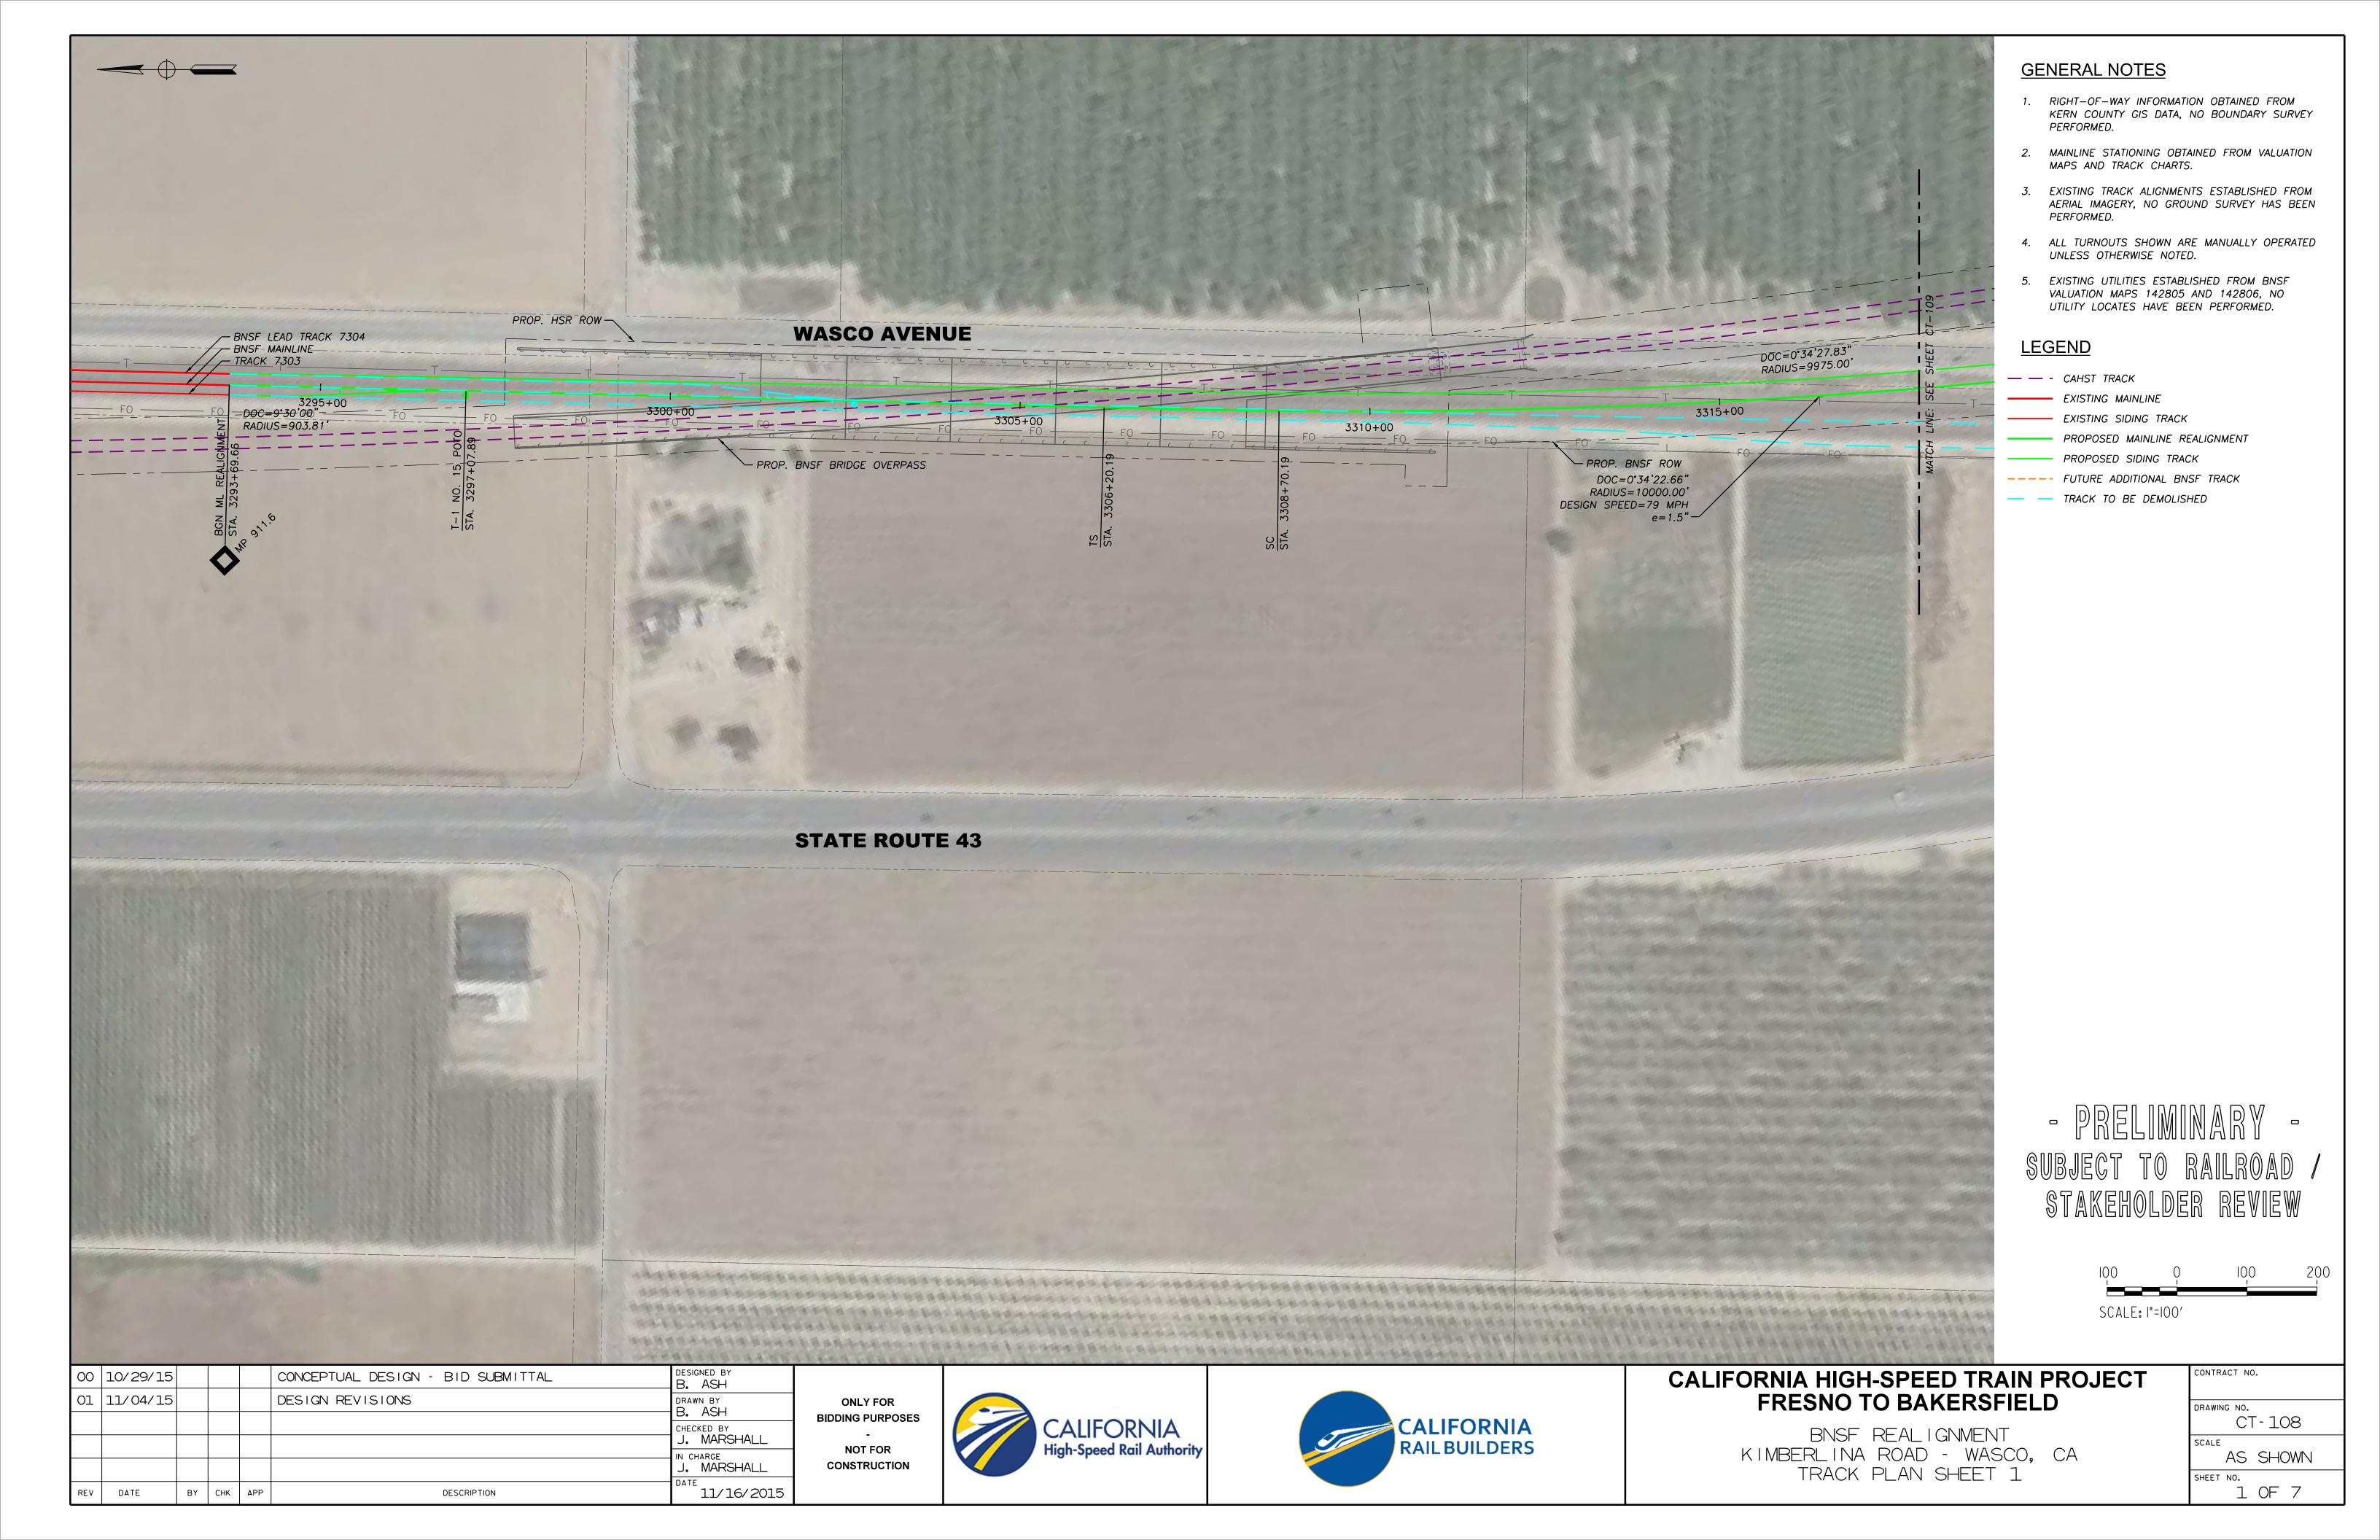






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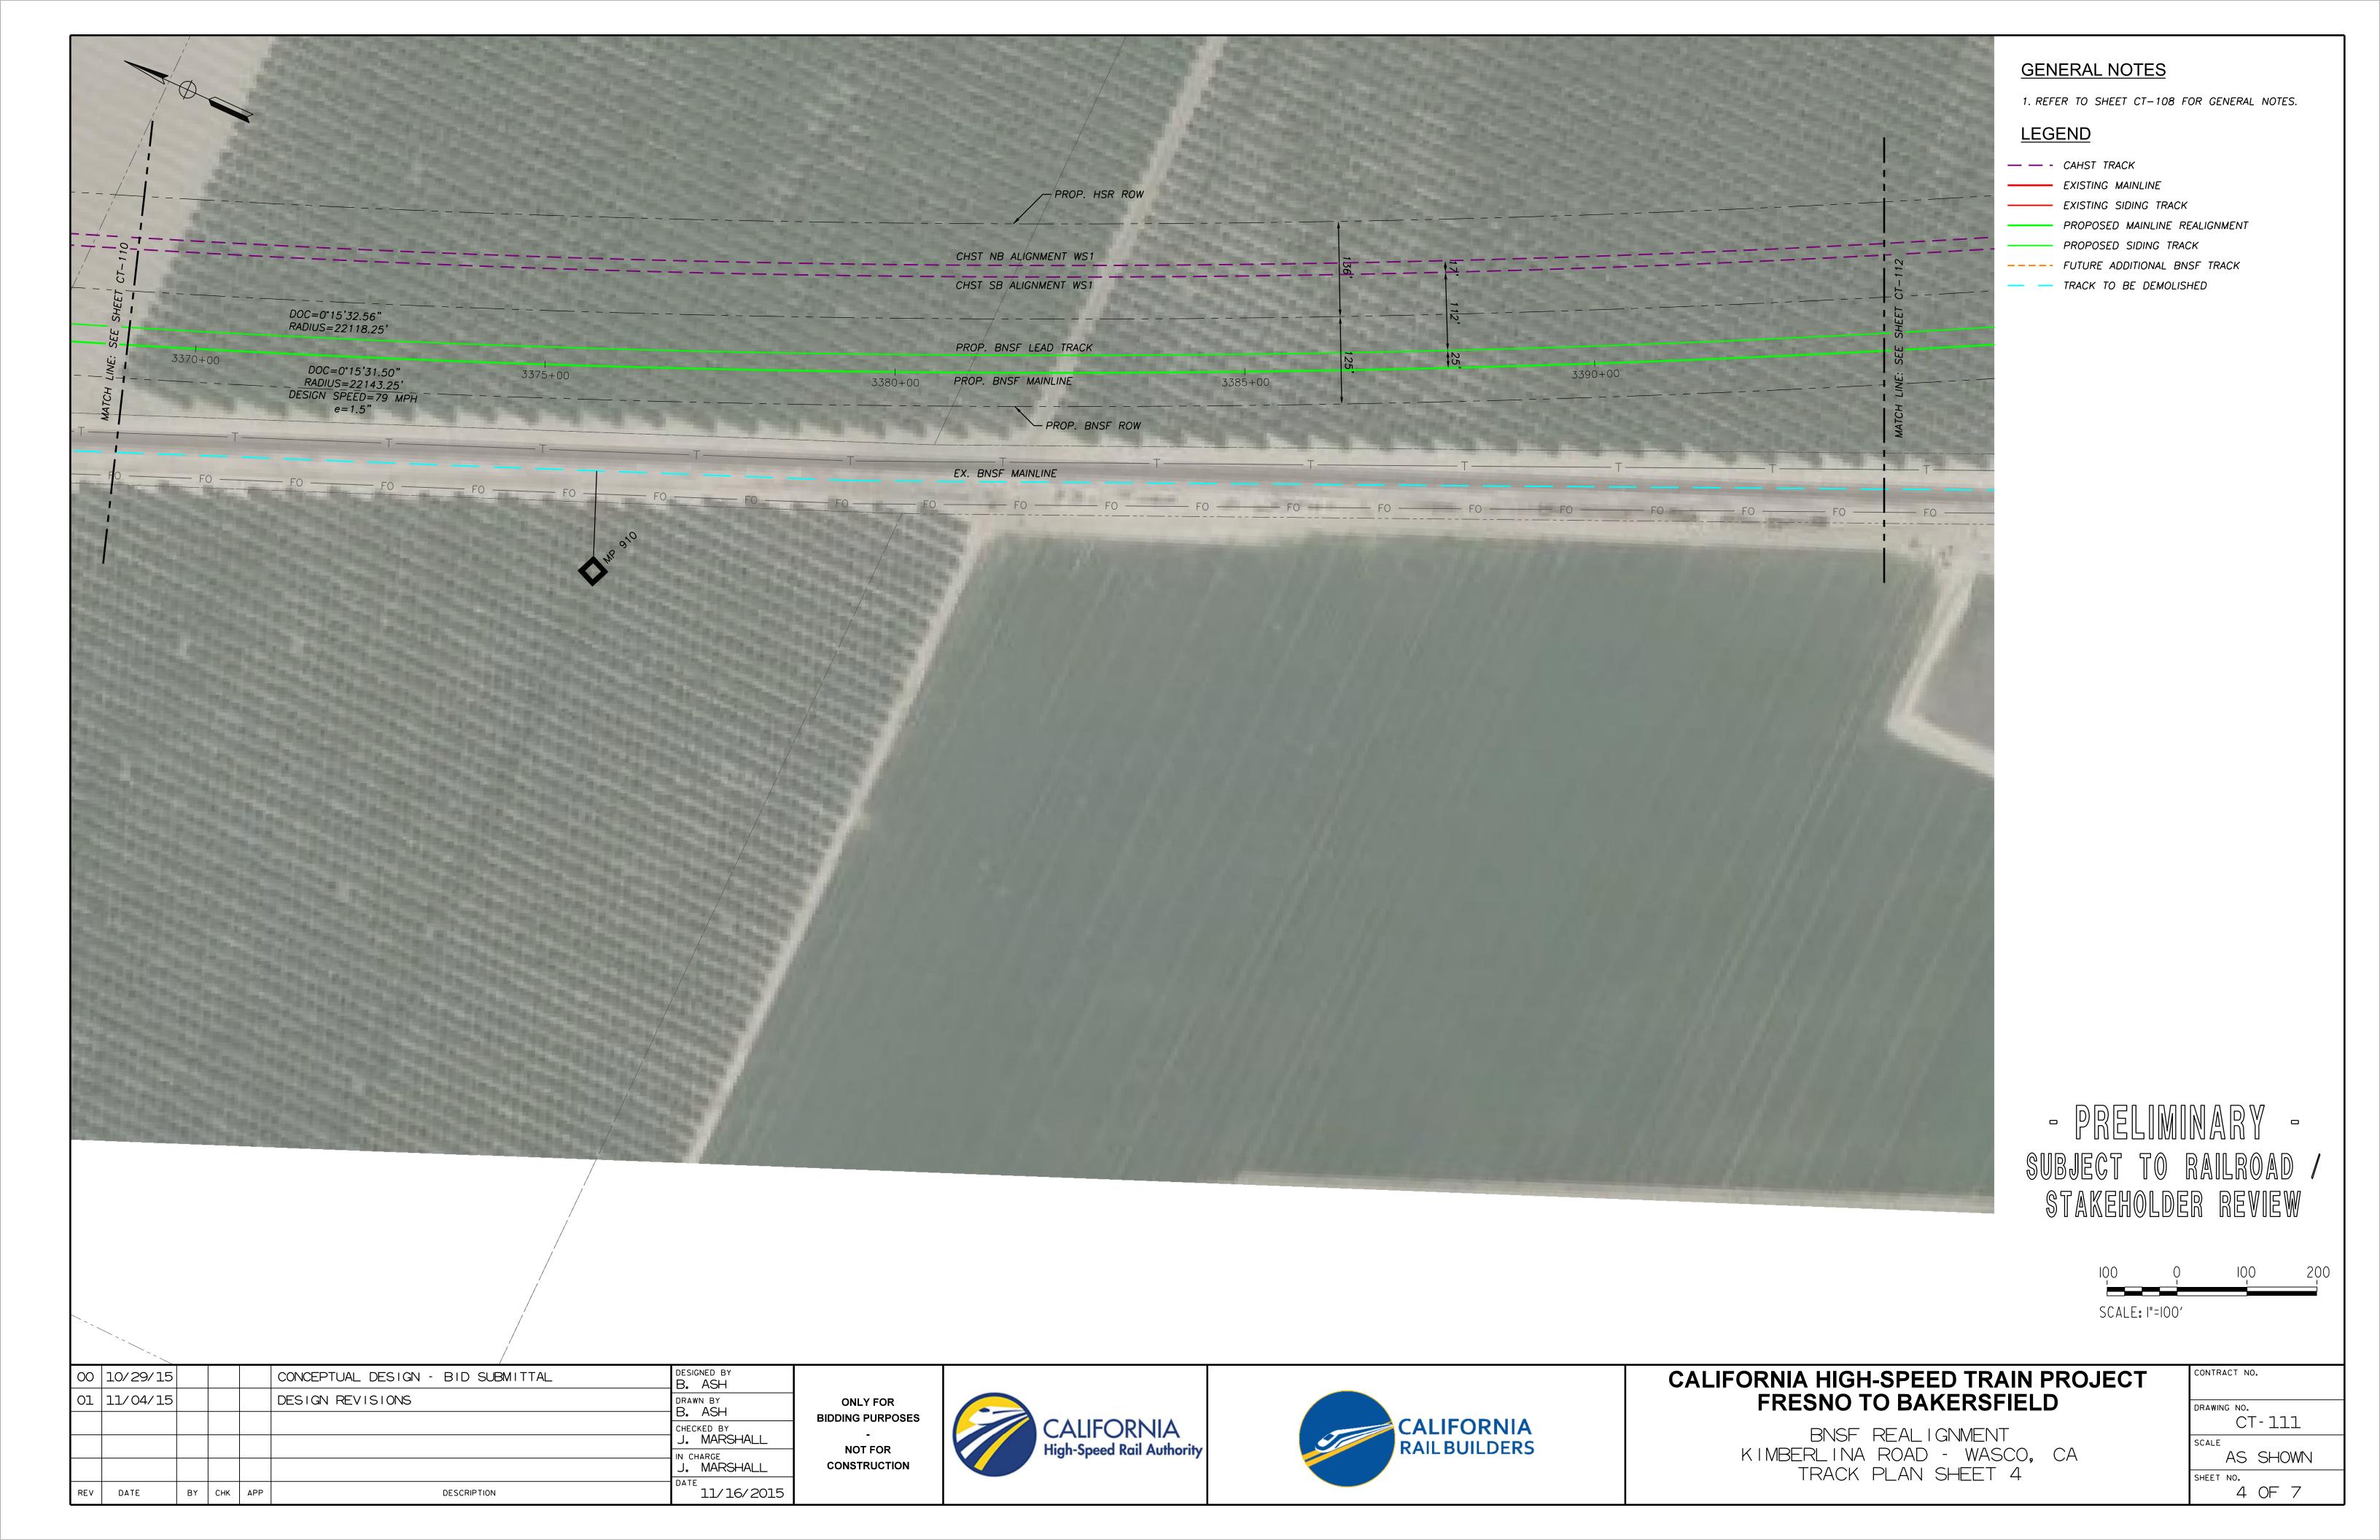
KIMBERLINA ROAD BNSF REALIGNMENT WASCO, CA MP 907.8 TO 911.8


CONTRACT NO.
DRAWING NO.
SCALE
N. T. S.







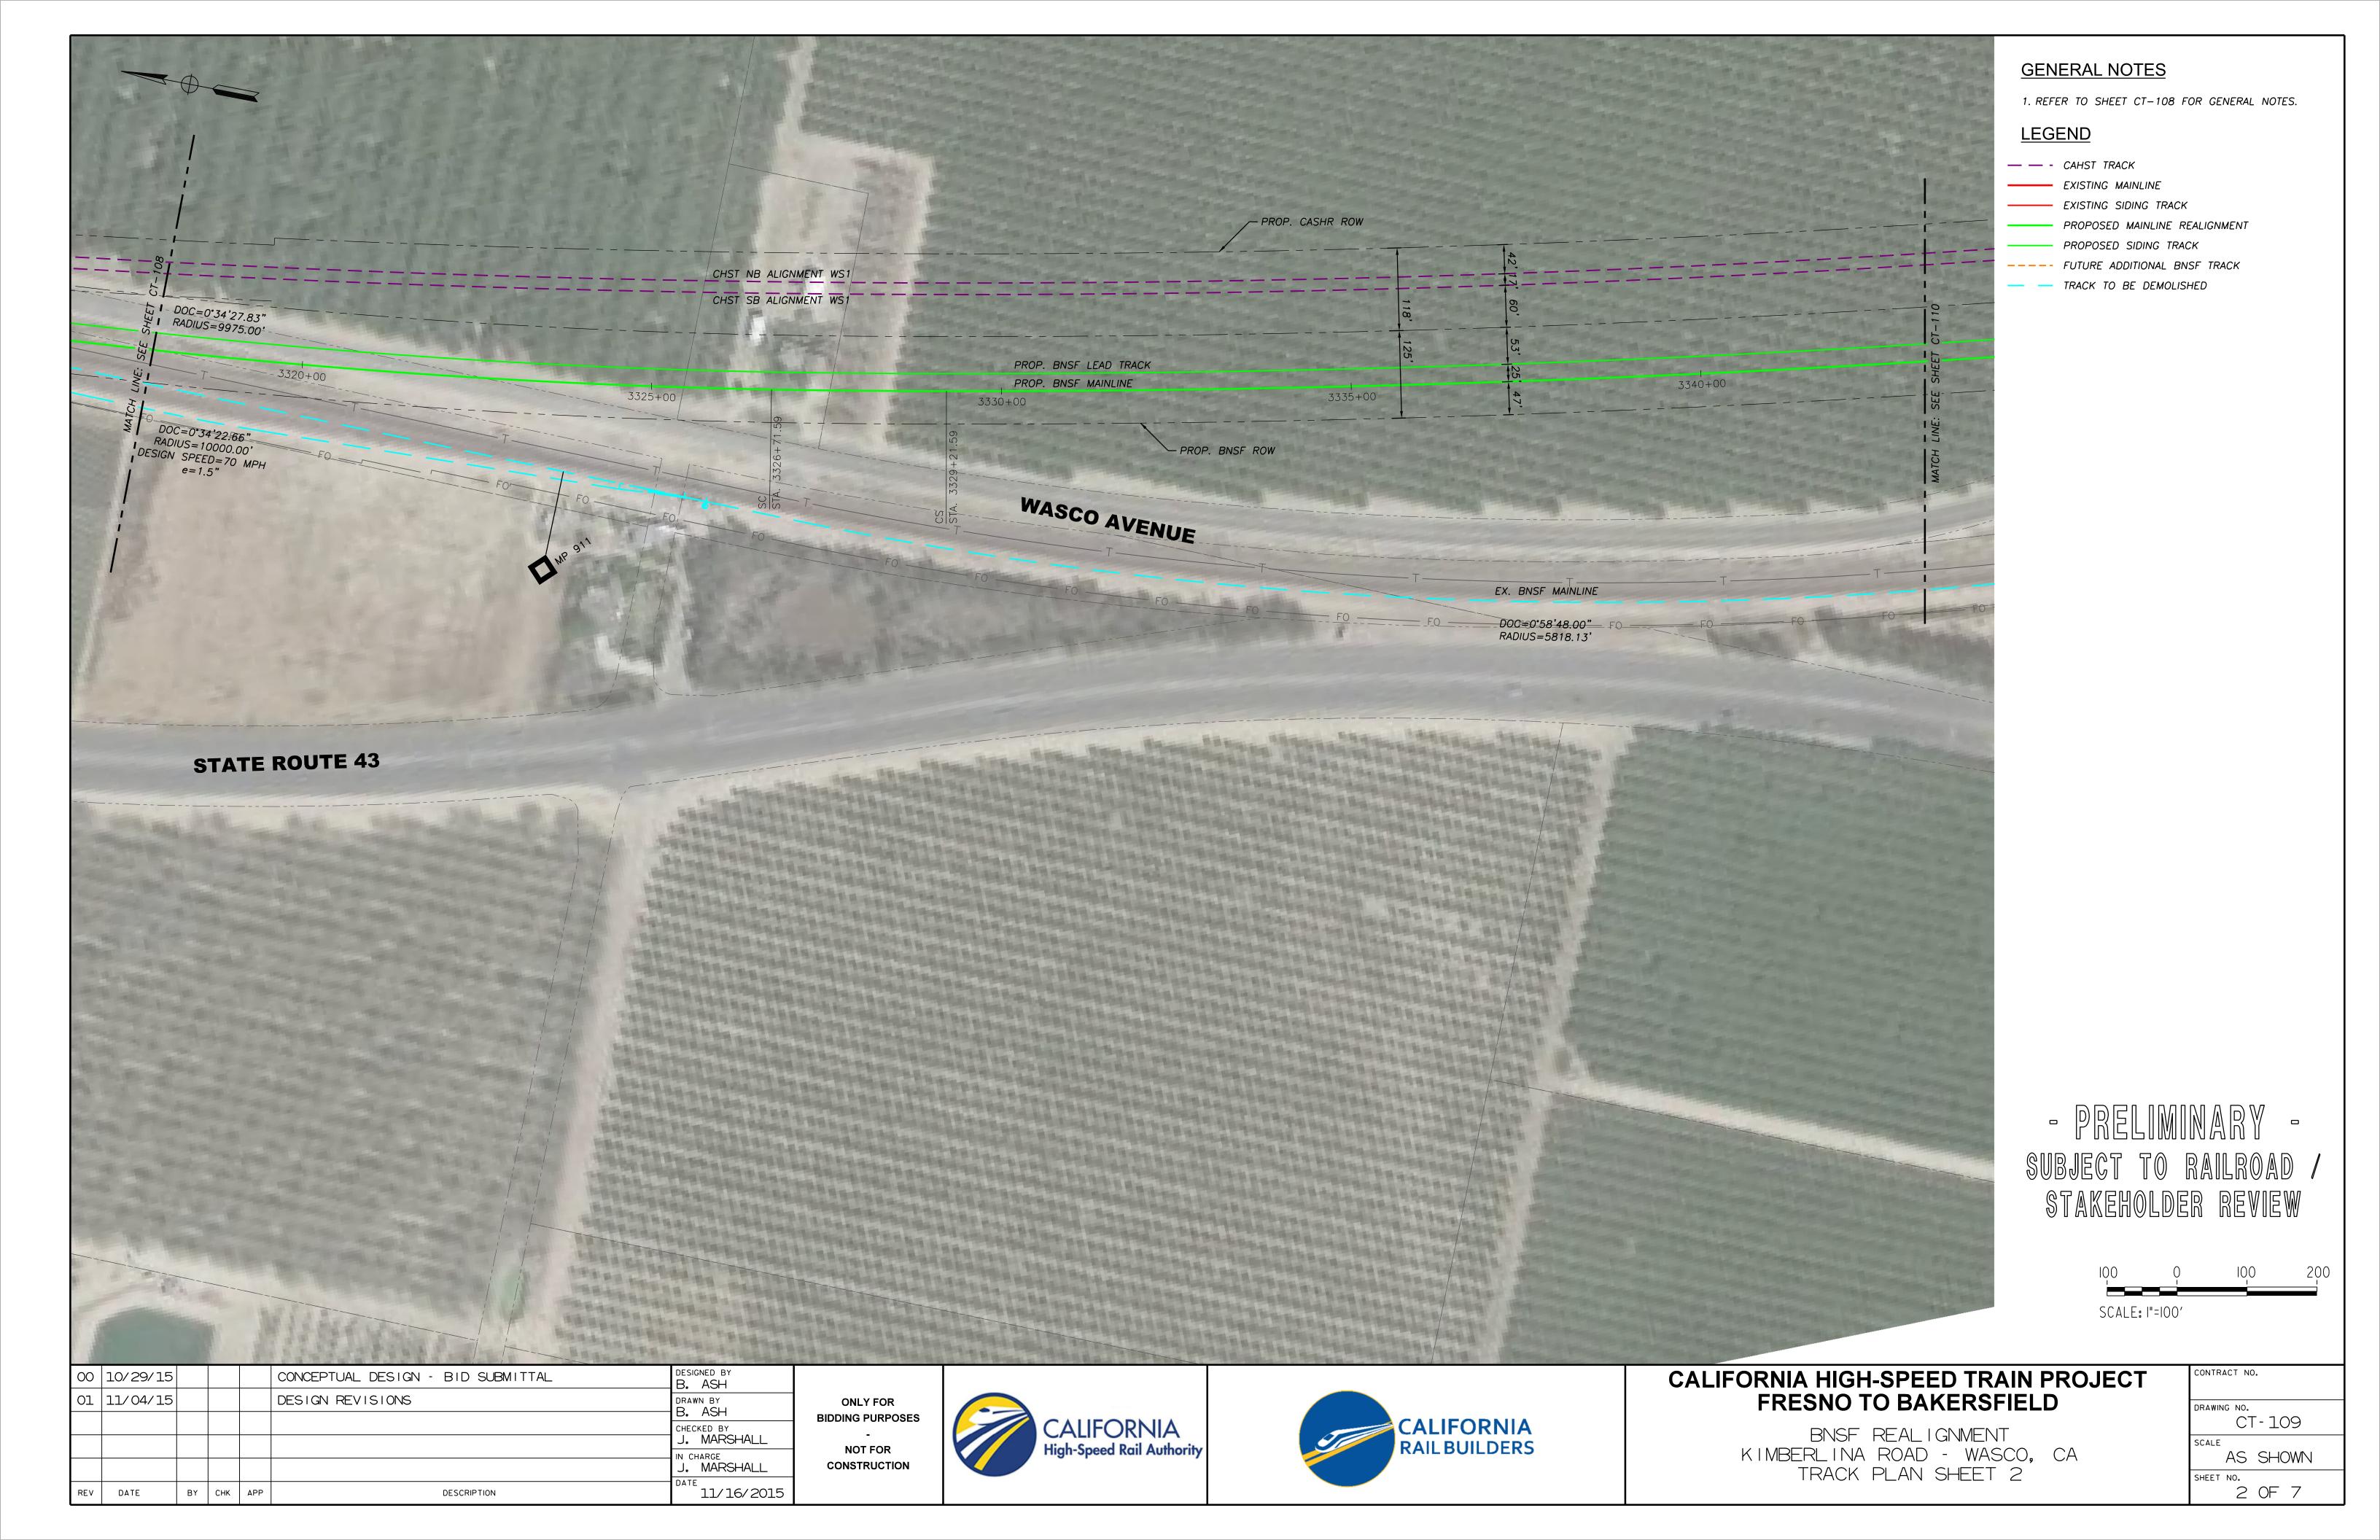

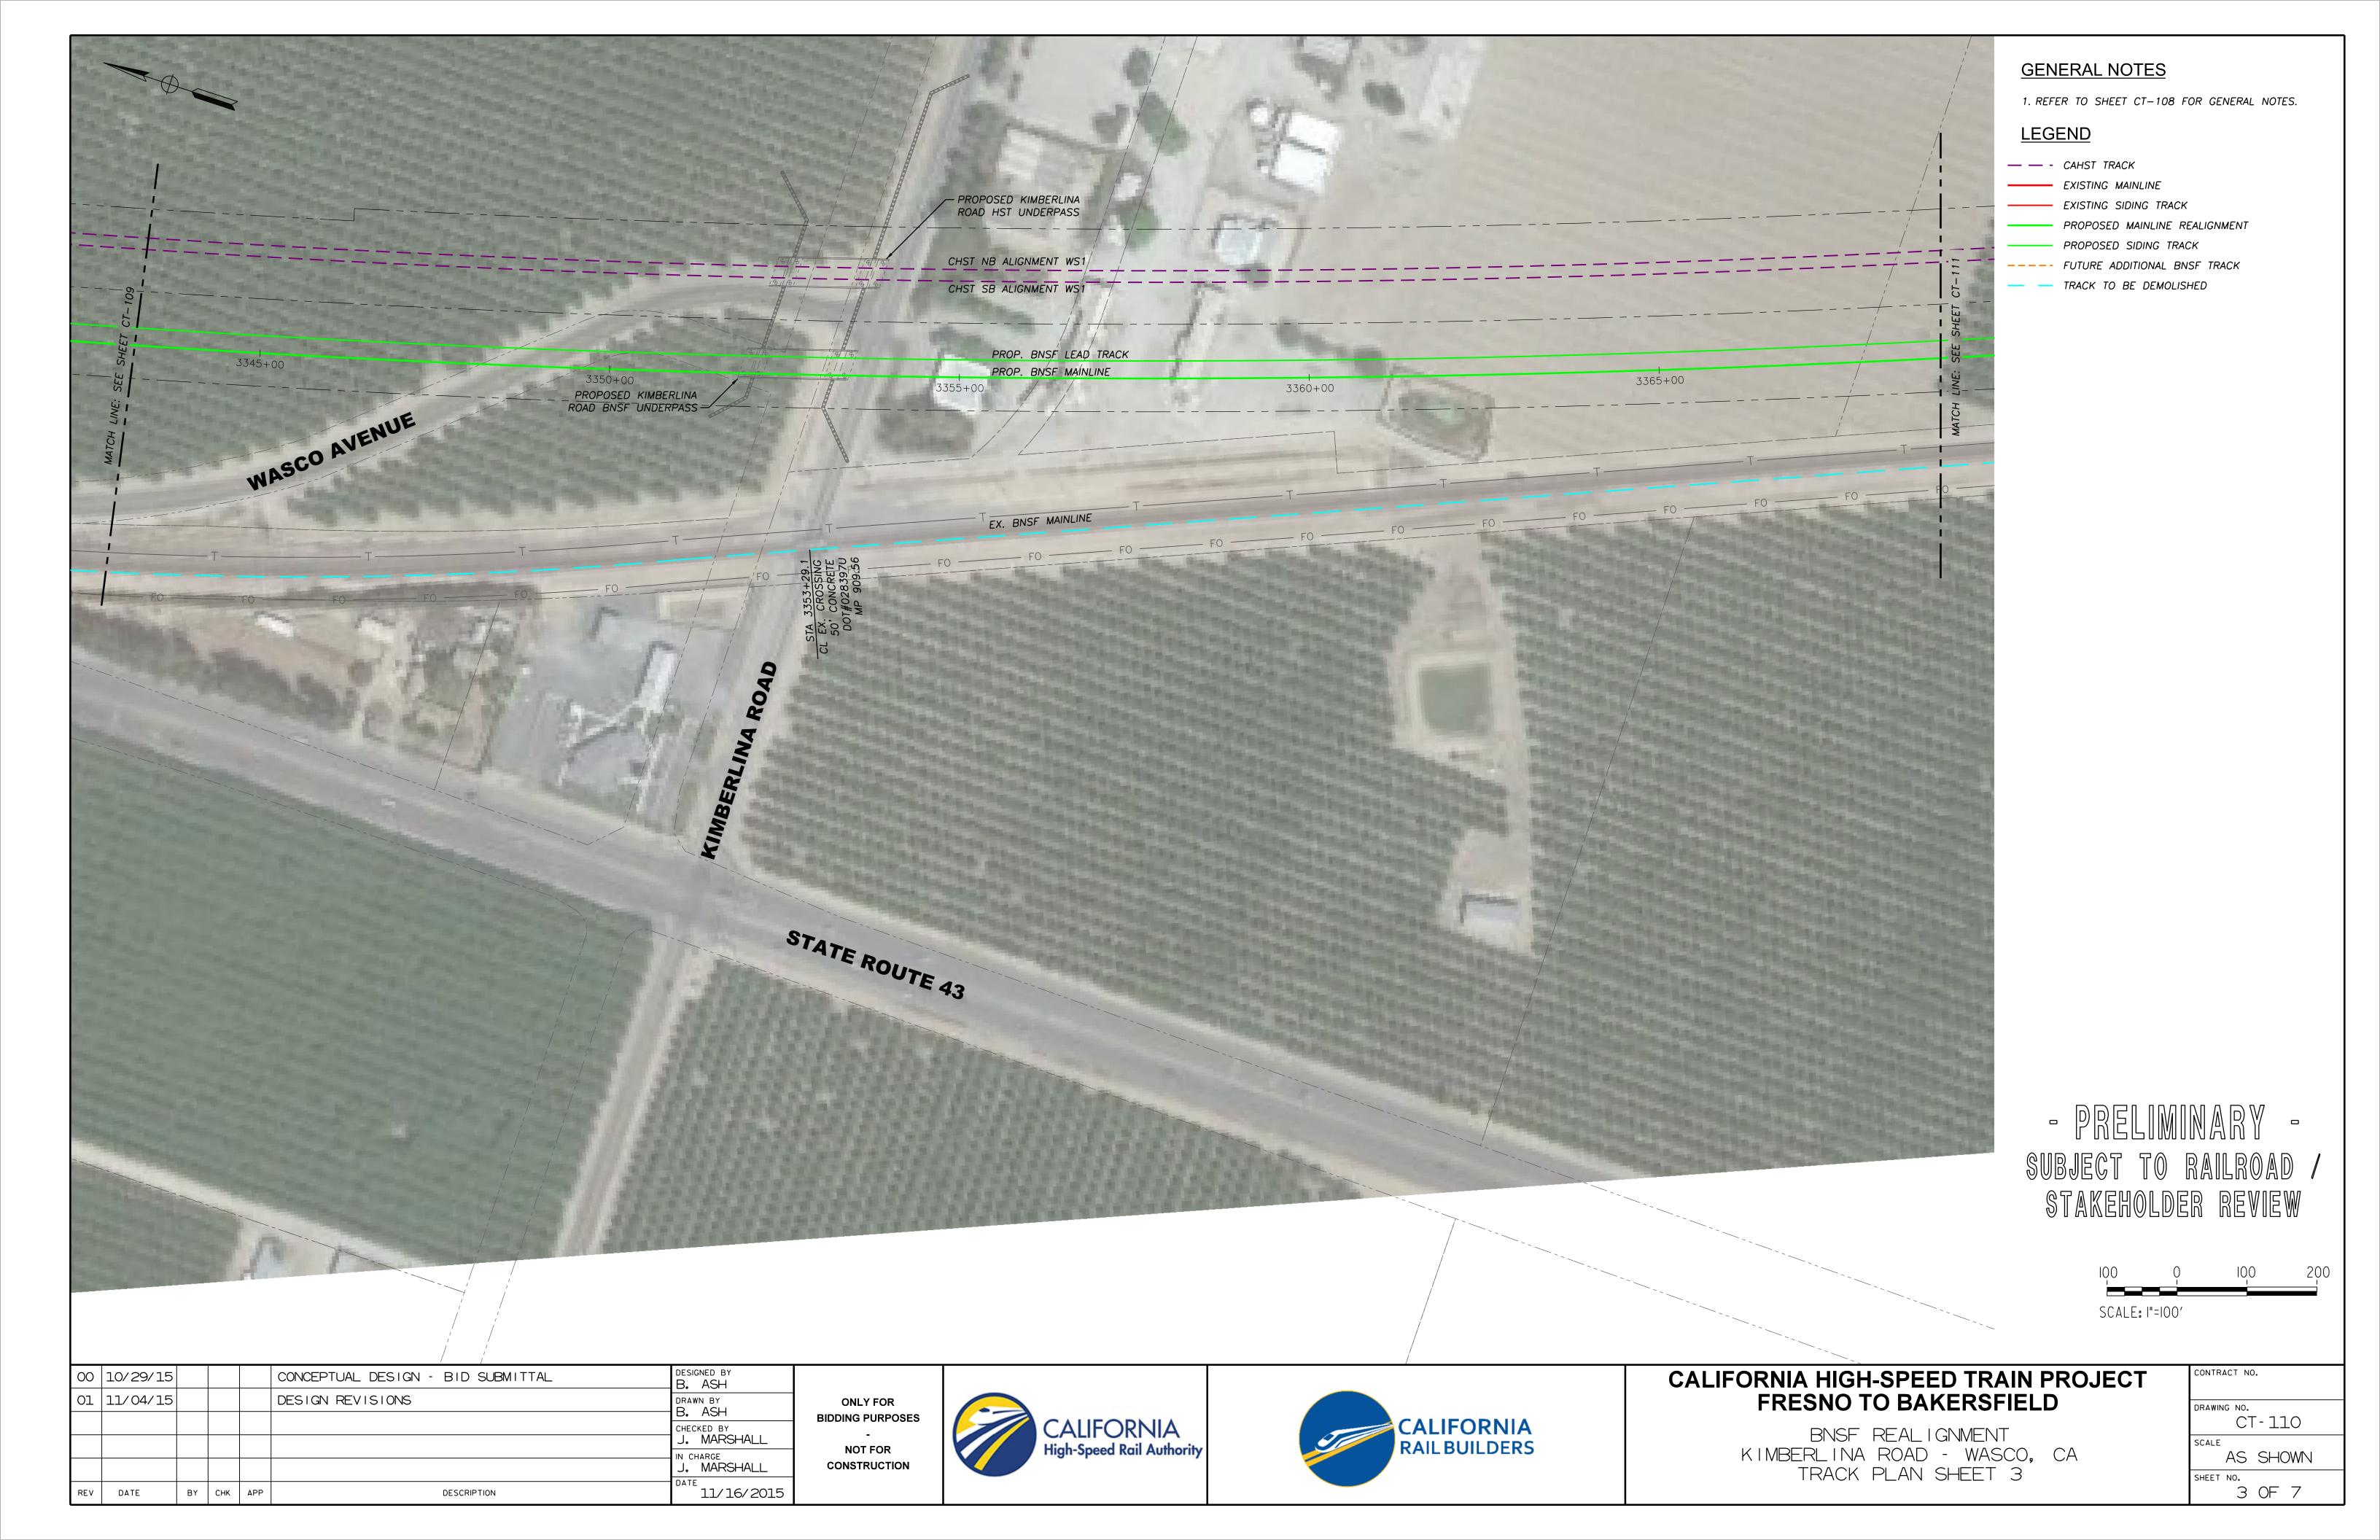

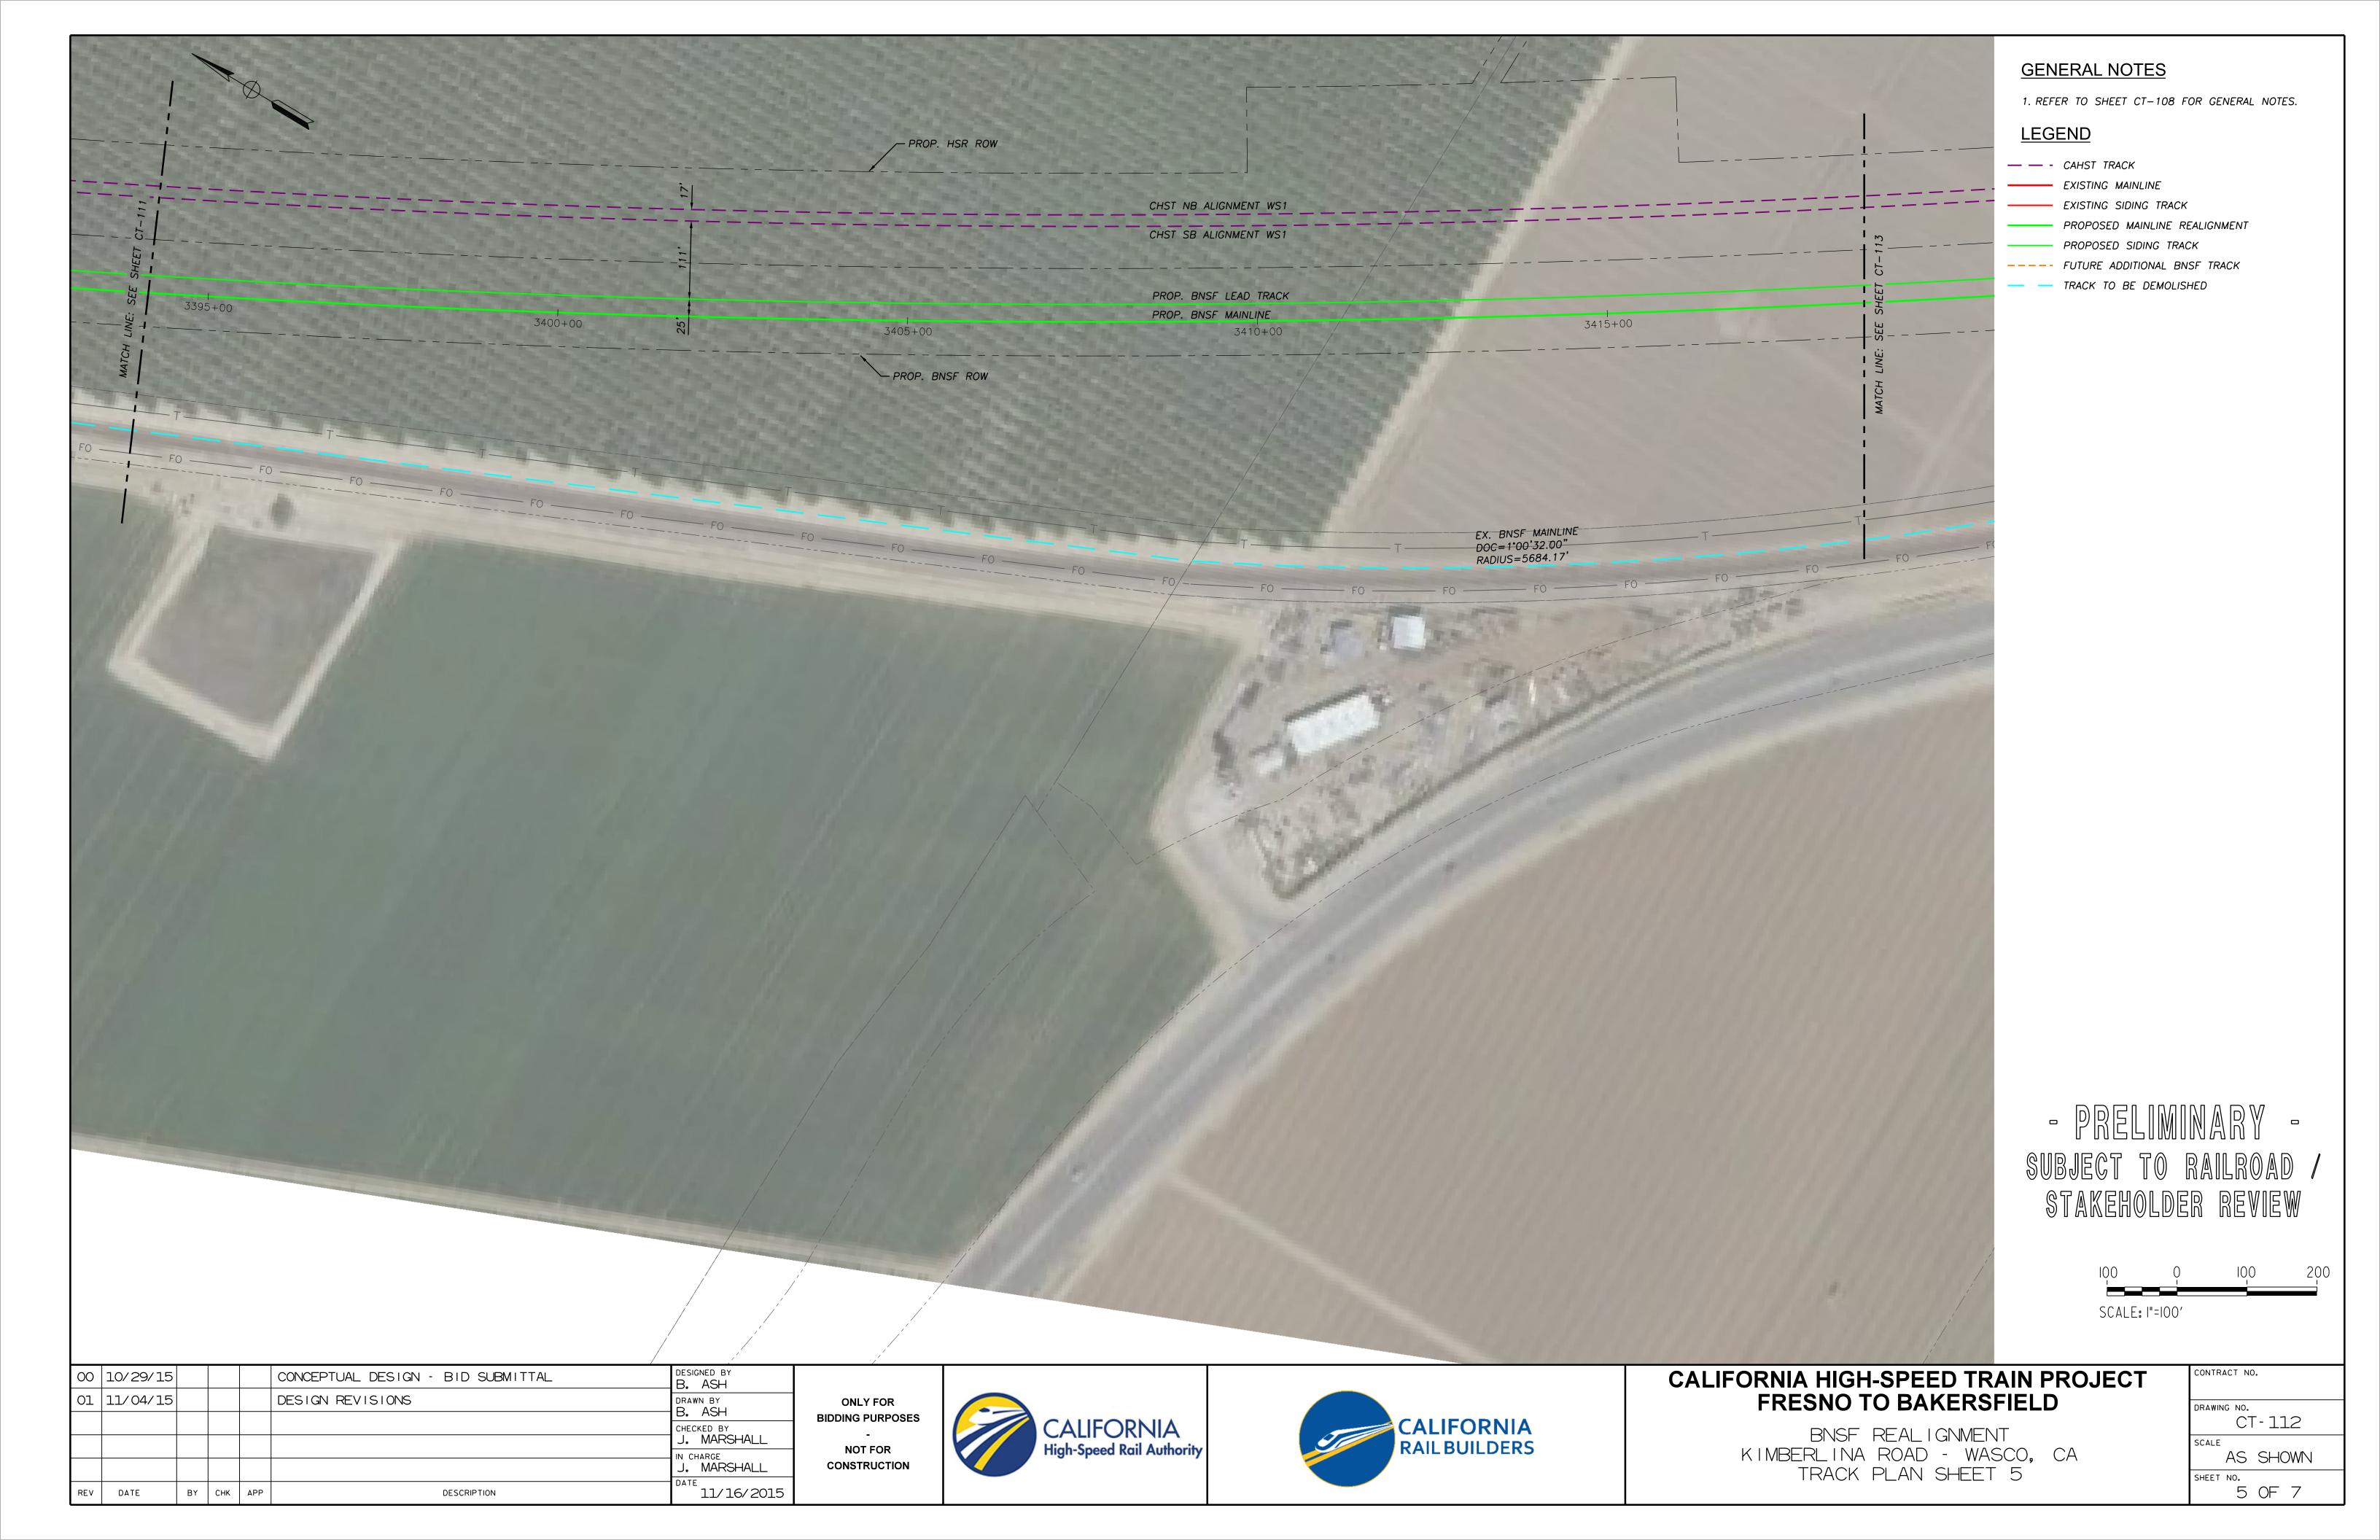

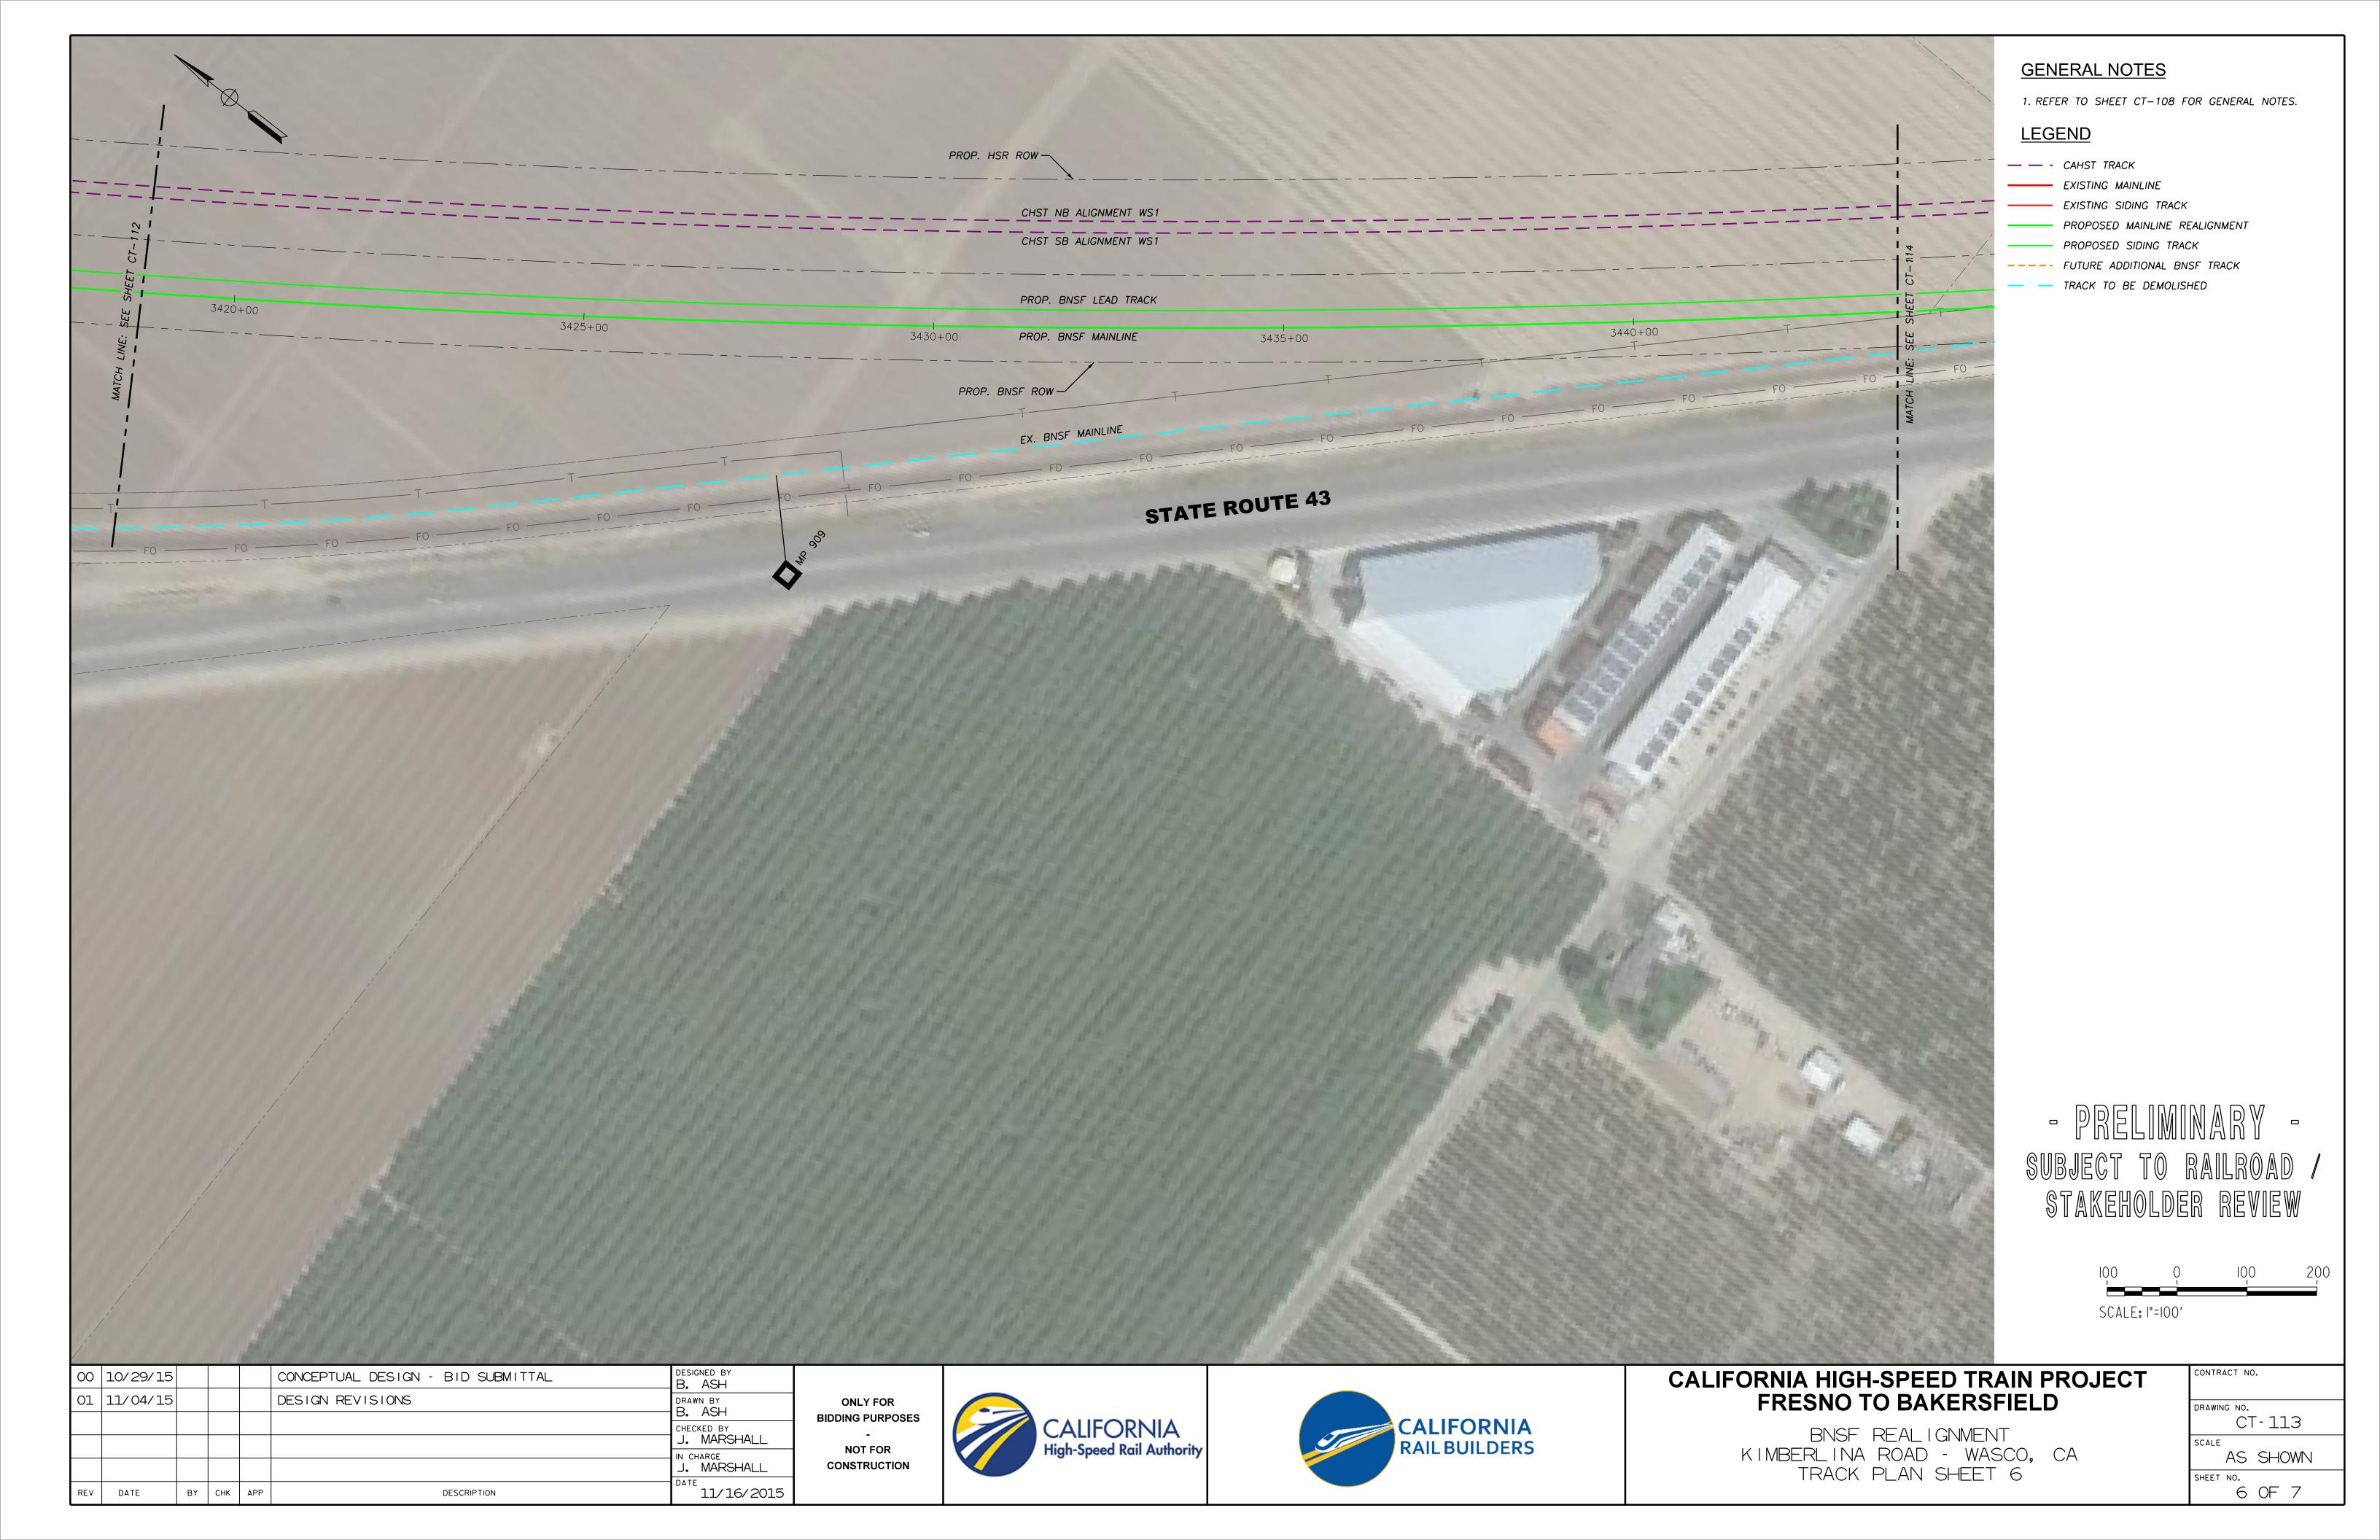

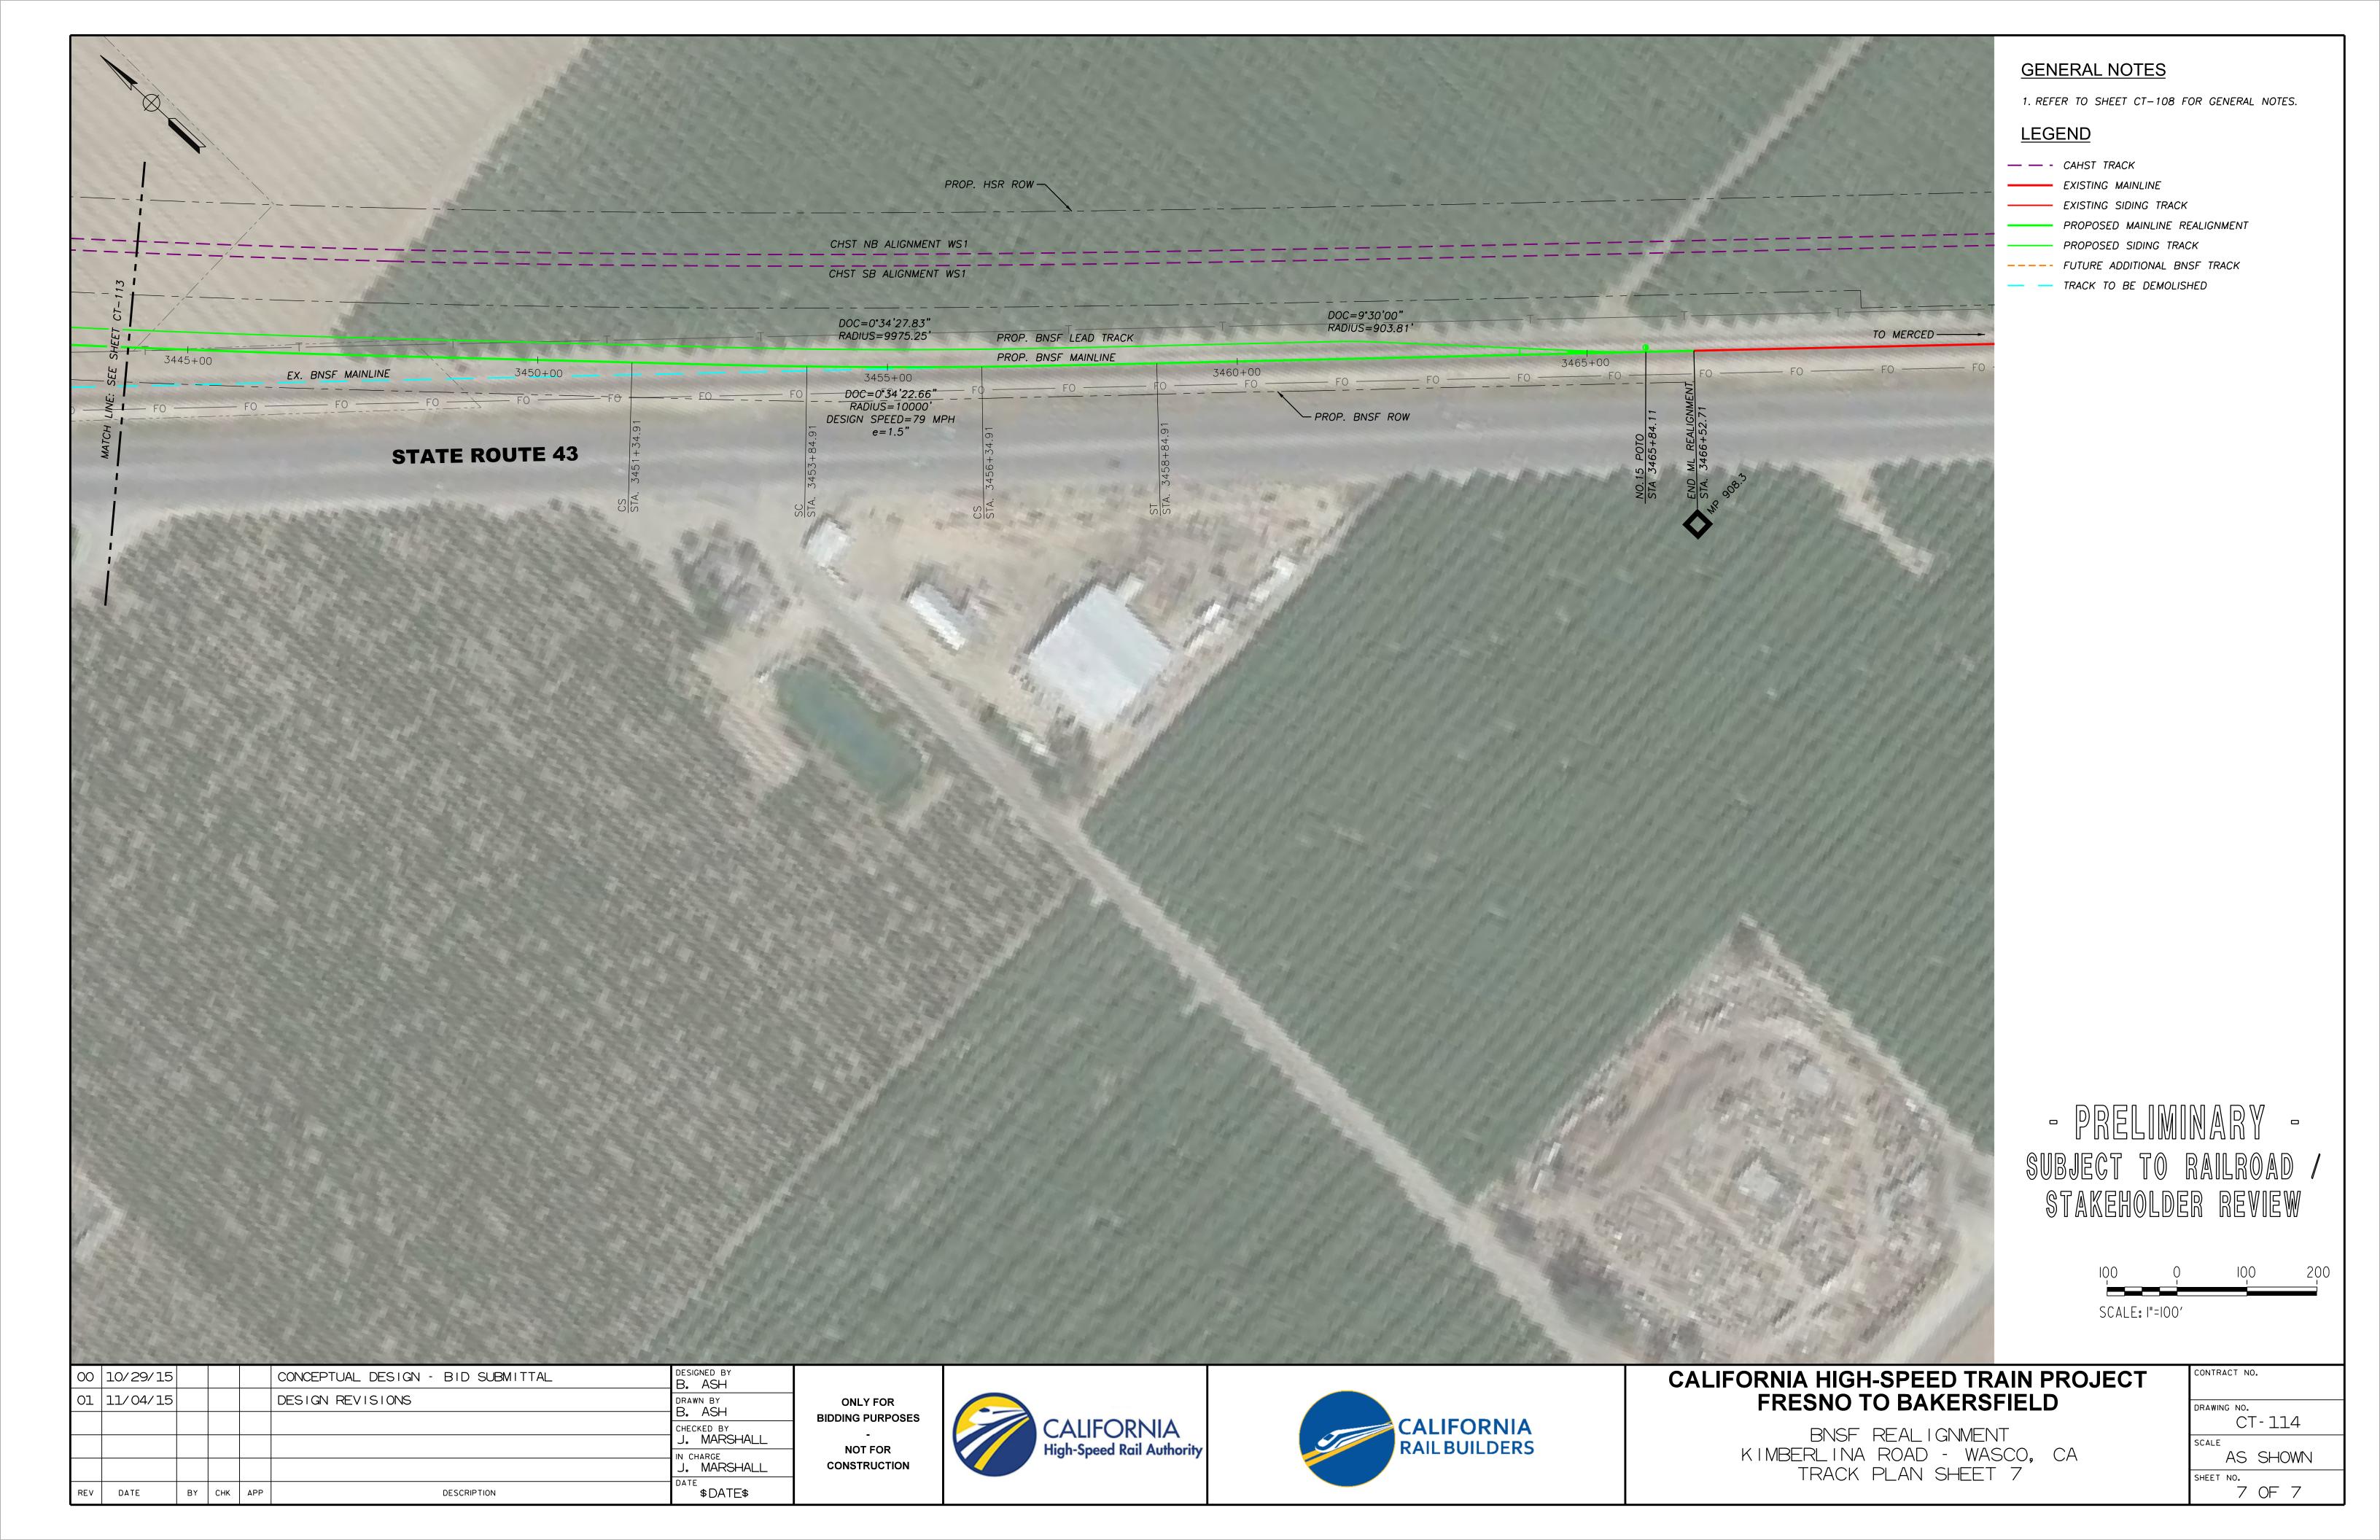

# STRUCTURES



#### INDEX - STRUCTURES - HIGH-SPEED RAIL TRACK

DRAWING No.	REV No.	DRAWING DESCRIPTION	SHEET NO
2.02.01_01		ALLENSWORTH BYPASS SUBSECTION - ALIGNMENT A1 - GARCES HWY - PLAN AND ELEVATION	1 OF 16
2.02.01_02		ALLENSWORTH BYPASS SUBSECTION - ALIGNMENT A1 - POND RD - PLAN AND ELEVATION	2 OF 16
2.02.01_03		ALLENSWORTH BYPASS SUBSECTION - ALIGNMENT A1 - PETERSON RD - PLAN AND ELEVATION	3 OF 16
2.02.01_04		POSO CREEK SUBSECTION - ALIGNMENT L1 - POSO CREEK BRIDGE - PLAN AND ELEVATION	4 OF 16
2.02.01_05		THROUGH WASCO SUBSECTION - ALIGNMENT WS1 - SUNNYGEM BRIDGE - PLAN AND ELEVATION	5 OF 16
2.02.01_06		THROUGH WASCO SUBSECTION - ALIGNMENT WS1 - STATE ROUTE 46 UNDERPASS - PLAN AND ELEVATION	6 OF 16
2.02.01_07		THROUGH WASCO SUBSECTION - ALIGNMENT WS1 - 6TH STREET UNDERPASS - PLAN AND ELEVATION	7 OF 16
2.02.01_08		THROUGH WASCO SUBSECTION - ALIGNMENT WS1 - PEDESTRIAN UNDERPASS - PLAN AND ELEVATION	8 OF 16
2.02.01_09		THROUGH WASCO SUBSECTION - ALIGNMENT WS1 - POSO AVE UNDERPASS - PLAN AND ELEVATION	9 OF 16
2.02.01_10		THROUGH WASCO SUBSECTION - ALIGNMENT WS1 - J STREET UNDERPASS - PLAN AND ELEVATION	10 OF 16
2.02.01_11		THROUGH WASCO SUBSECTION - ALIGNMENT WS1 - WASCO VIADUCT - PLAN AND ELEVATION (I)	11 OF 16
2.02.01_12		THROUGH WASCO SUBSECTION - ALIGNMENT WS1 - WASCO VIADUCT - PLAN AND ELEVATION (II)	12 OF 16
2.02.01_13		THROUGH WASCO SUBSECTION - ALIGNMENT WS1 - WASCO VIADUCT - PLAN AND ELEVATION (III)	13 OF 16
2.02.01_14		THROUGH WASCO SUBSECTION - ALIGNMENT WS1 - WASCO VIADUCT - TYPICAL SECTIONS - DETAILS	14 OF 16
2.02.01_15		THROUGH WASCO SUBSECTION - ALIGNMENT WS1 - KIMBERLINA RD UNDERPASS - PLAN AND ELEVATION	15 OF 16
2.02.01_16		THROUGH WASCO SUBSECTION - ALIGNMENT WS1 - KIMBERLINA RD BNSF UNDERPASS - PLAN AND ELEVATION	16 OF 16

#### INDEX - STRUCTURES - ROADWAYS

DRAWING No.	REV No.	DRAWING DESCRIPTION	SHEET NO
2.02.02_01		THROUGH WASCO SUBSECTION - ALIGNMENT WS1 - OVERHEAD PLANNING STUDY - MCCOMBS AVE	1 OF 5
2.02.02_02		THROUGH WASCO SUBSECTION - ALIGNMENT WS1 - OVERHEAD PLANNING STUDY - ABUTMENTS AND BENTS - MCCOMBS AVE	2 OF 5
2.02.02_03		THROUGH WASCO SUBSECTION - ALIGNMENT WS1 - OVERHEAD PLANNING STUDY - MERCED AVE (I)	3 OF 5
2.02.02_04		THROUGH WASCO SUBSECTION - ALIGNMENT WS1 - OVERHEAD PLANNING STUDY - MERCED AVE (II)	4 OF 5
2.02.02_05		THROUGH WASCO SUBSECTION - ALIGNMENT WS1 - OVERHEAD PLANNING STUDY - ABUTMENTS AND BENTS - MERCED AVE	5 OF 5

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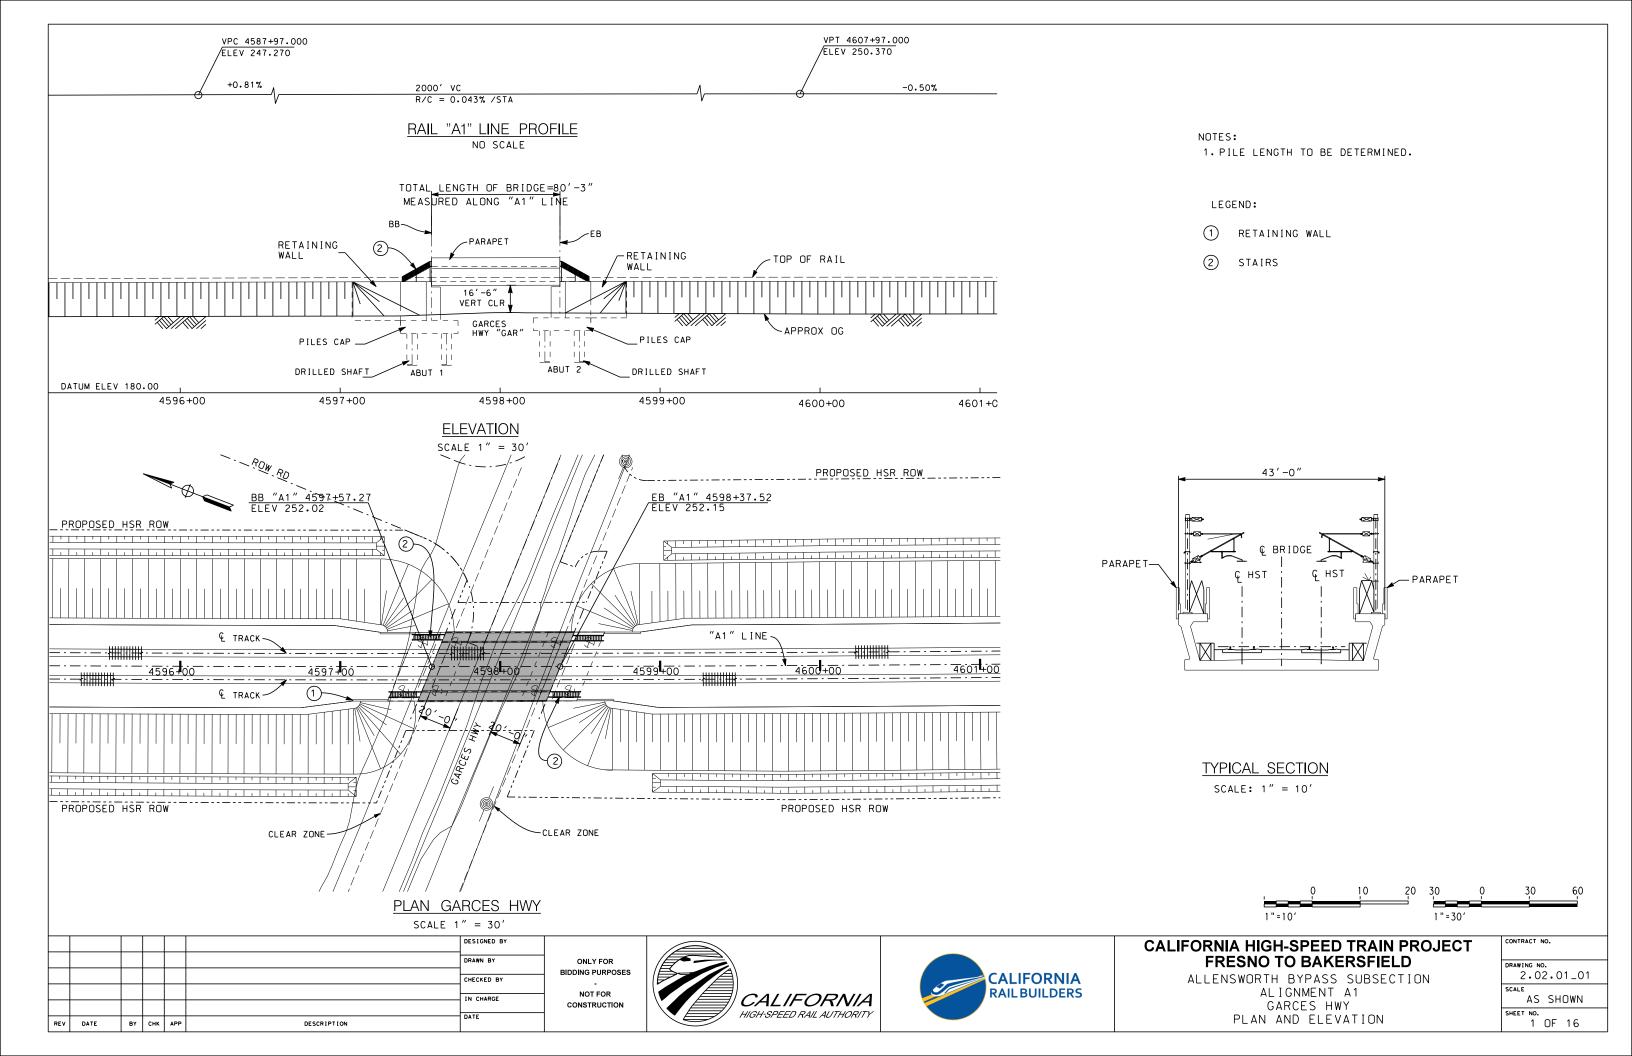
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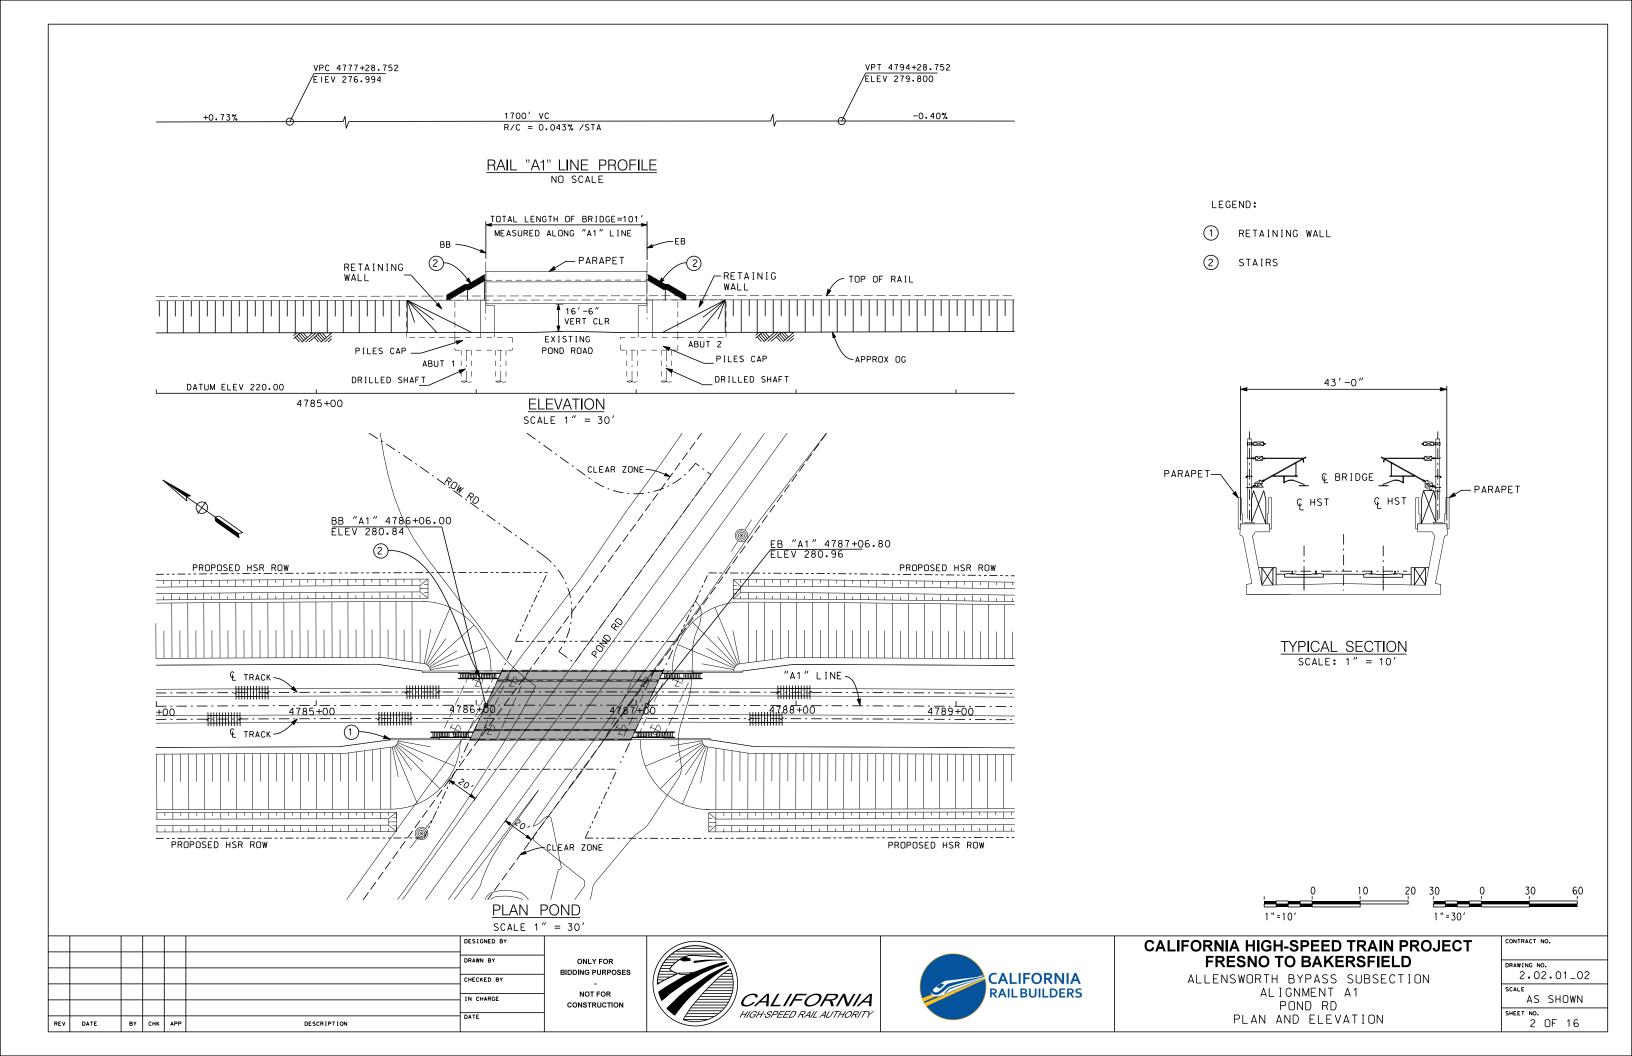
INDEX OF DRAWINGS STRUCTURES


CONTRACT NO.
DRAWING NO.
2.02
SCALE
NO SCALE
SHEET NO.
1 OF 1

# STRUCTURES HIGH-SPEED RAIL TRACK







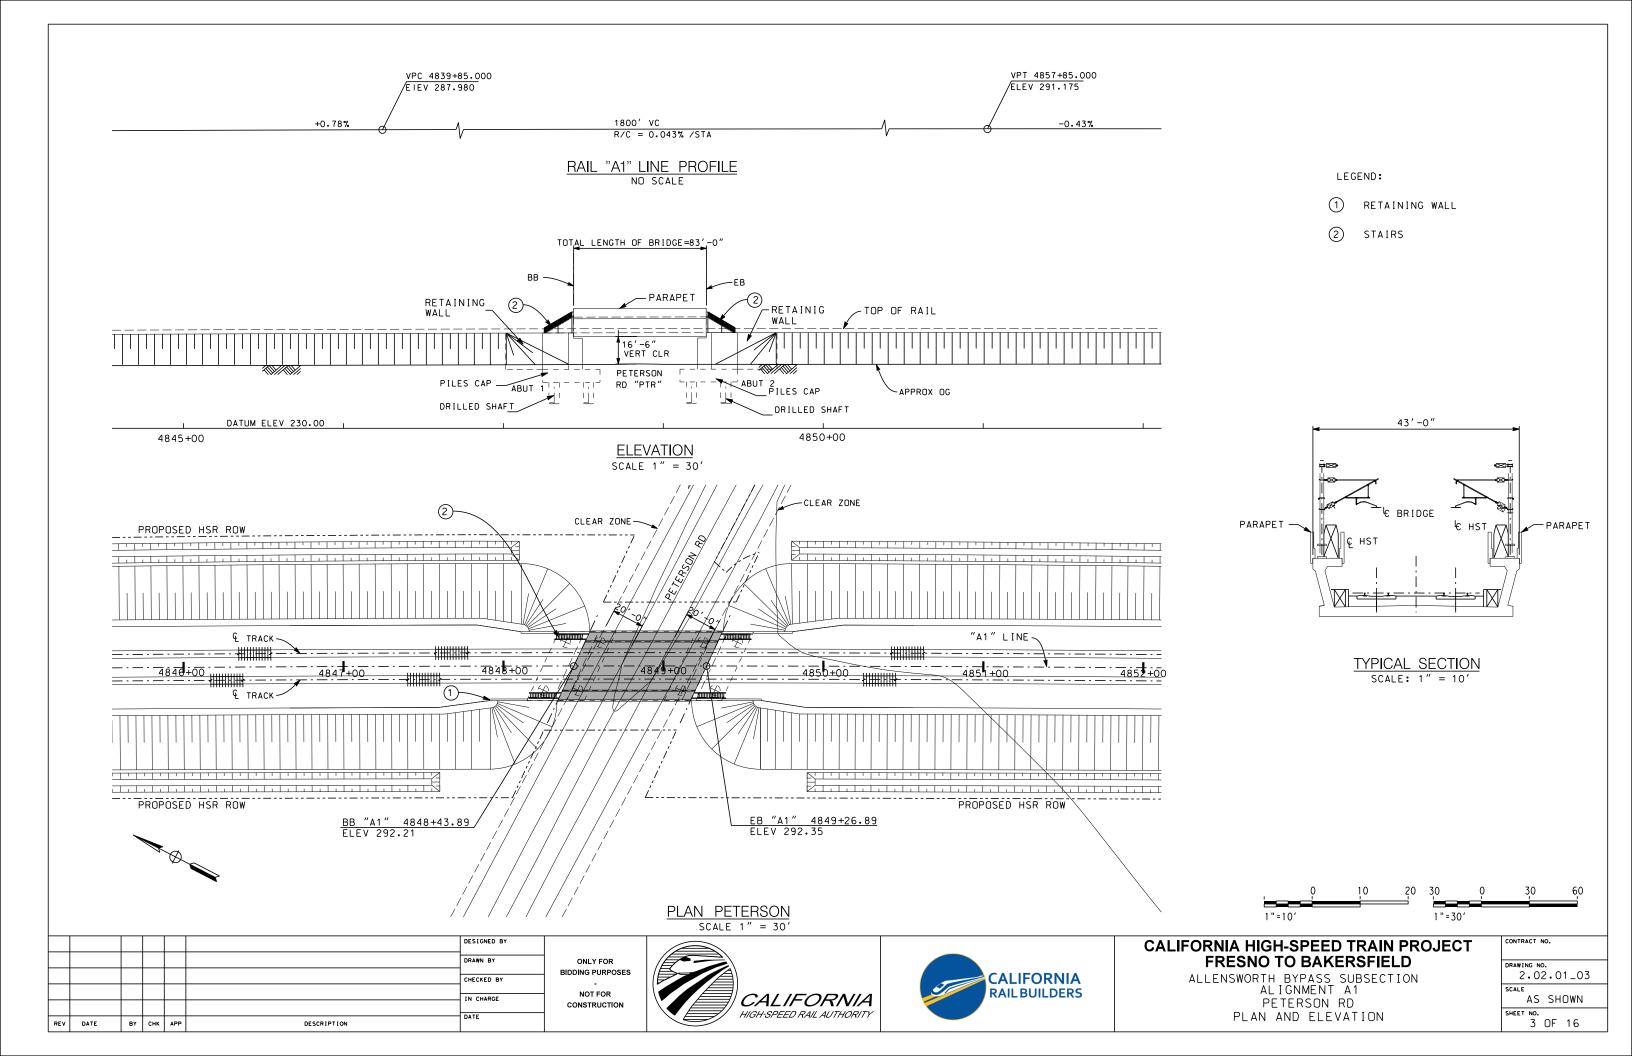


REV DATE

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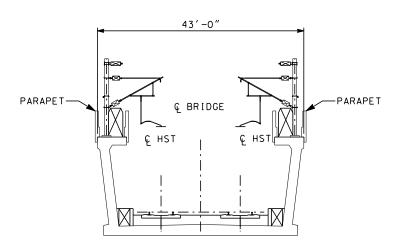
DESCRIPTION

PLAN AND ELEVATION

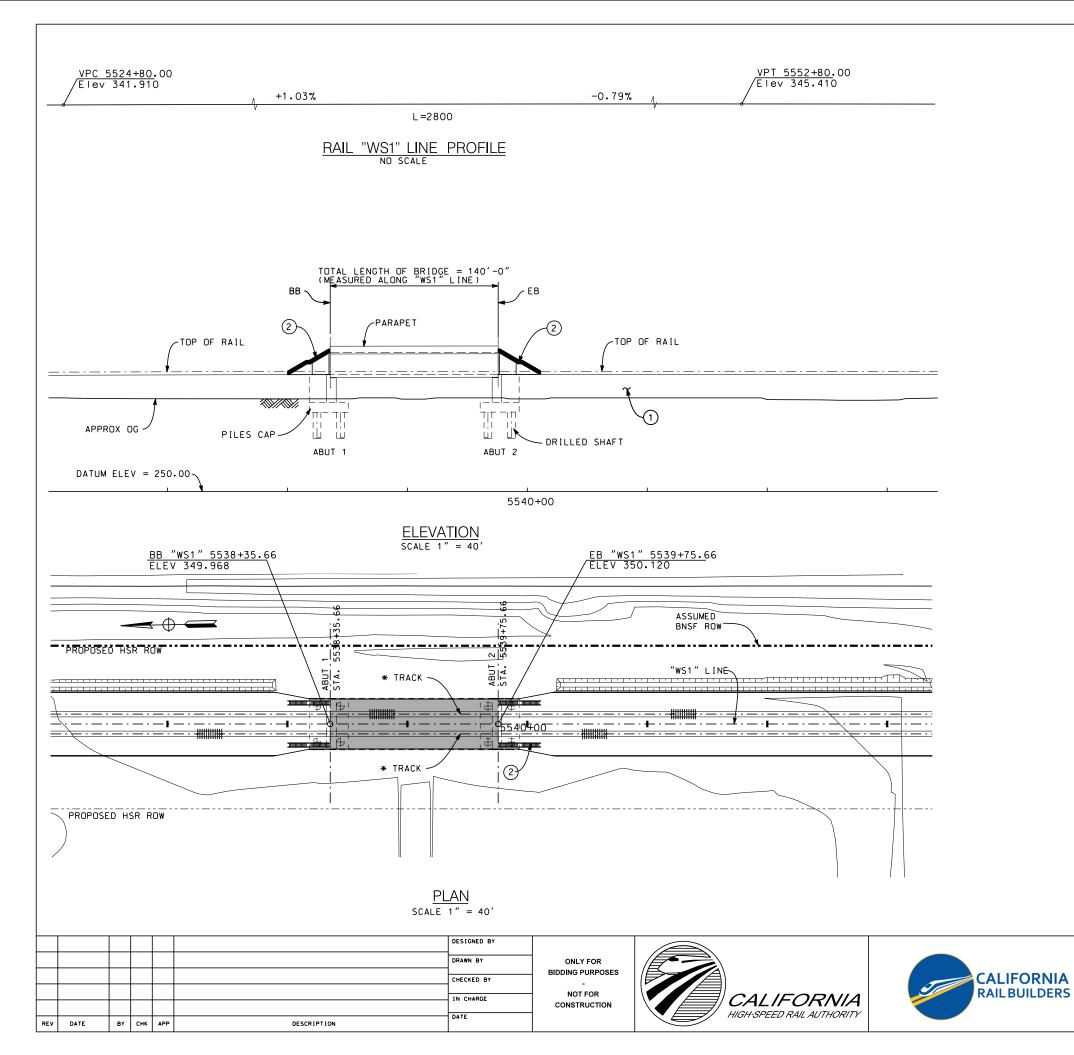

LEGEND:

- 1 RETAINING WALL
- 2 STAIRS




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SCALE 1" = 10'





# CALIFORNIA HIGH-SPEED TRAIN PROJECT FRESNO TO BAKERSFIELD


THROUGH WASCO SUBSECTION
ALIGNMENT WS1
SUNNYGEM BRIDGE
PLAN AND ELEVATION


CONTRACT NO.
DRAWING NO. 2.02.01_05
AS SHOWN
SHEET NO. 5 OF 16

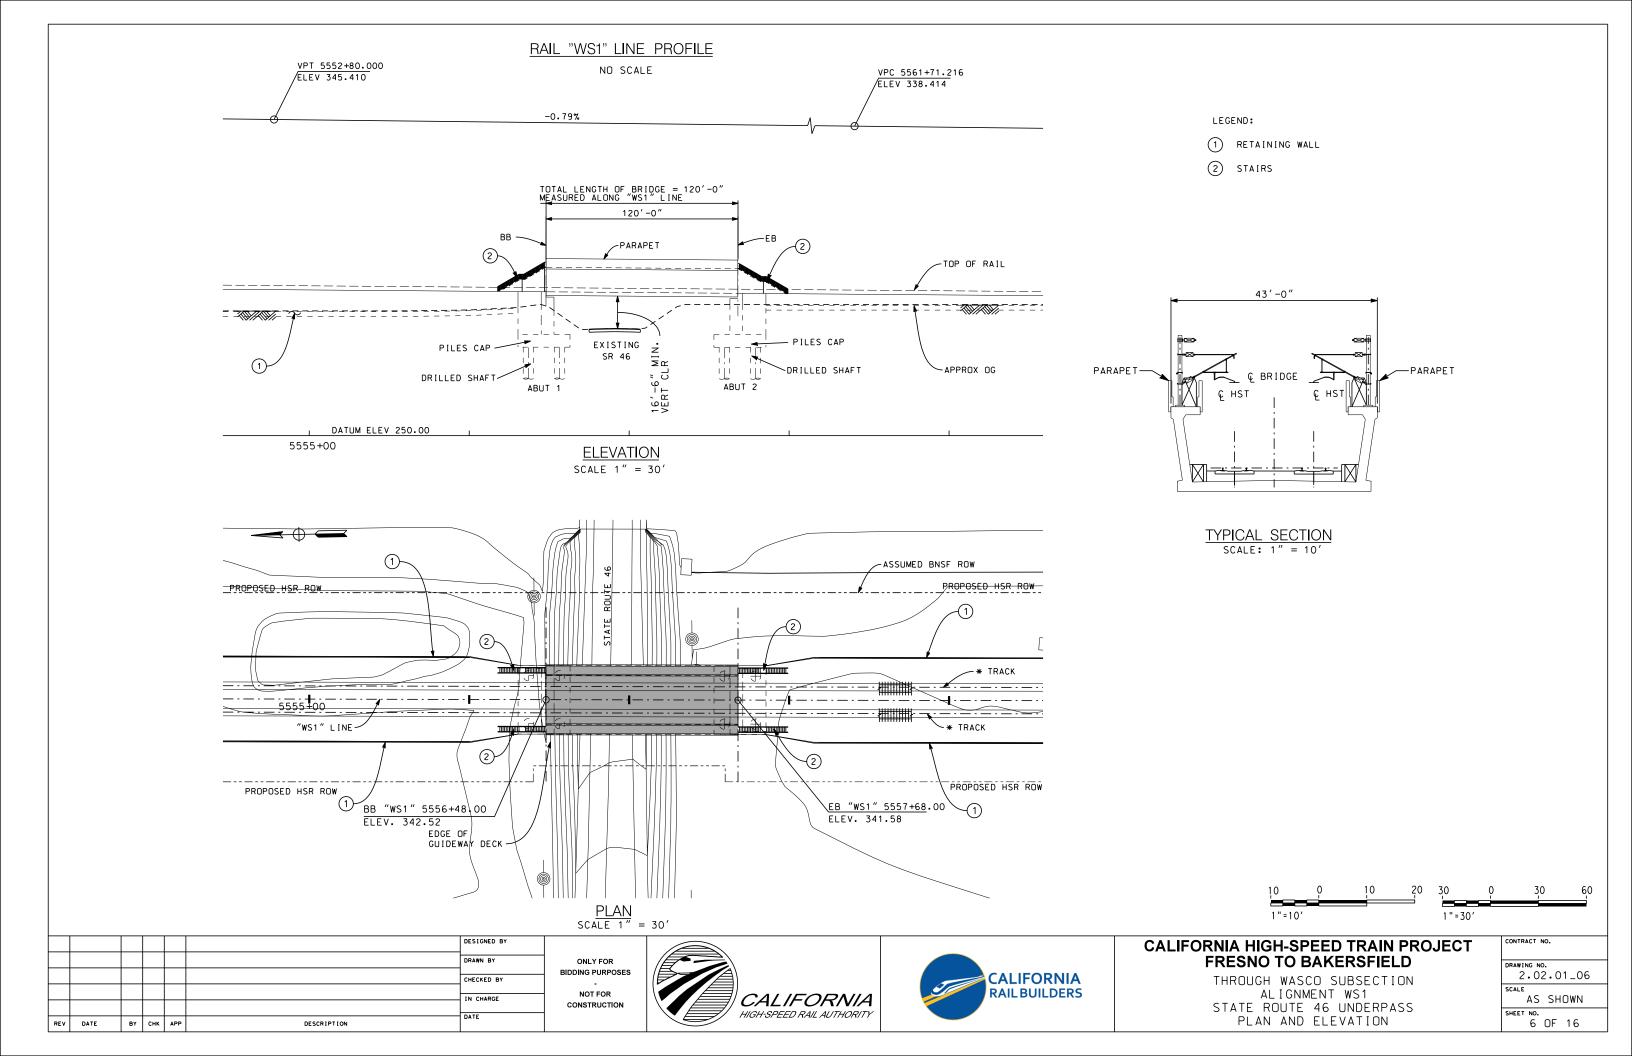


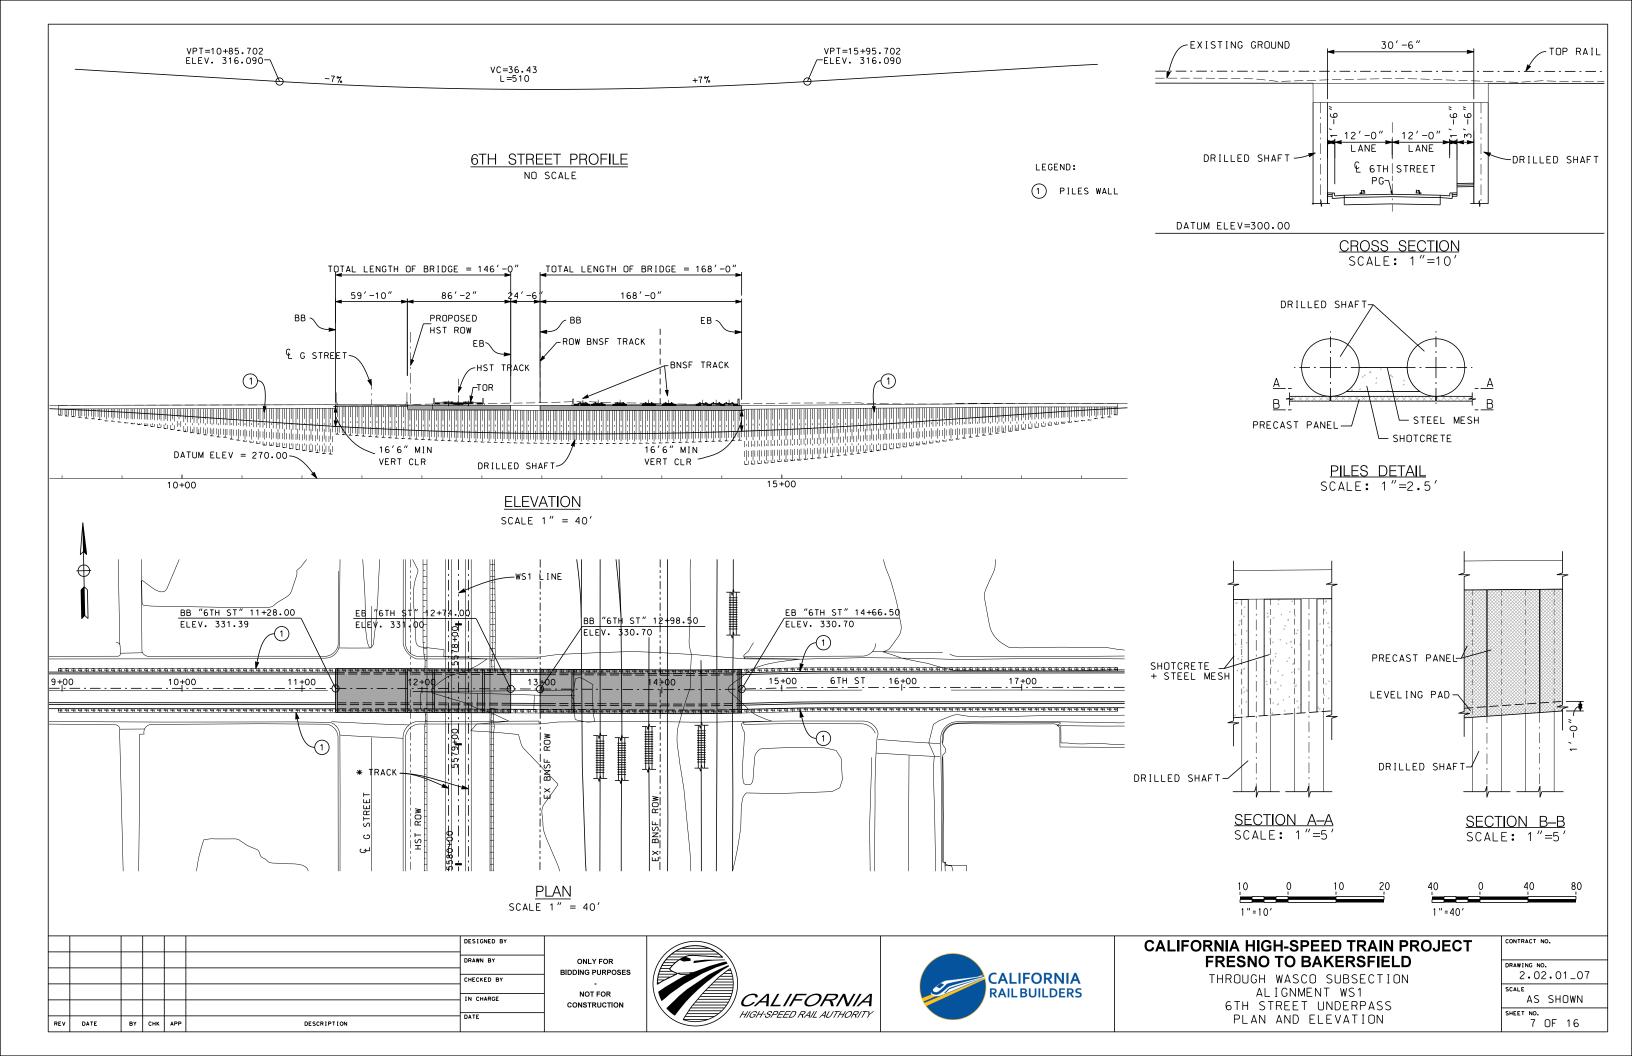


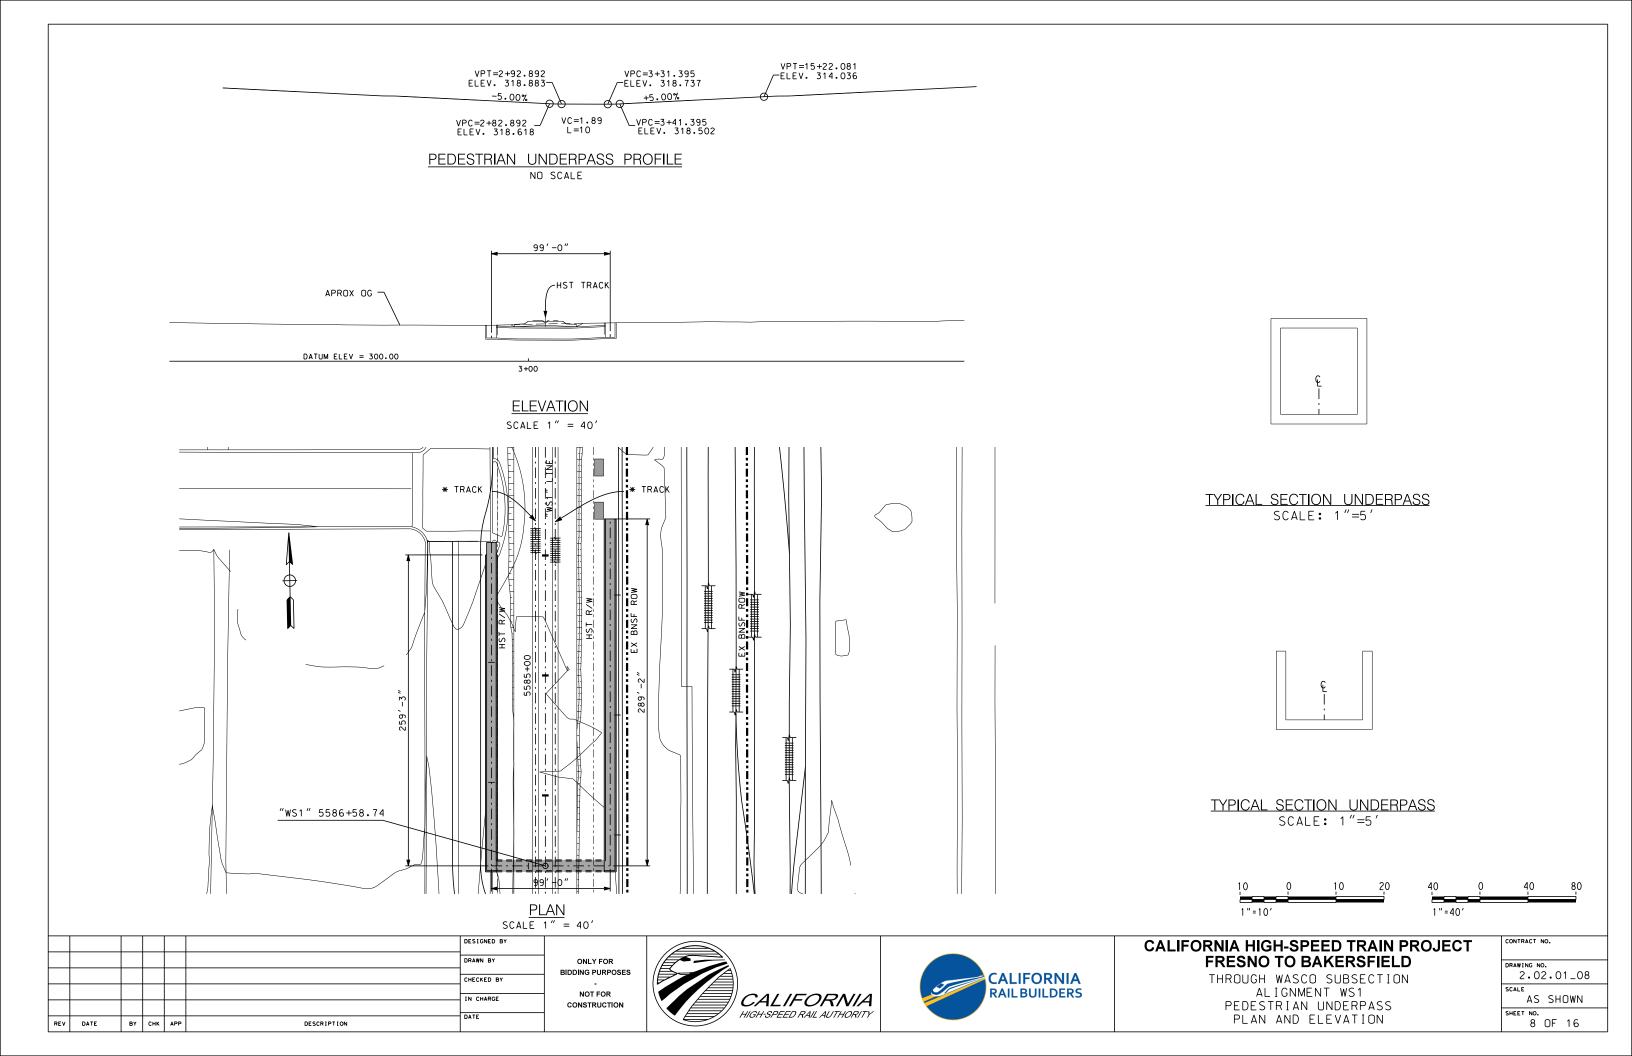


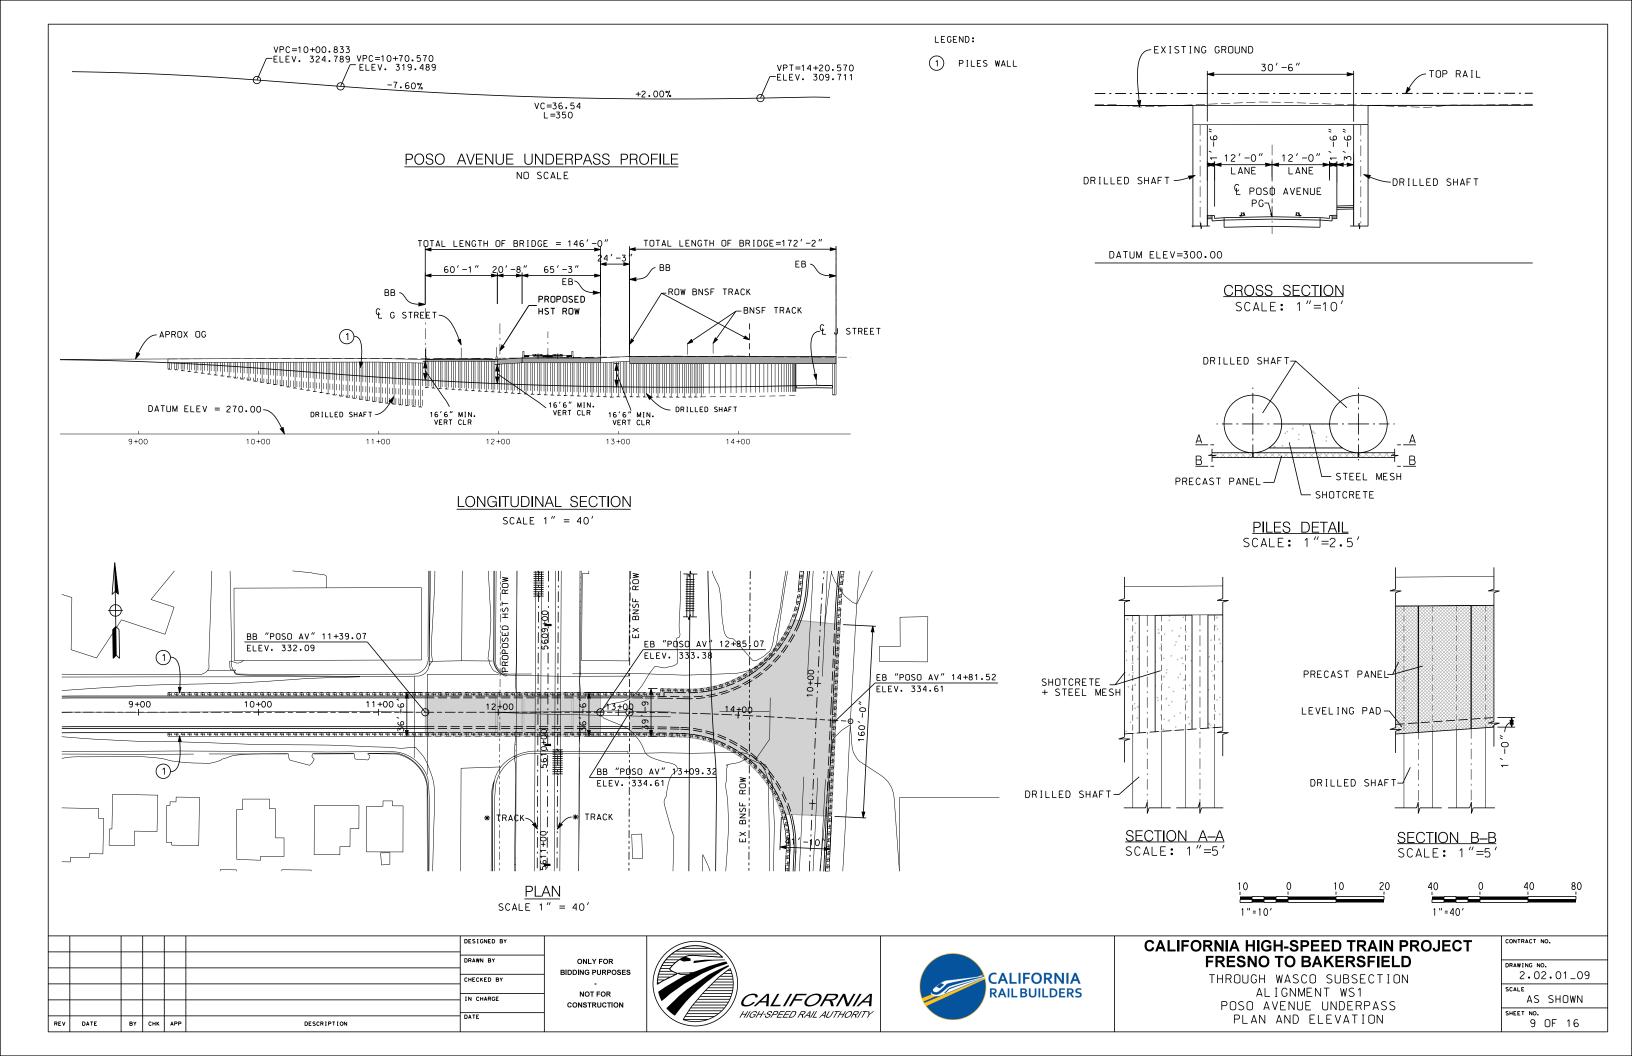


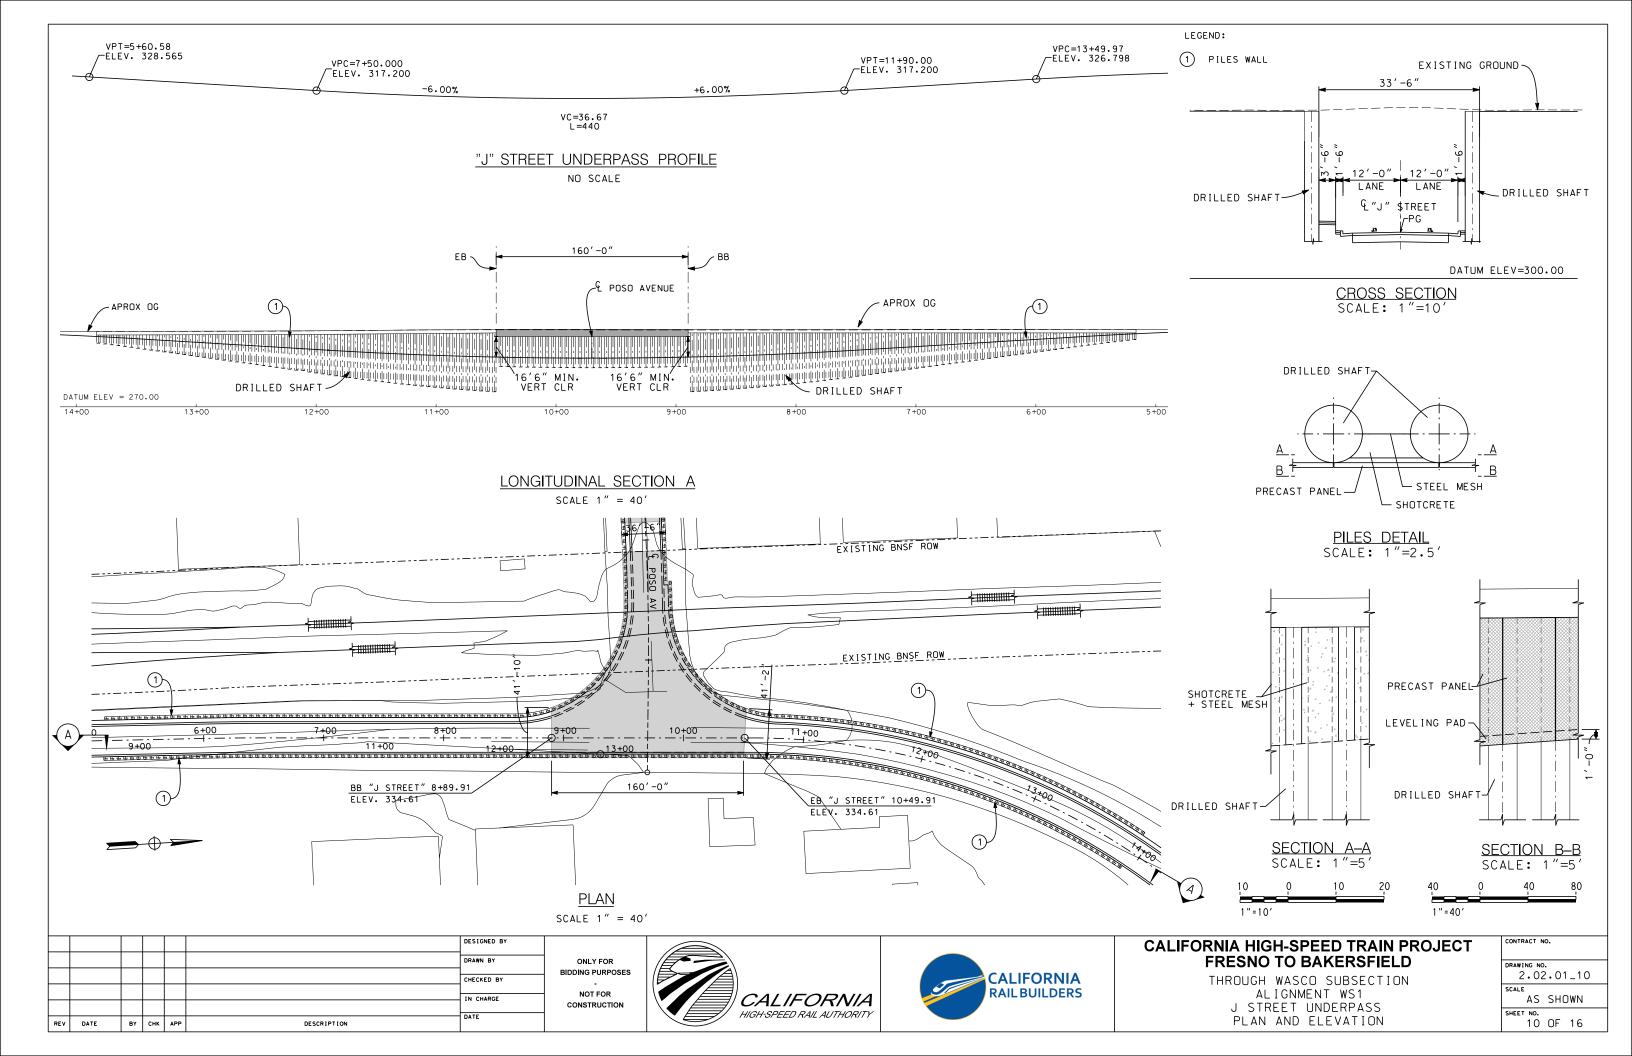


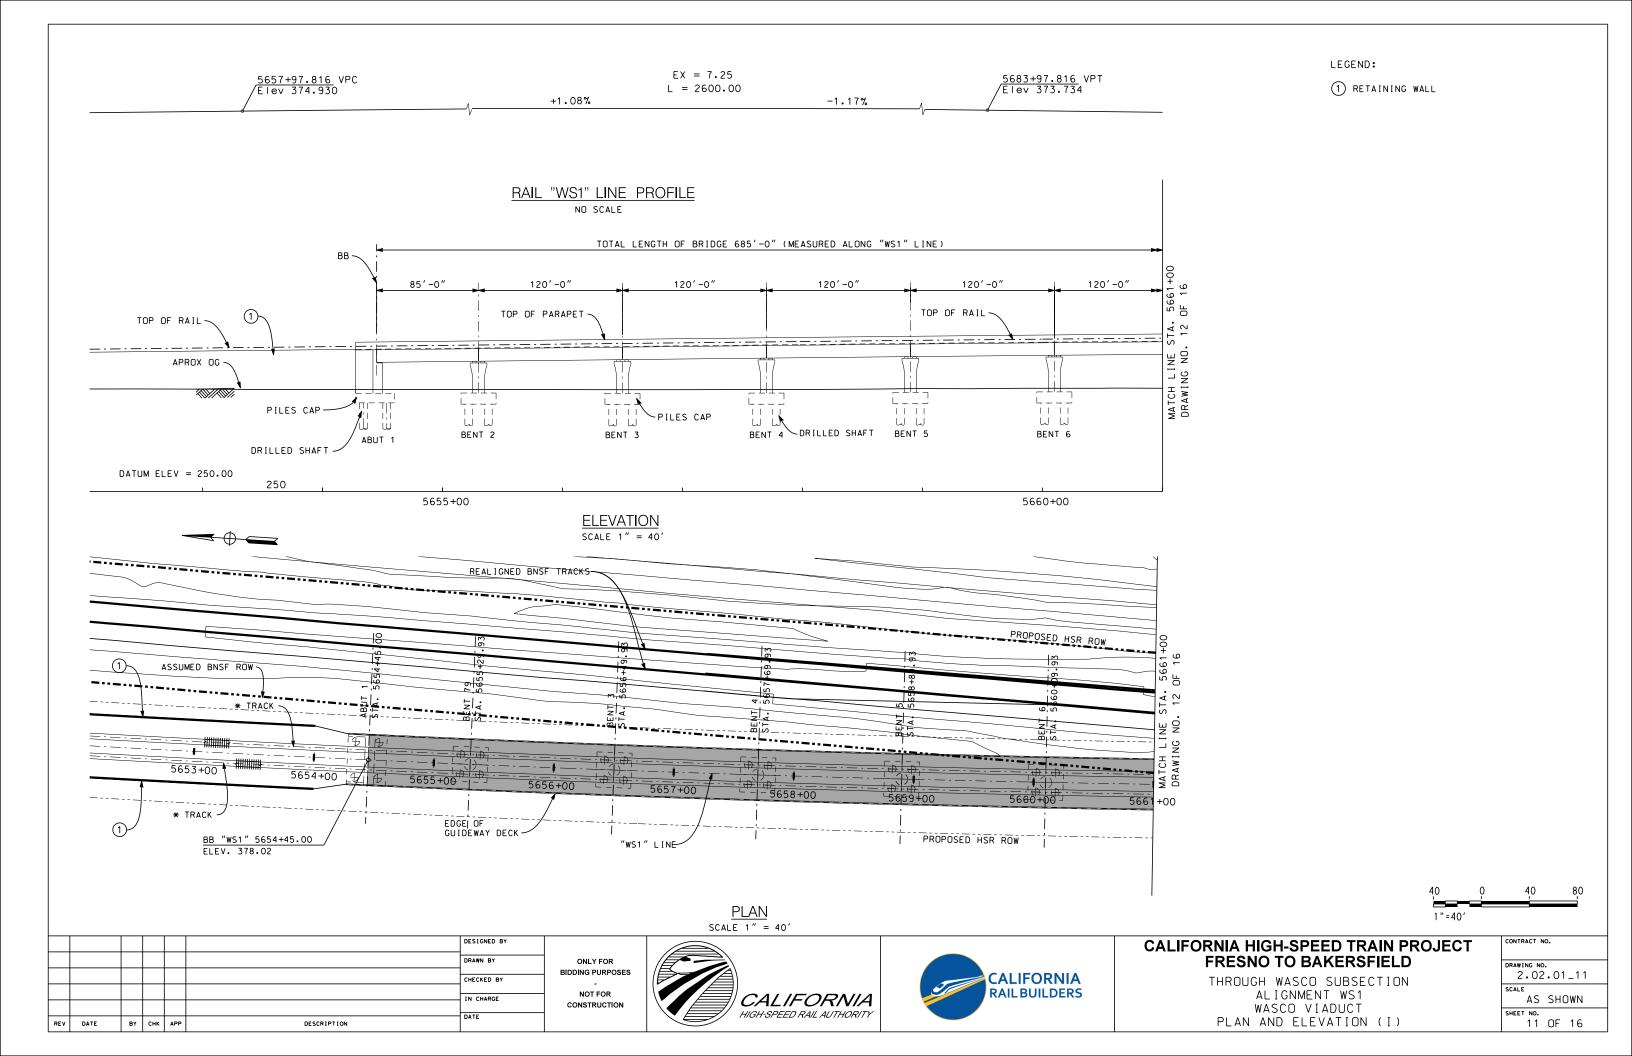


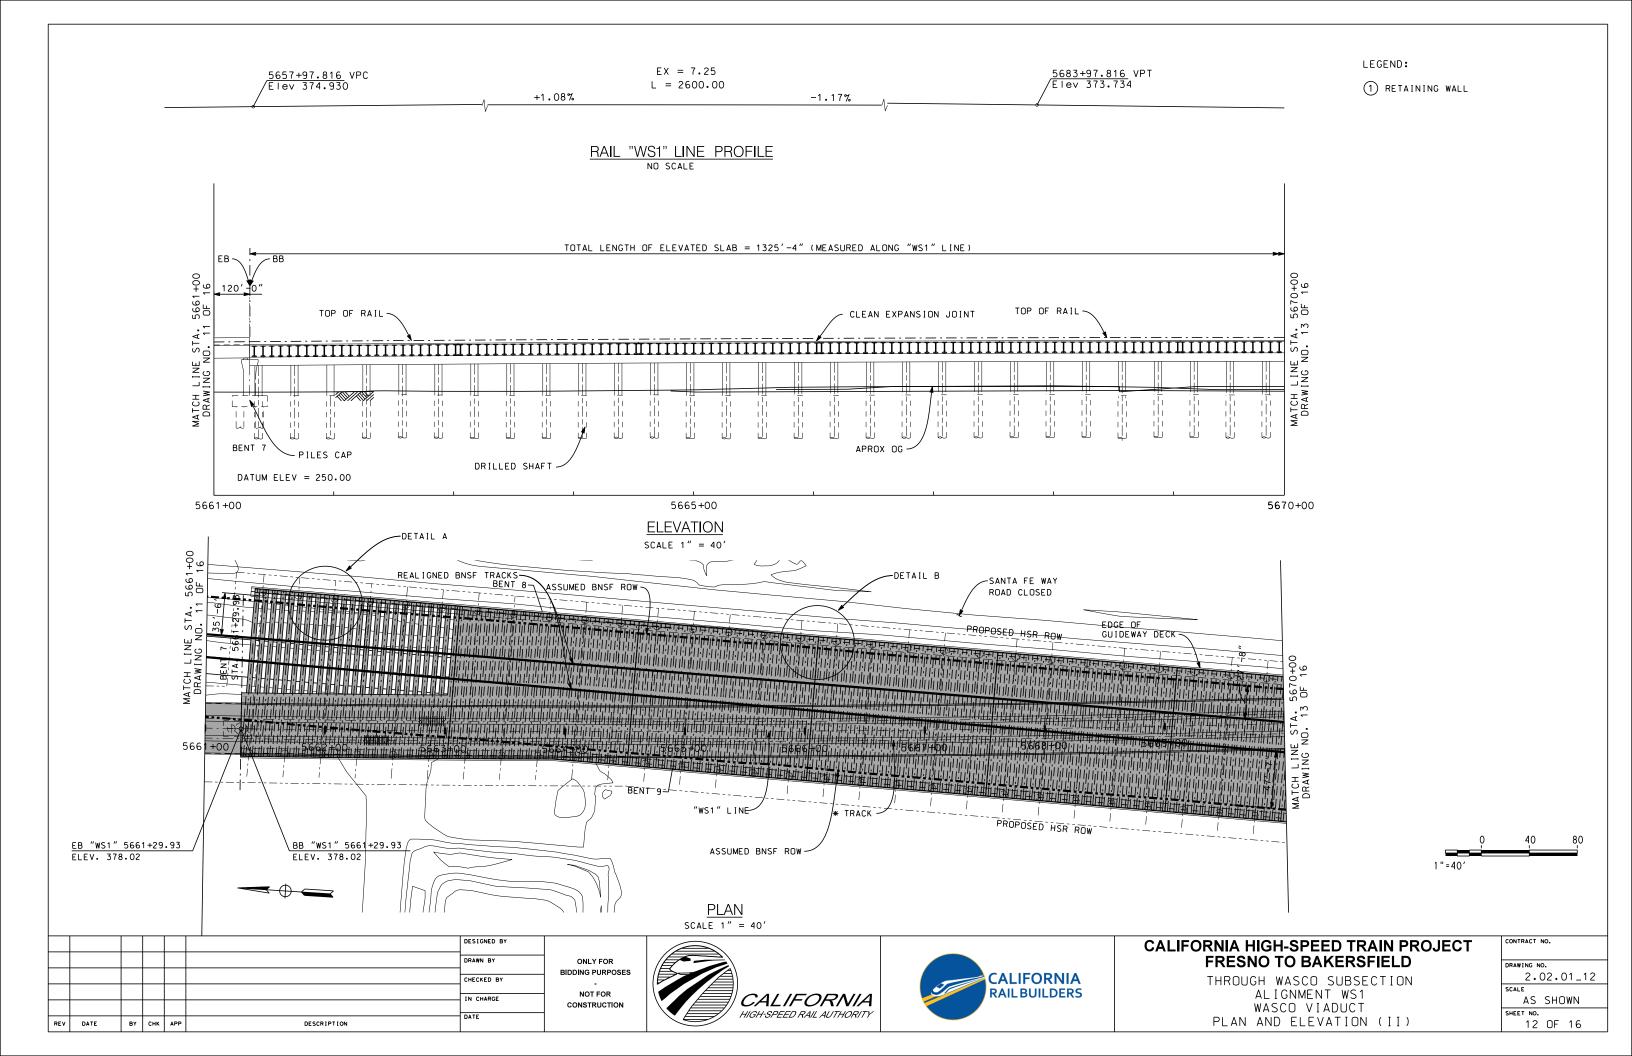

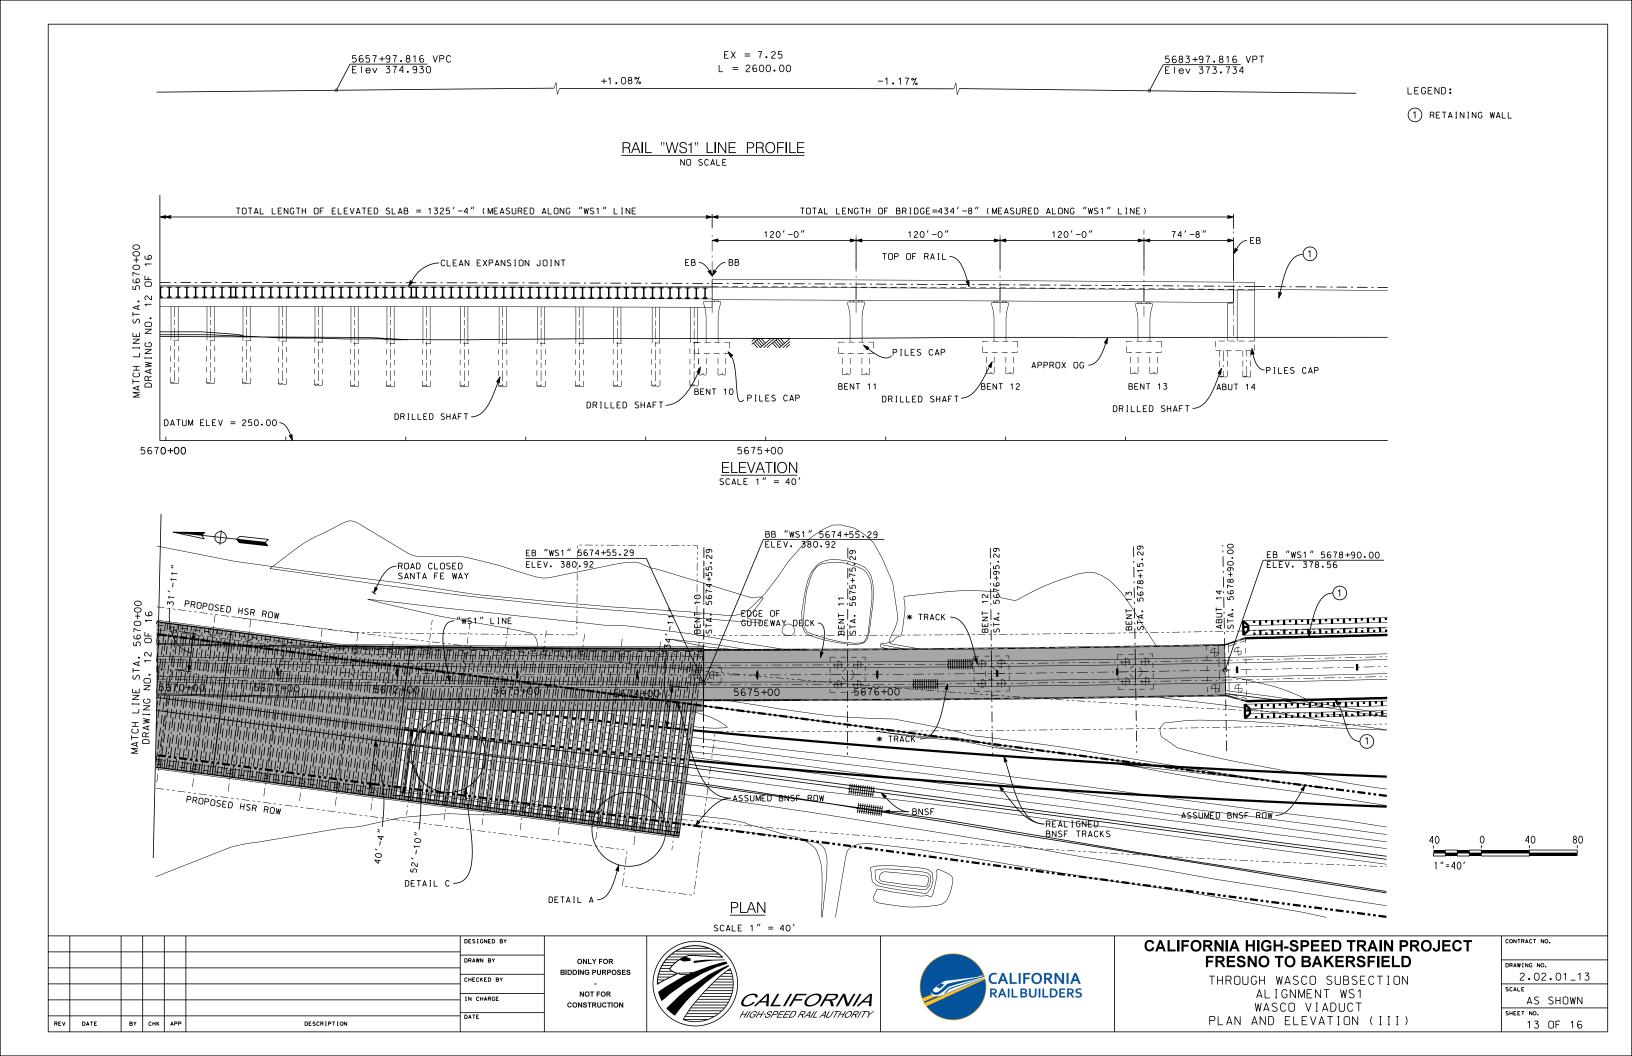

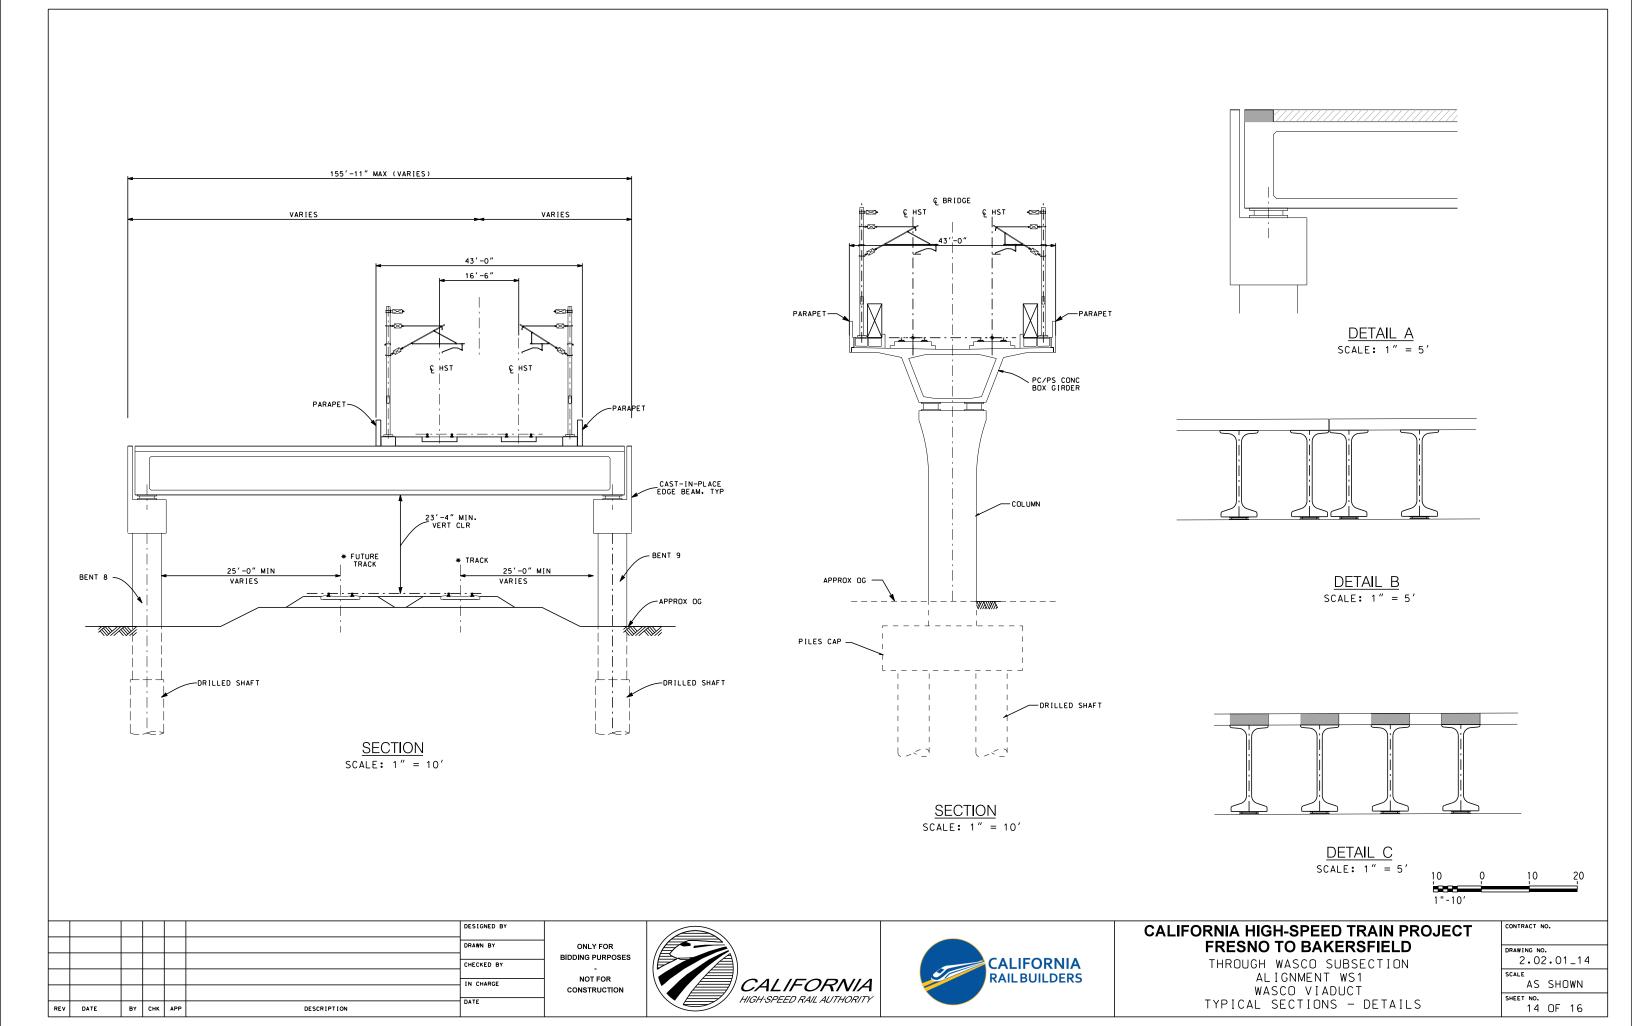


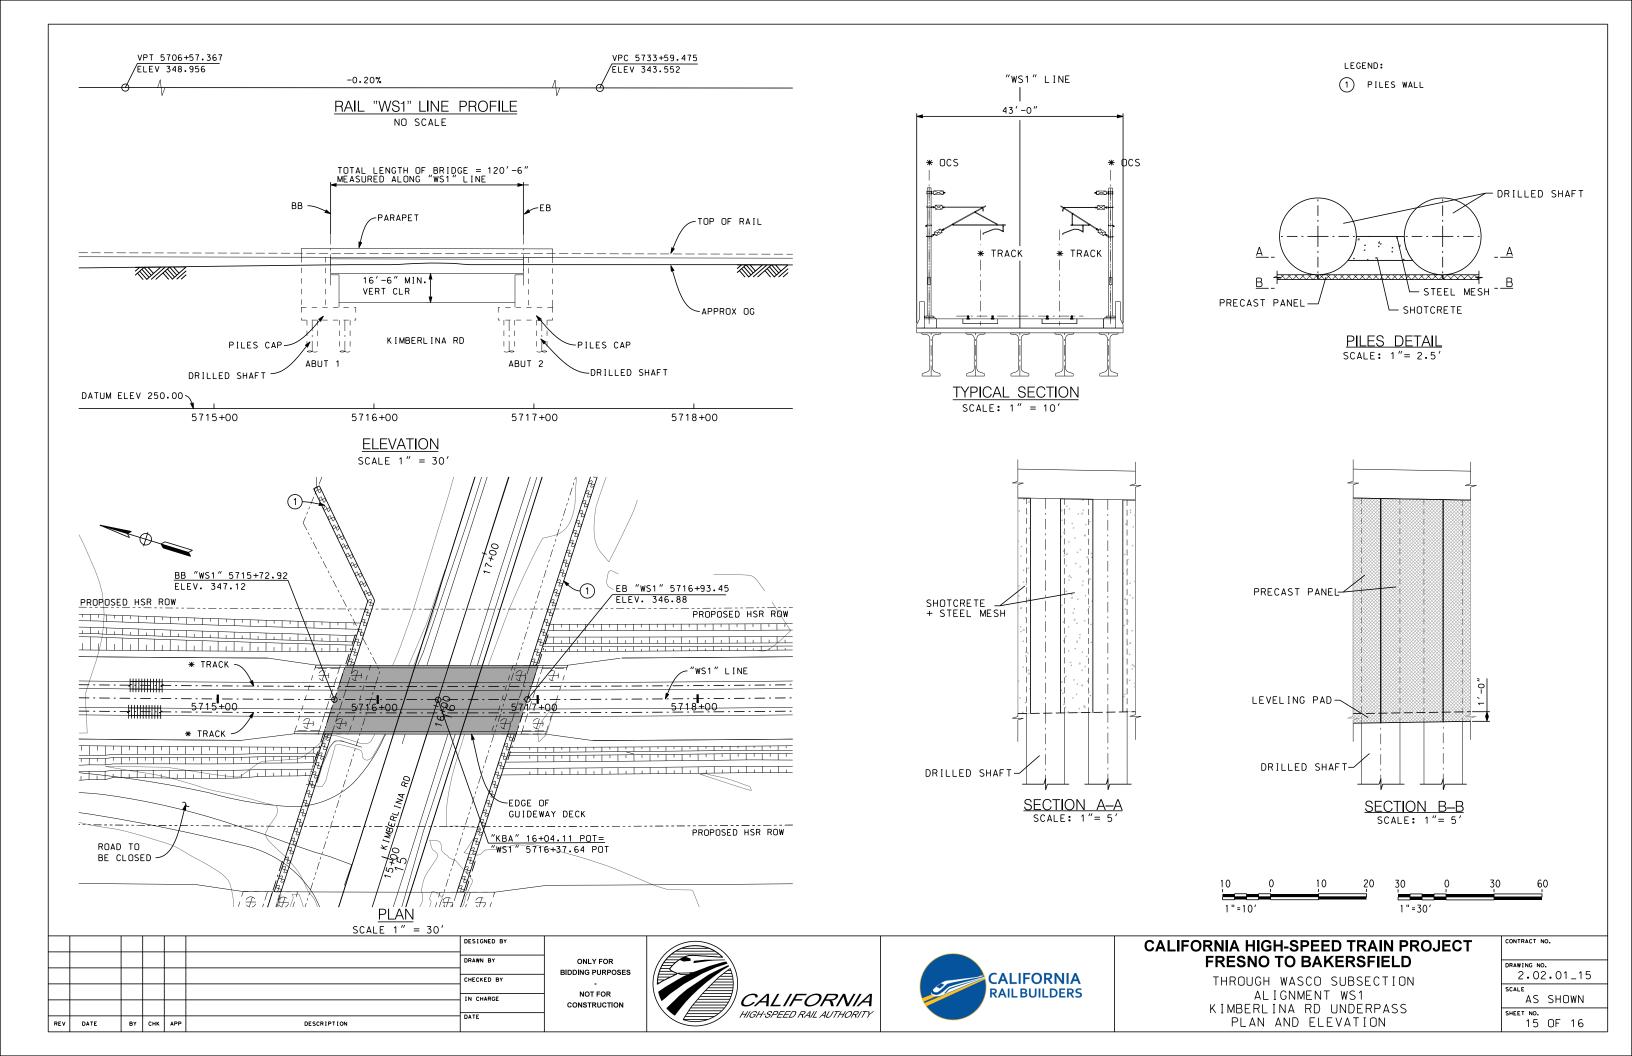


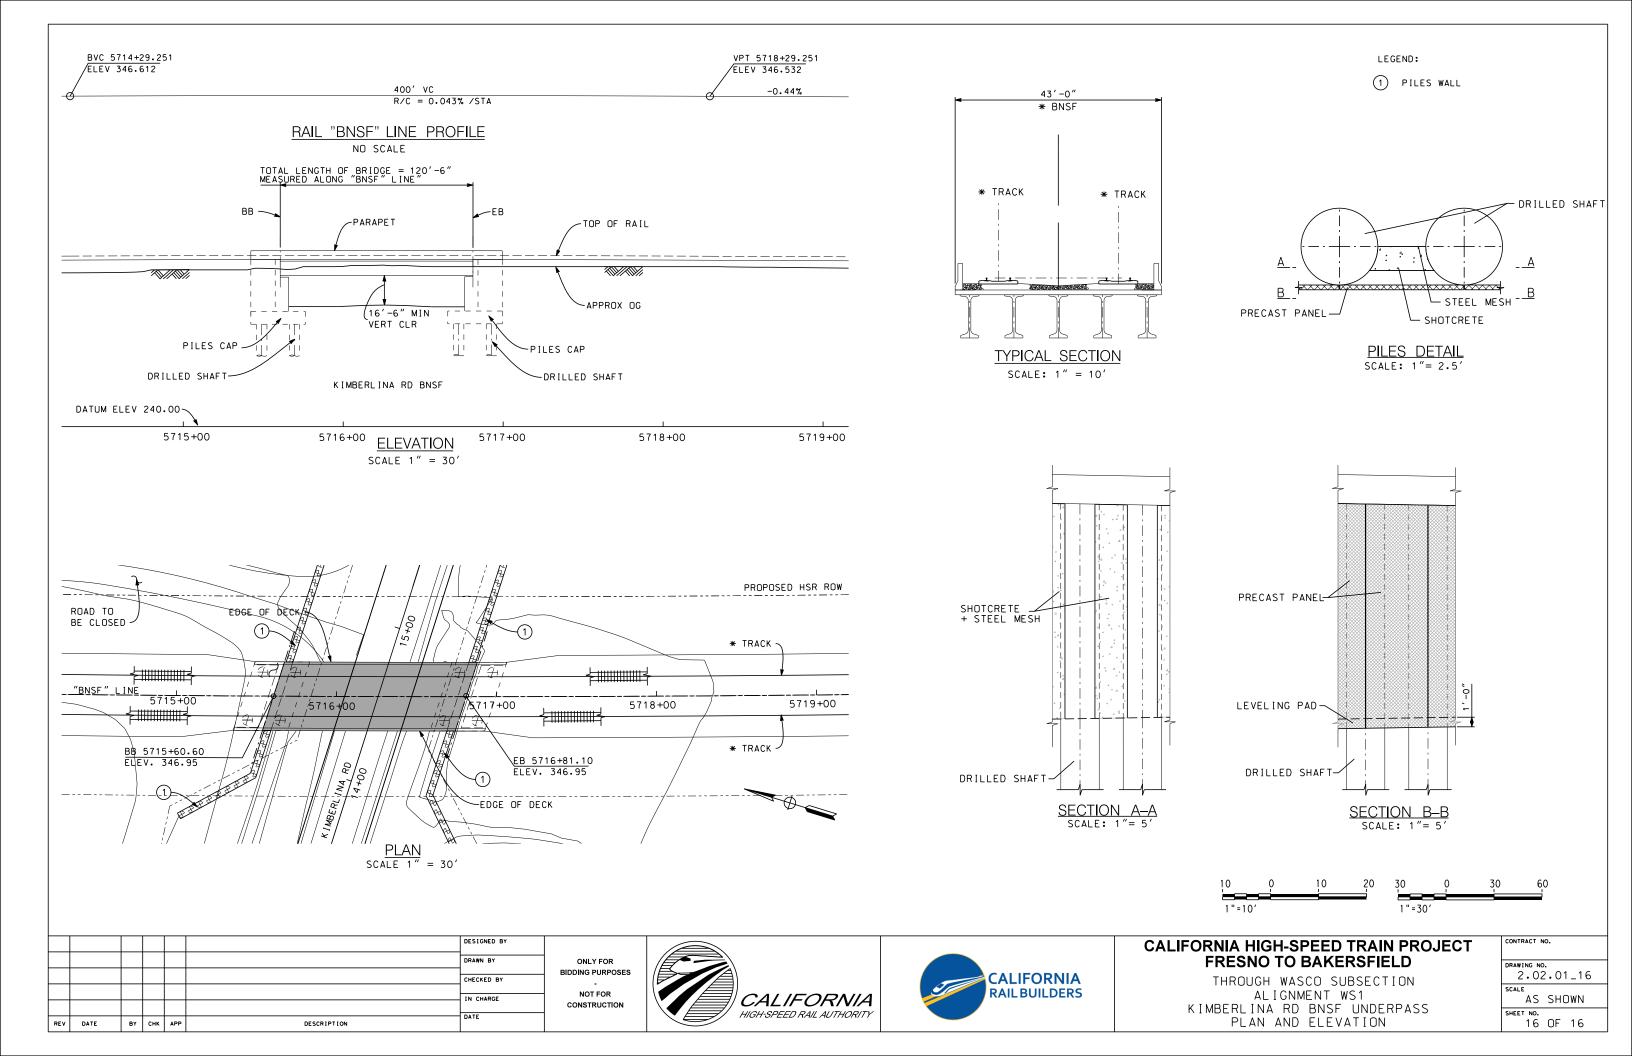



# STRUCTURES ROADWAYS



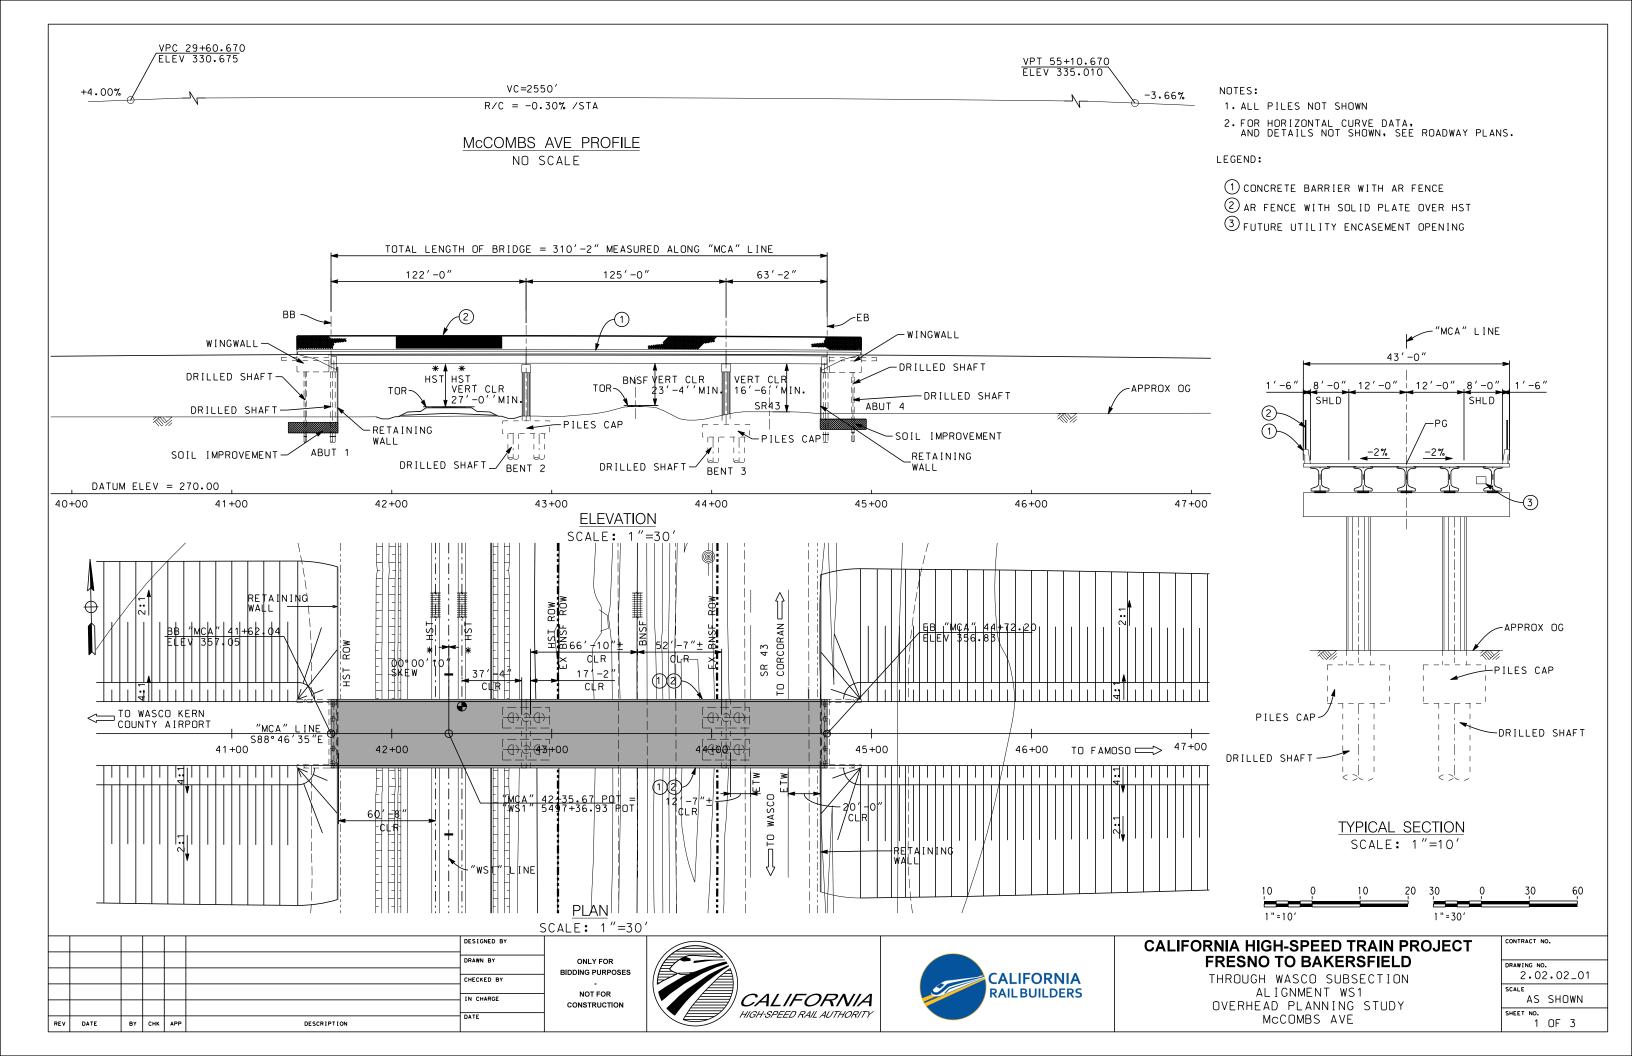


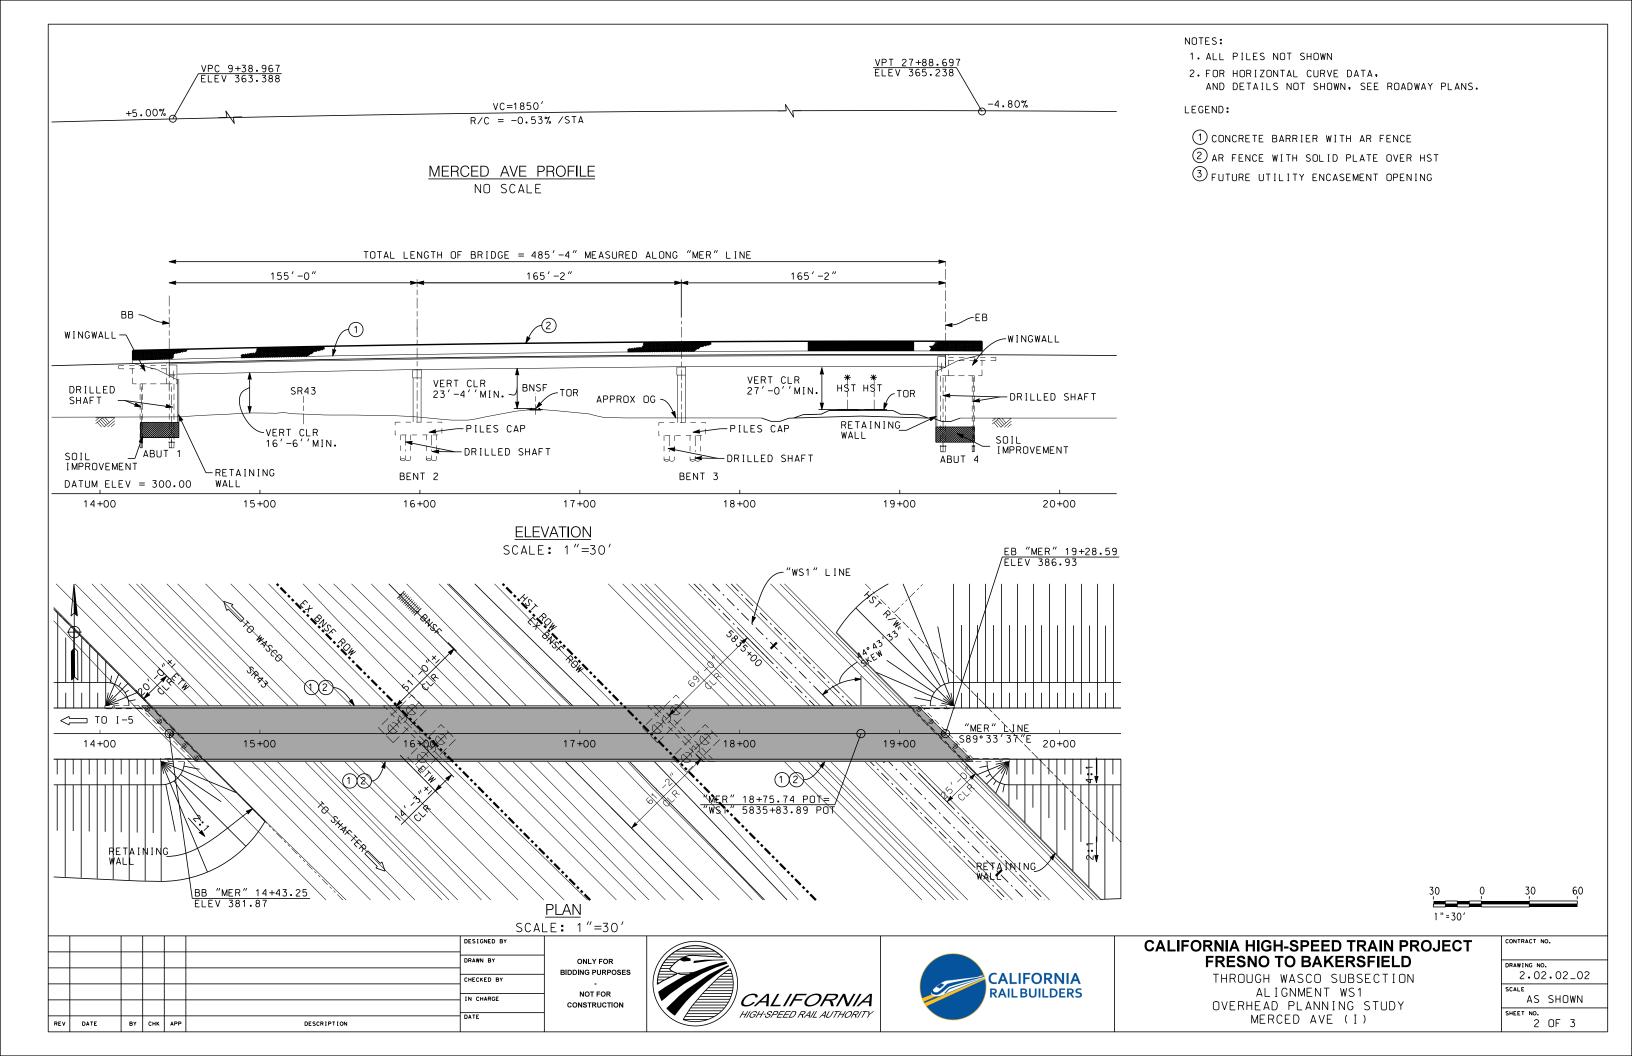

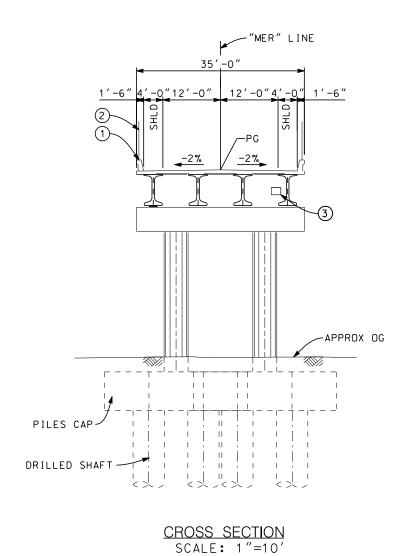

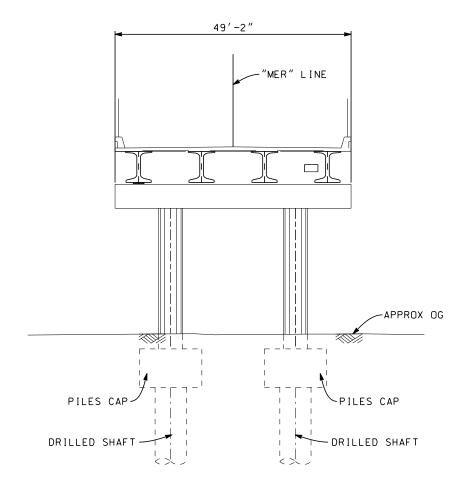

BENT - ELEVATION SCALE: 1"=10'

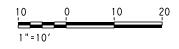

REV	DATE	BY	СНК	APP	DESCRIPTION	DATE	
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						DRAWN BY	
						DESIGNED BY	

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# CALIFORNIA HIGH-SPEED TRAIN PROJECT FRESNO TO BAKERSFIELD

THROUGH WASCO SUBSECTION
ALIGNMENT WS1
OVERHEAD PLANNING STUDY
MERCED AVE (II)

CONTRACT NO.
DRAWING NO. 2.02.02_03
SCALE AS SHOWN
SHEET NO.
l 5 UE-5

CALIFORNIA HIGH-SPEED RAIL PROJECT

Design-Build Contract for CONSTRUCTION PACKAGE 4

Proposals | RFP Number: HSR 14-32

## INDEX - DRAINAGE

DRAWING No.	REV No.	DRAWING DESCRIPTION	SHEET No
2.03.01_01		ALLENSWORTH BYPASS SUBSECTION - ALIGNMENT A1 - STA. 4435+50 TO 4463+00 - DRAINAGE	1 OF 40
2.03.01_02		ALLENSWORTH BYPASS SUBSECTION - ALIGNMENT A1 - STA. 4463+00 TO 4491+00 - DRAINAGE	2 OF 40
2.03.01_03		ALLENSWORTH BYPASS SUBSECTION - ALIGNMENT A1 - STA. 4491+00 TO 4519+00 - DRAINAGE	3 OF 40
2.03.01_04		ALLENSWORTH BYPASS SUBSECTION - ALIGNMENT A1 - STA. 4519+00 TO 4547+00 - DRAINAGE	4 OF 40
2.03.01_05		ALLENSWORTH BYPASS SUBSECTION - ALIGNMENT A1 - STA. 4547+00 TO 4575+00 - DRAINAGE	5 OF 40
2.03.01_06		ALLENSWORTH BYPASS SUBSECTION - ALIGNMENT A1 - STA. 4575+00 TO 4603+00 - DRAINAGE	6 OF 40
2.03.01_07		ALLENSWORTH BYPASS SUBSECTION - ALIGNMENT A1 - STA. 4603+00 TO 4631+00 - DRAINAGE	7 OF 40
2.03.01_08		ALLENSWORTH BYPASS SUBSECTION - ALIGNMENT A1 - STA. 4631+00 TO 4659+00 - DRAINAGE	8 OF 40
2.03.01_09		ALLENSWORTH BYPASS SUBSECTION - ALIGNMENT A1 - STA. 4659+00 TO 4687+00 - DRAINAGE	9 OF 40
2.03.01_10		ALLENSWORTH BYPASS SUBSECTION - ALIGNMENT A1 - STA. 4687+00 TO 4715+00 - DRAINAGE	10 OF 40
2.03.01_11		ALLENSWORTH BYPASS SUBSECTION - ALIGNMENT A1 - STA. 4715+00 TO 4743+00 - DRAINAGE	11 OF 40
2.03.01_12		ALLENSWORTH BYPASS SUBSECTION - ALIGNMENT A1 - STA. 4743+00 TO 4771+00 - DRAINAGE	12 OF 40
2.03.01_13		ALLENSWORTH BYPASS SUBSECTION - ALIGNMENT A1 - STA. 4771+00 TO 4799+00 - DRAINAGE	13 OF 40
2.03.01_14		ALLENSWORTH BYPASS SUBSECTION - ALIGNMENT A1 - STA. 4799+00 TO 4827+00 - DRAINAGE	14 OF 40
2.03.01_15		ALLENSWORTH BYPASS SUBSECTION - ALIGNMENT A1 - STA. 4827+00 TO 4855+00 - DRAINAGE	15 OF 40
2.03.01_16		ALLENSWORTH BYPASS SUBSECTION - ALIGNMENT A1 - STA. 4855+00 TO 4883+00 - DRAINAGE	16 OF 40
2.03.01_17		ALLENSWORTH BYPASS SUBSECTION - ALIGNMENT A1 - STA. 4883+00 TO 4911+00 - DRAINAGE	17 OF 40
2.03.01_18	8	ALLENSWORTH BYPASS SUBSECTION - ALIGNMENT A1 - STA. 4911+00 TO 4925+33.36	18 OF 40
2.03.01_18		POSO CREEK SUBSECTION - ALIGNMENT L1 - STA. 5154+50 TO 5168+00 - DRAINAGE	10 01 40
2.03.01_19		POSO CREEK SUBSECTION - ALIGNMENT L1 - STA. 5168+00 TO 5196+00 - DRAINAGE	19 OF 40
2.03.01_20		POSO CREEK SUBSECTION - ALIGNMENT L1 - STA. 5196+00 TO 5224+00 - DRAINAGE	20 OF 40
2.03.01_21		POSO CREEK SUBSECTION - ALIGNMENT L1 - STA. 5224+00 TO 5252+00 - DRAINAGE	21 OF 40
2.03.01_22		POSO CREEK SUBSECTION - ALIGNMENT L1 - STA. 5252+00 TO 5280+00 - DRAINAGE	22 OF 40
2.03.01_23		POSO CREEK SUBSECTION - ALIGNMENT L1 - STA. 5280+00 TO 5308+00 - DRAINAGE	23 OF 40
2.03.01_24		POSO CREEK SUBSECTION - ALIGNMENT L1 - STA. 5308+00 TO 5322+33.13	24 OF 40
2:03:01_24		THROUGH WASCO SUBSECTION - ALIGNMENT WS1 - STA. 5422+50 TO 5436+00 - DRAINAGE	
2.03.01_25		THROUGH WASCO SUBSECTION - ALIGNMENT WS1 - STA. 5436+00 TO 5464+00 - DRAINAGE	25 OF 40
2.03.01_26		THROUGH WASCO SUBSECTION - ALIGNMENT WS1 - STA. 5464+00 TO 5492+00 - DRAINAGE	26 OF 40
2.03.01_27		THROUGH WASCO SUBSECTION - ALIGNMENT WS1 - STA. 5492+00 TO 5520+00 - DRAINAGE	27 OF 40
2.03.01_28		THROUGH WASCO SUBSECTION - ALIGNMENT WS1 - STA. 5520+00 TO 5548+00 - DRAINAGE	28 OF 40
2.03.01_29		THROUGH WASCO SUBSECTION - ALIGNMENT WS1 - STA, 5548+00 TO 5576+00 - DRAINAGE	29 OF 40
2.03.01_30		THROUGH WASCO SUBSECTION - ALIGNMENT WS1 - STA. 5576+00 TO 5604+00 - DRAINAGE	30 OF 40

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## CALIFORNIA HIGH-SPEED TRAIN PROJECT FRESNO TO BAKERSFIELD

INDEX OF DRAWINGS DRAINAGE

CONTRACT NO.
DRAWING NO.
2.03
SCALE
NO SCALE
SHEET NO.
1 OF 2

## INDEX - DRAINAGE - HIGH-SPEED RAIL TRACK (CONT.)

DRAWING No.	REV No.	DRAWING DESCRIPTION	SHEET NO
2.03.01_31		THROUGH WASCO SUBSECTION - ALIGNMENT WS1 - STA. 5604+00 TO 5632+00 - DRAINAGE	31 OF 40
2.03.01_32		THROUGH WASCO SUBSECTION - ALIGNMENT WS1 - STA. 5632+00 TO 5660+00 - DRAINAGE	32 OF 40
2.03.01_33		THROUGH WASCO SUBSECTION - ALIGNMENT WS1 - STA. 5660+00 TO 5688+00 - DRAINAGE	33 OF 40
2.03.01_34		THROUGH WASCO SUBSECTION - ALIGNMENT WS1 - STA. 5688+00 TO 5716+00 - DRAINAGE	34 OF 40
2.03.01_35		THROUGH WASCO SUBSECTION - ALIGNMENT WS1 - STA. 5716+00 TO 5744+00 - DRAINAGE	35 OF 40
2.03.01_36		THROUGH WASCO SUBSECTION - ALIGNMENT WS1 - STA. 5744+00 TO 5772+00 - DRAINAGE	36 OF 40
2.03.01_37		THROUGH WASCO SUBSECTION - ALIGNMENT WS1 - STA. 5772+00 TO 5800+00 - DRAINAGE	37 OF 40
2.03.01_38		THROUGH WASCO SUBSECTION - ALIGNMENT WS1 - STA. 5800+00 TO 5828+00 - DRAINAGE	38 OF 40
2.03.01_39		THROUGH WASCO SUBSECTION - ALIGNMENT WS1 - STA. 5828+00 TO 5856+00 - DRAINAGE	39 OF 40
2.03.01_40		THROUGH WASCO SUBSECTION - ALIGNMENT WS1 - STA. 5856+00 TO 5879+93.88 - DRAINAGE	40 OF 40

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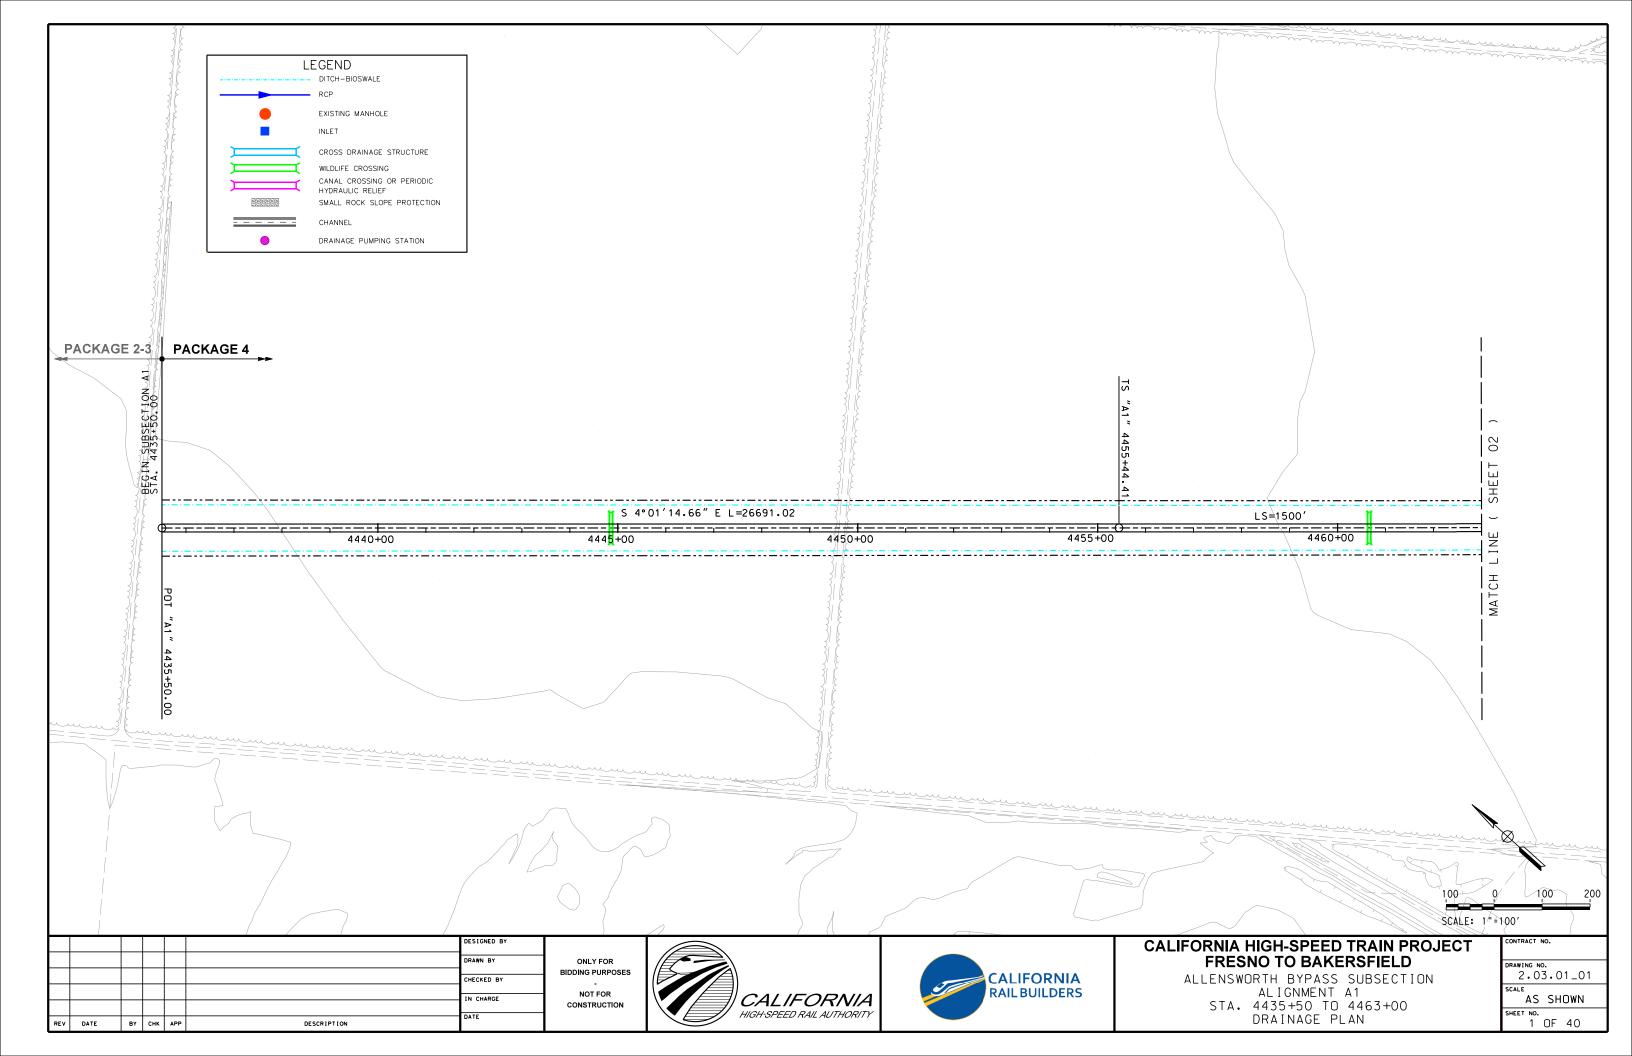



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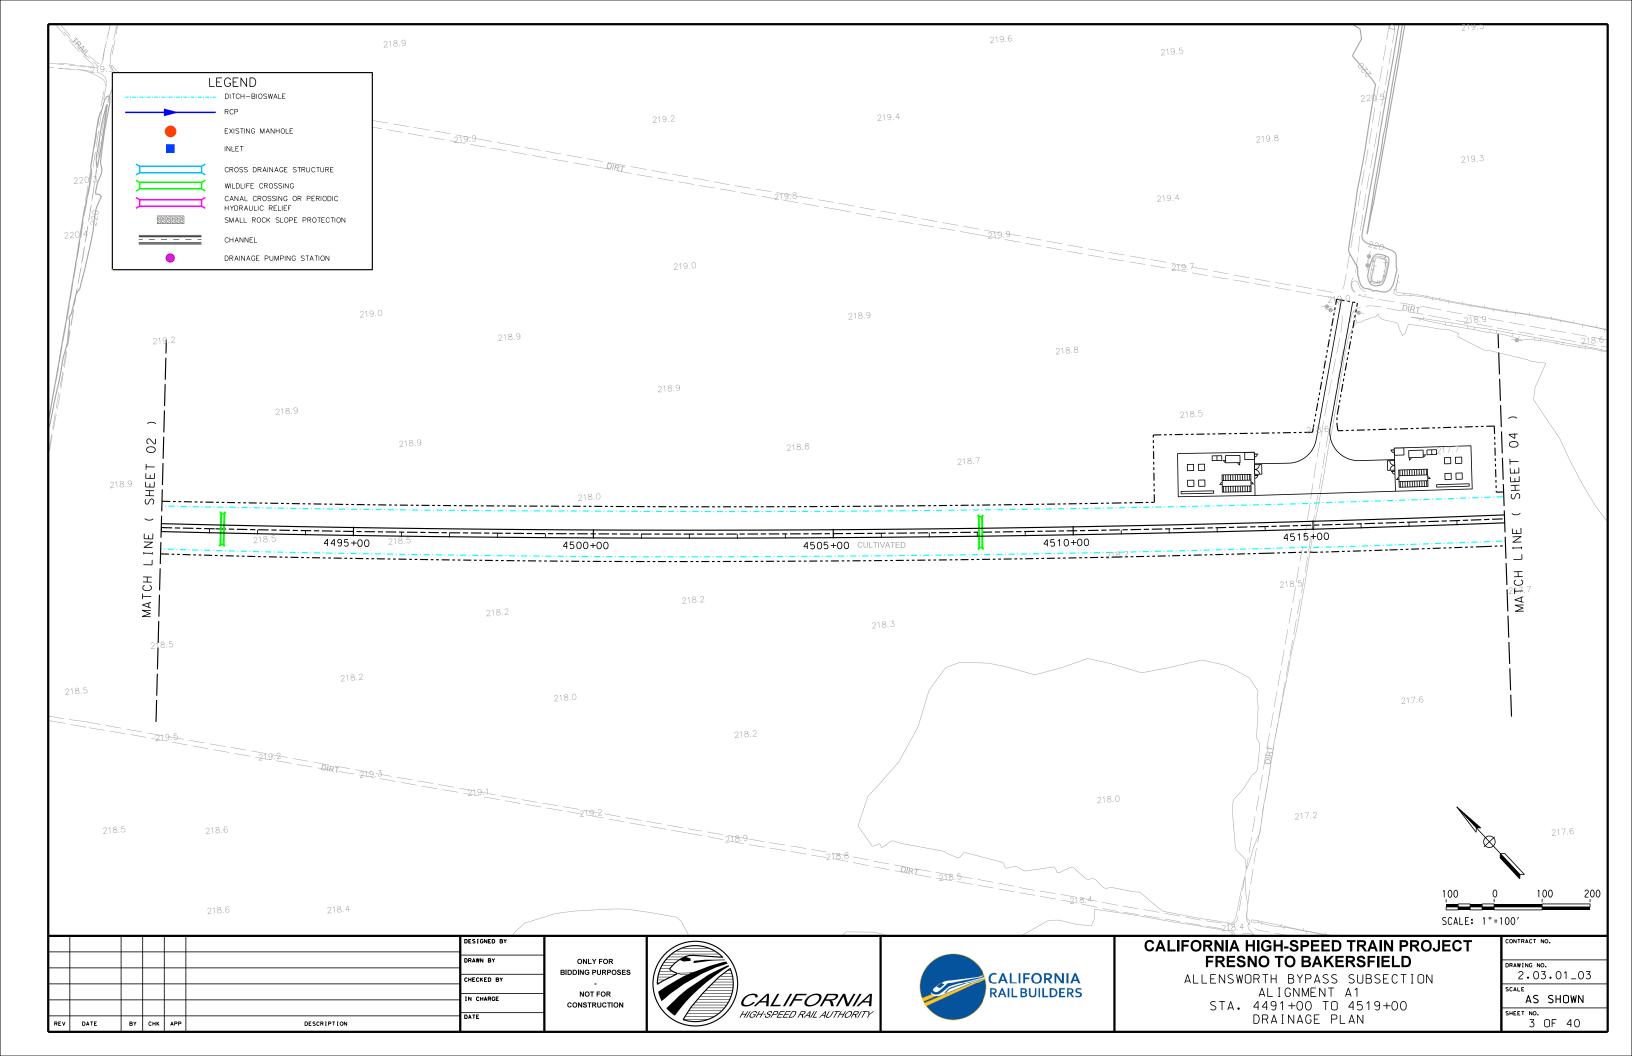
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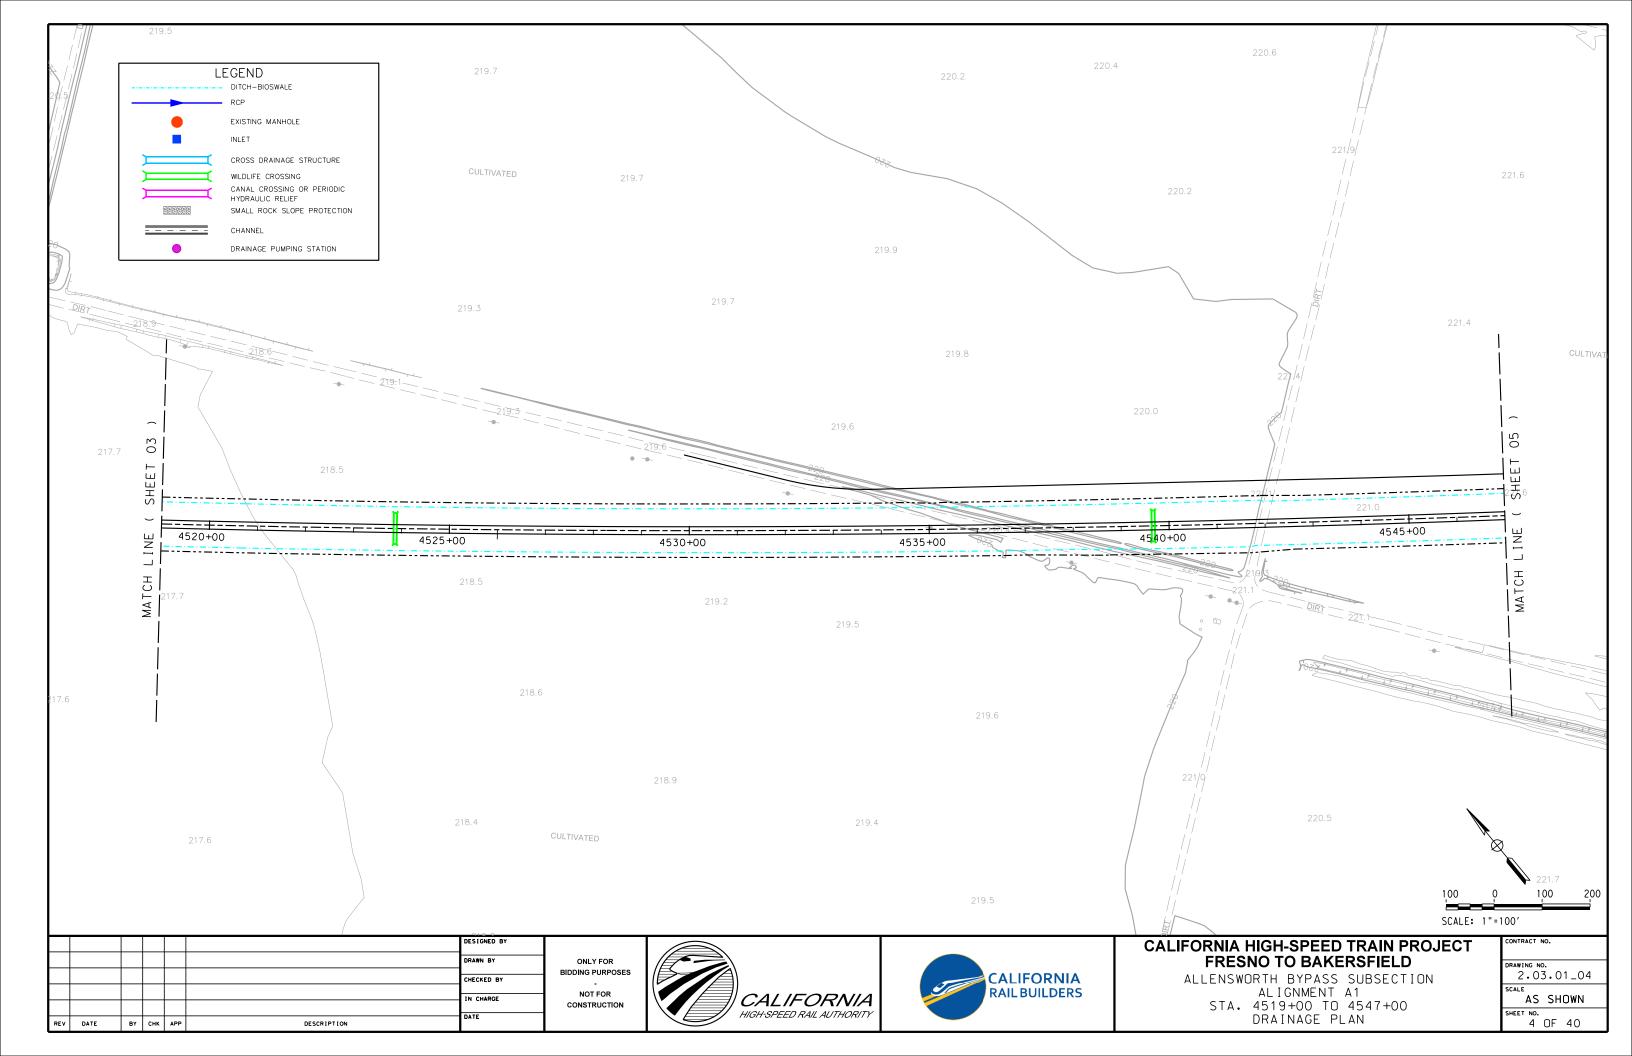
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DRAWING NO. 2.03
SCALE NO SCALE


SHEET NO.
2 OF 2










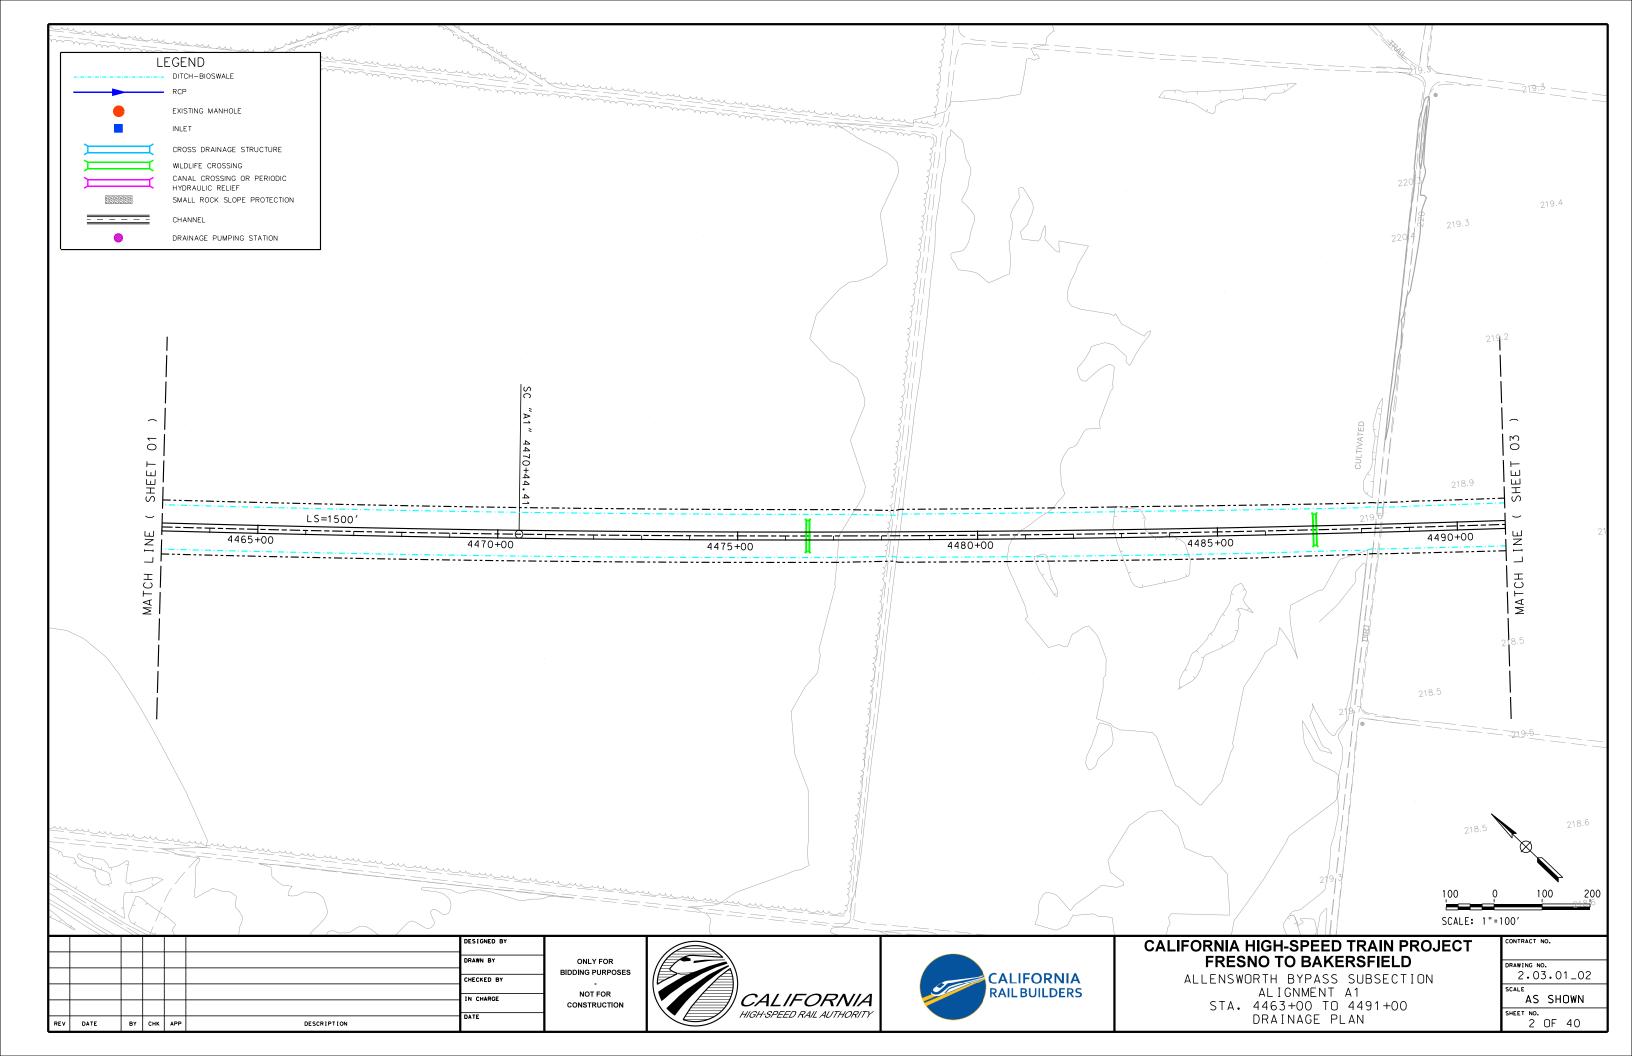


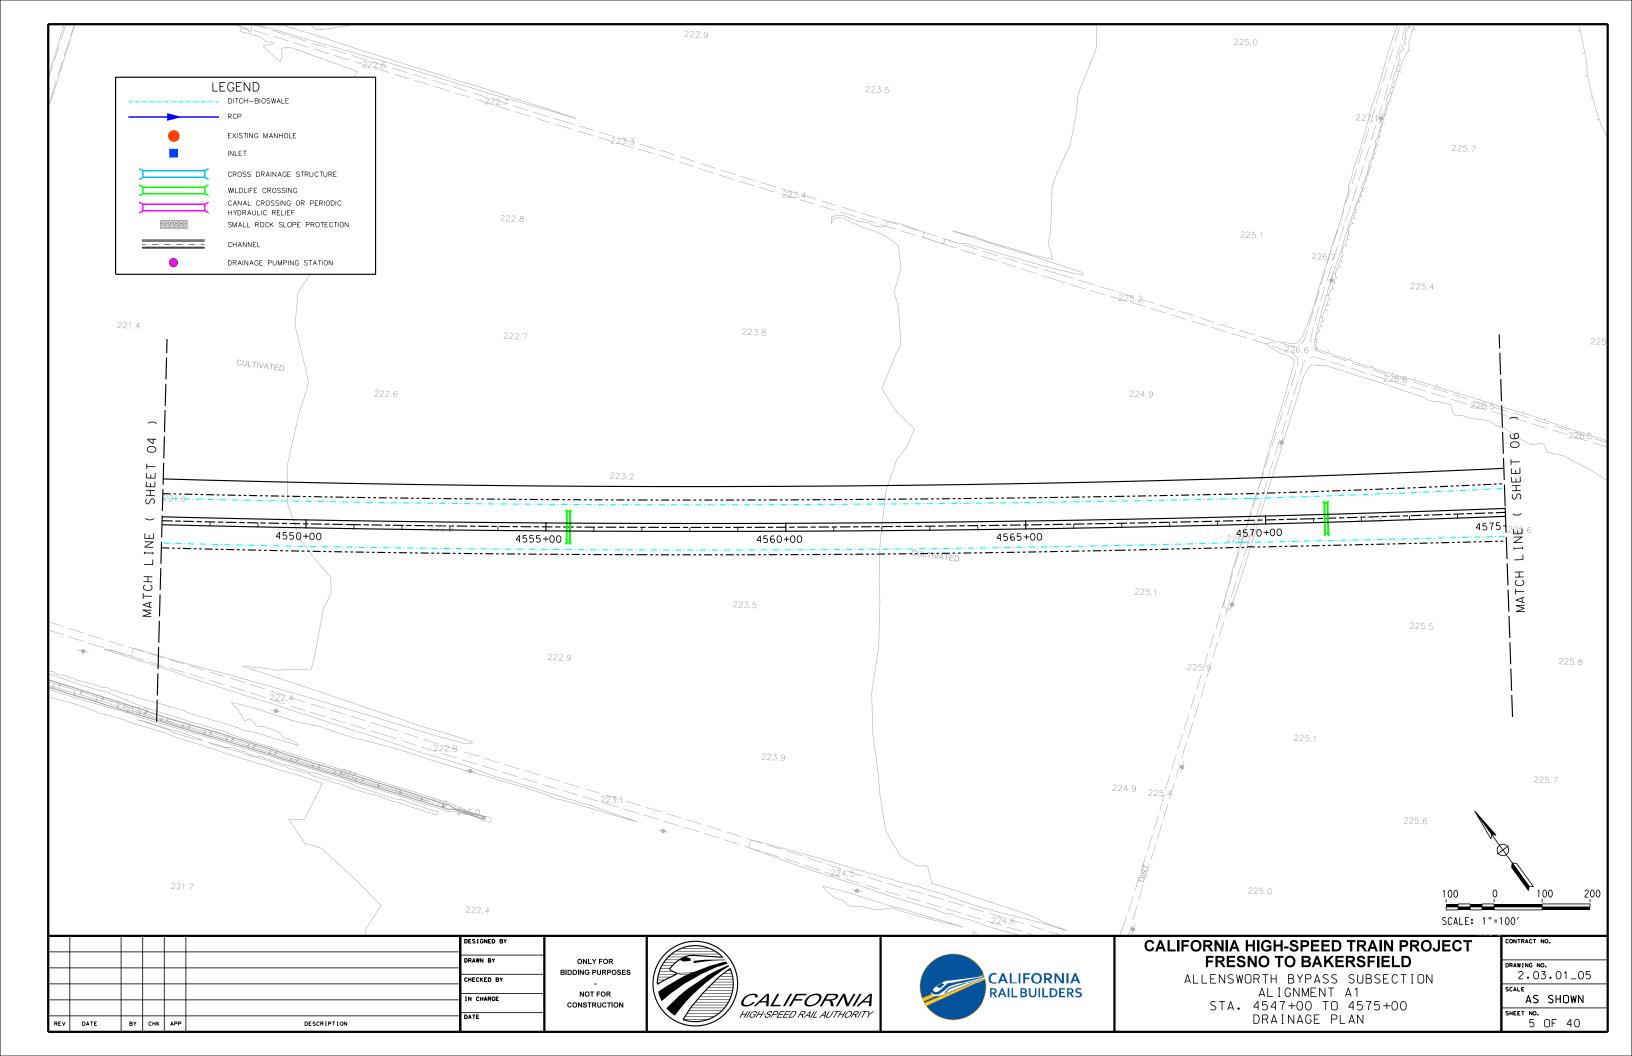


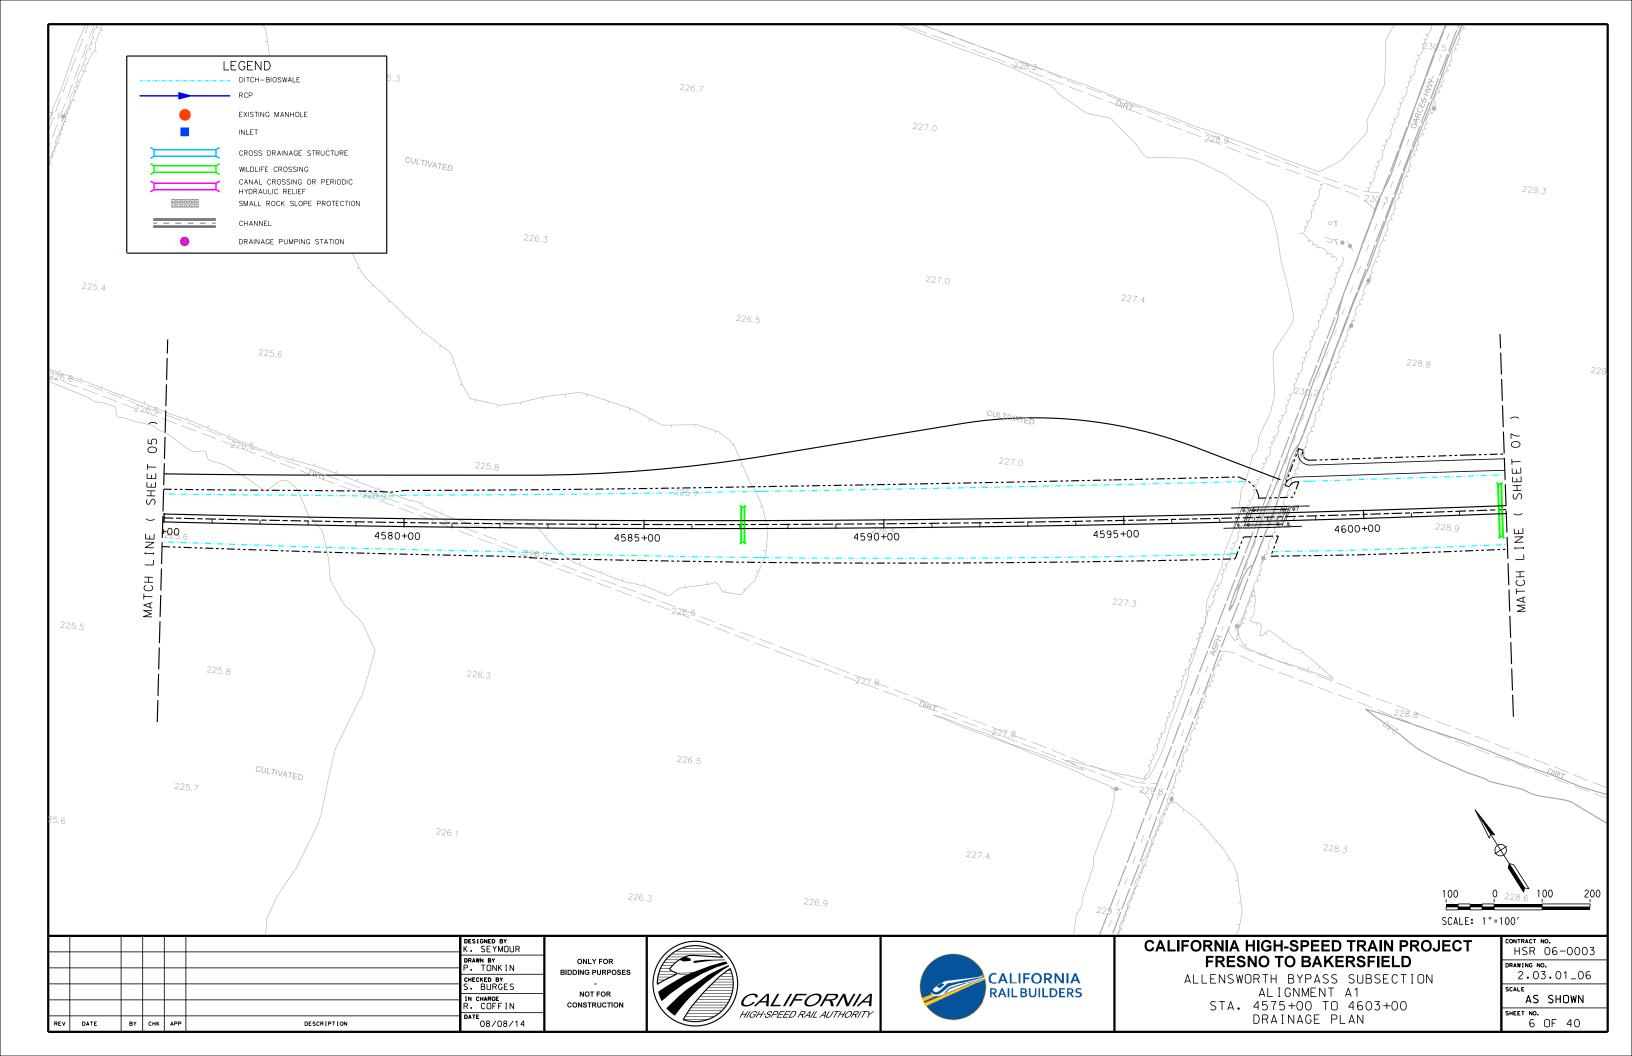


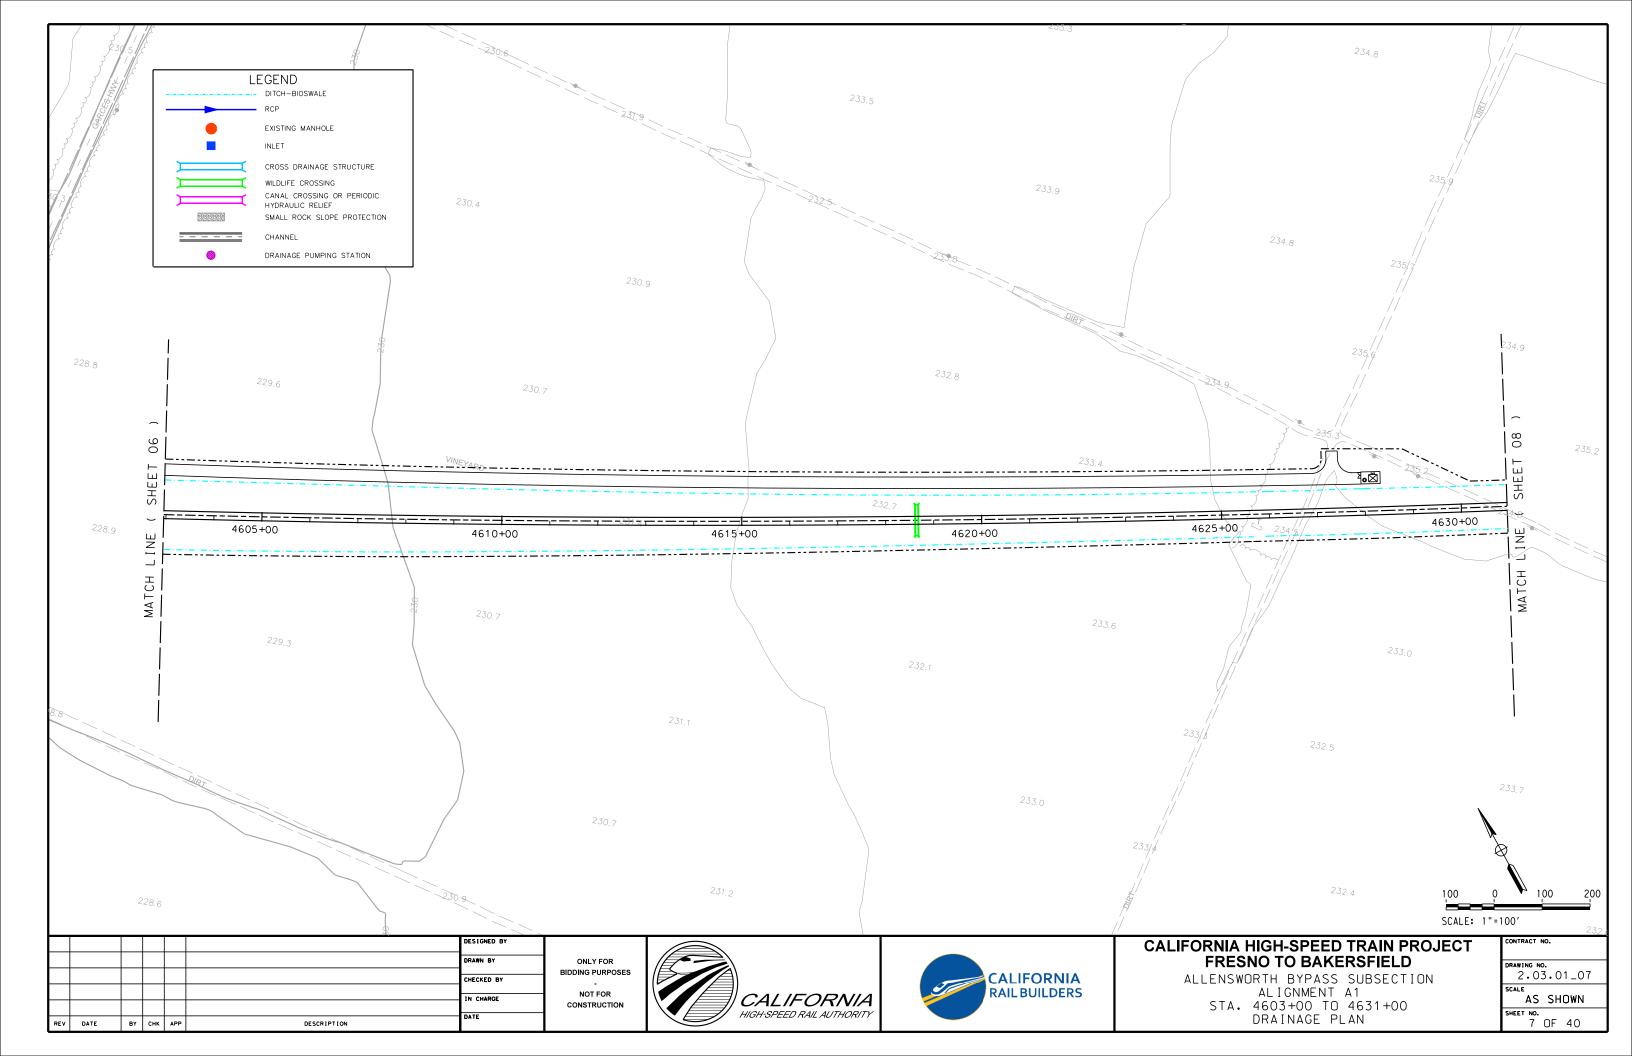


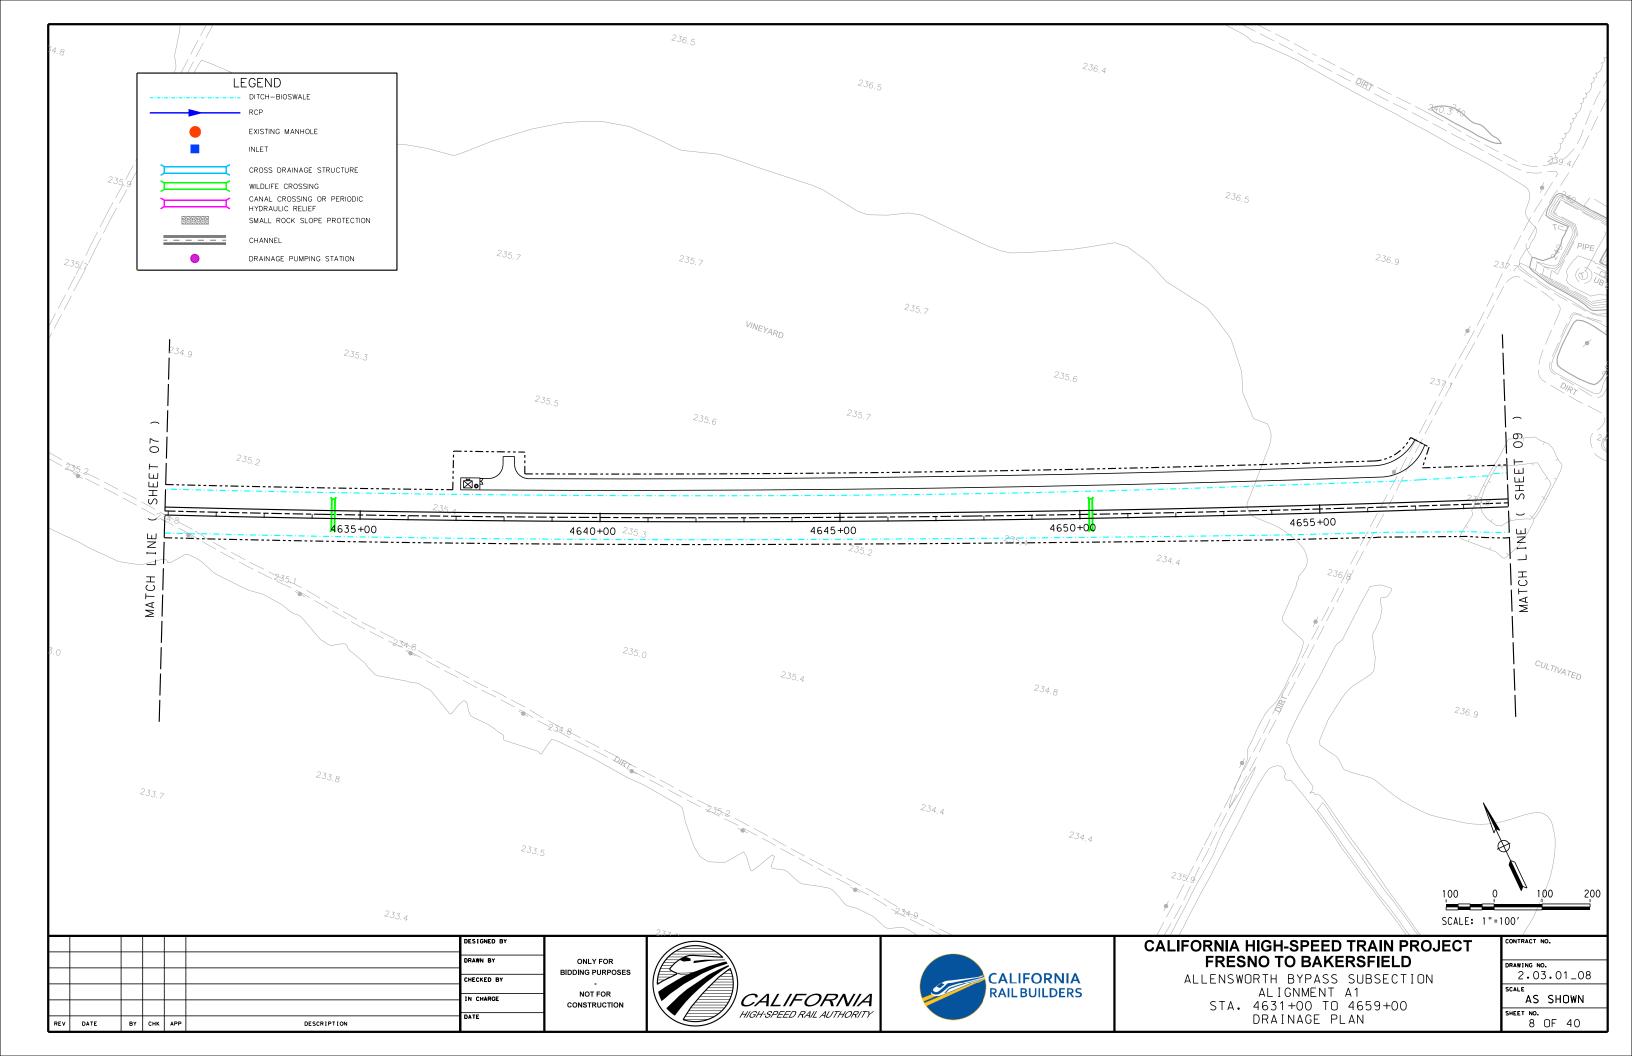


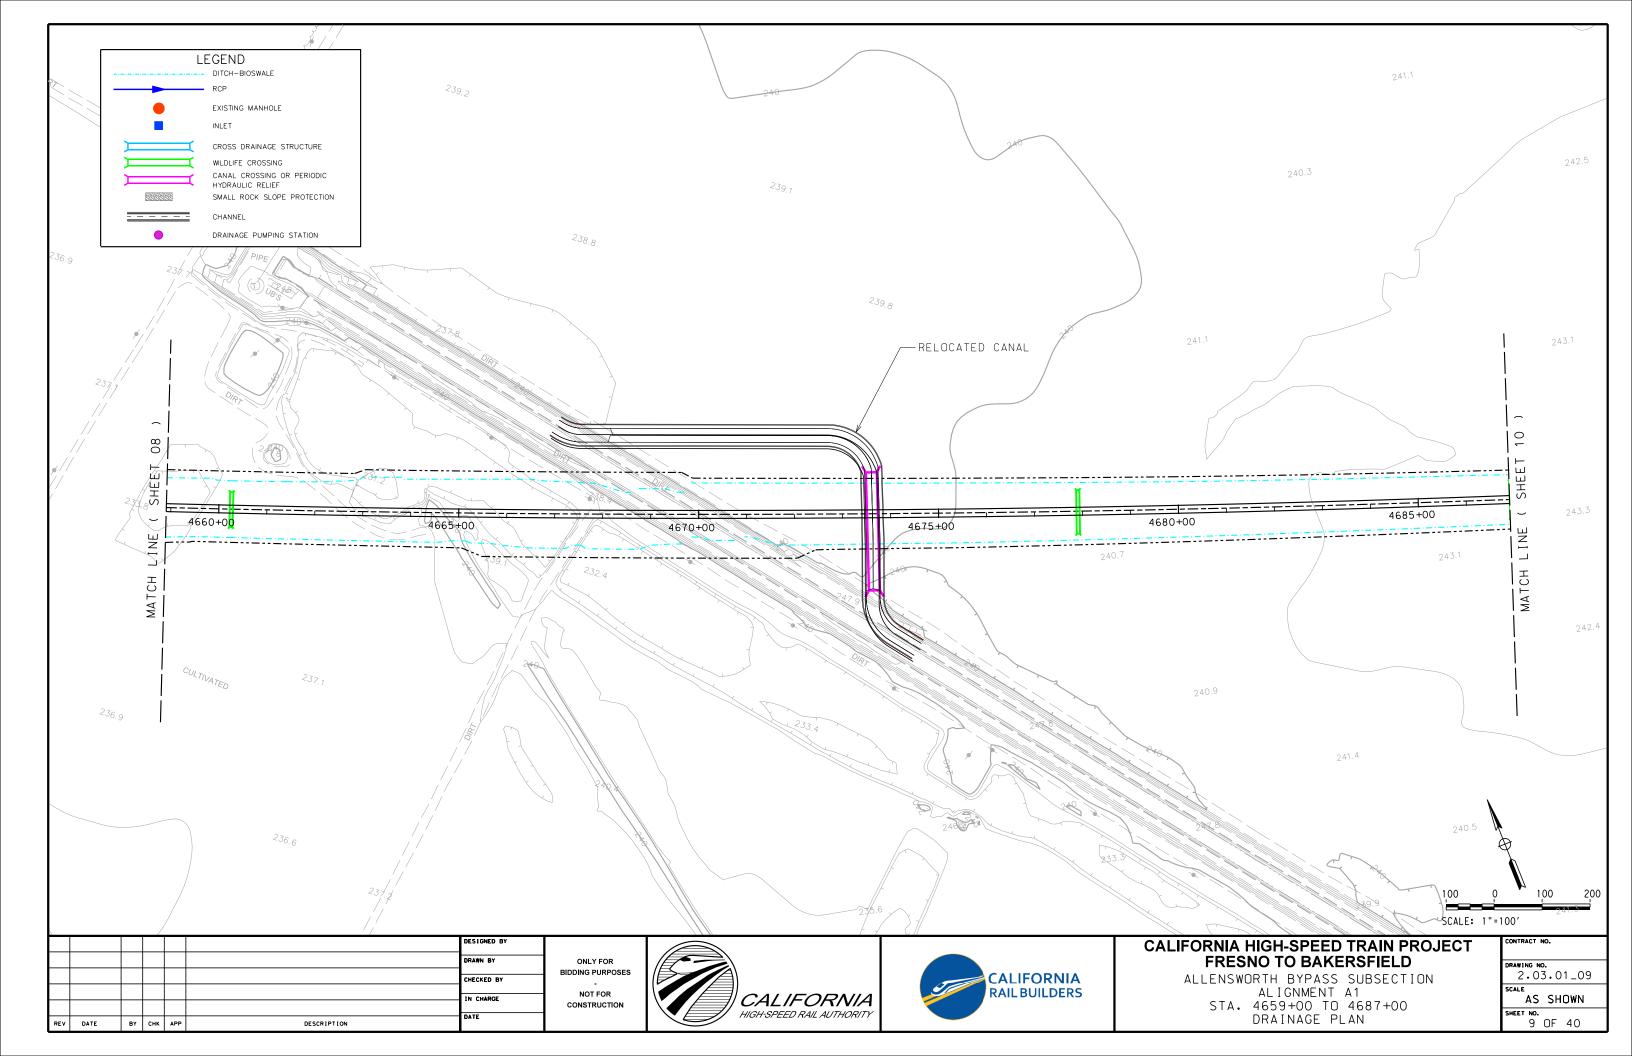


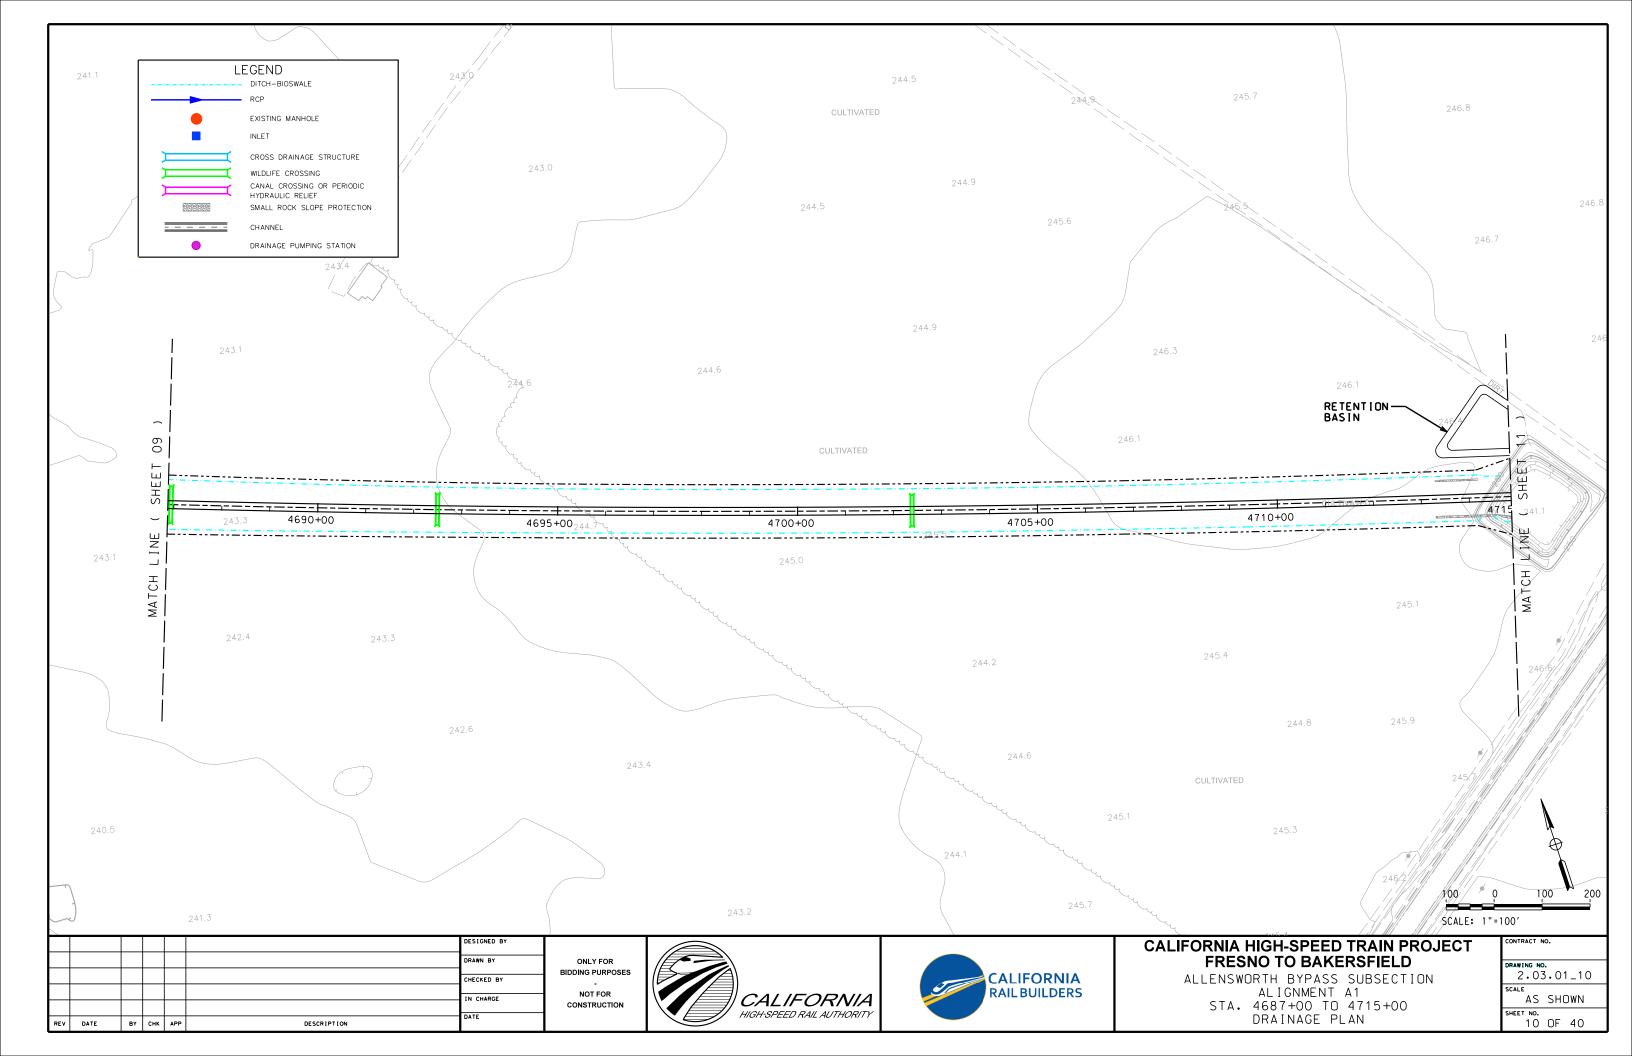


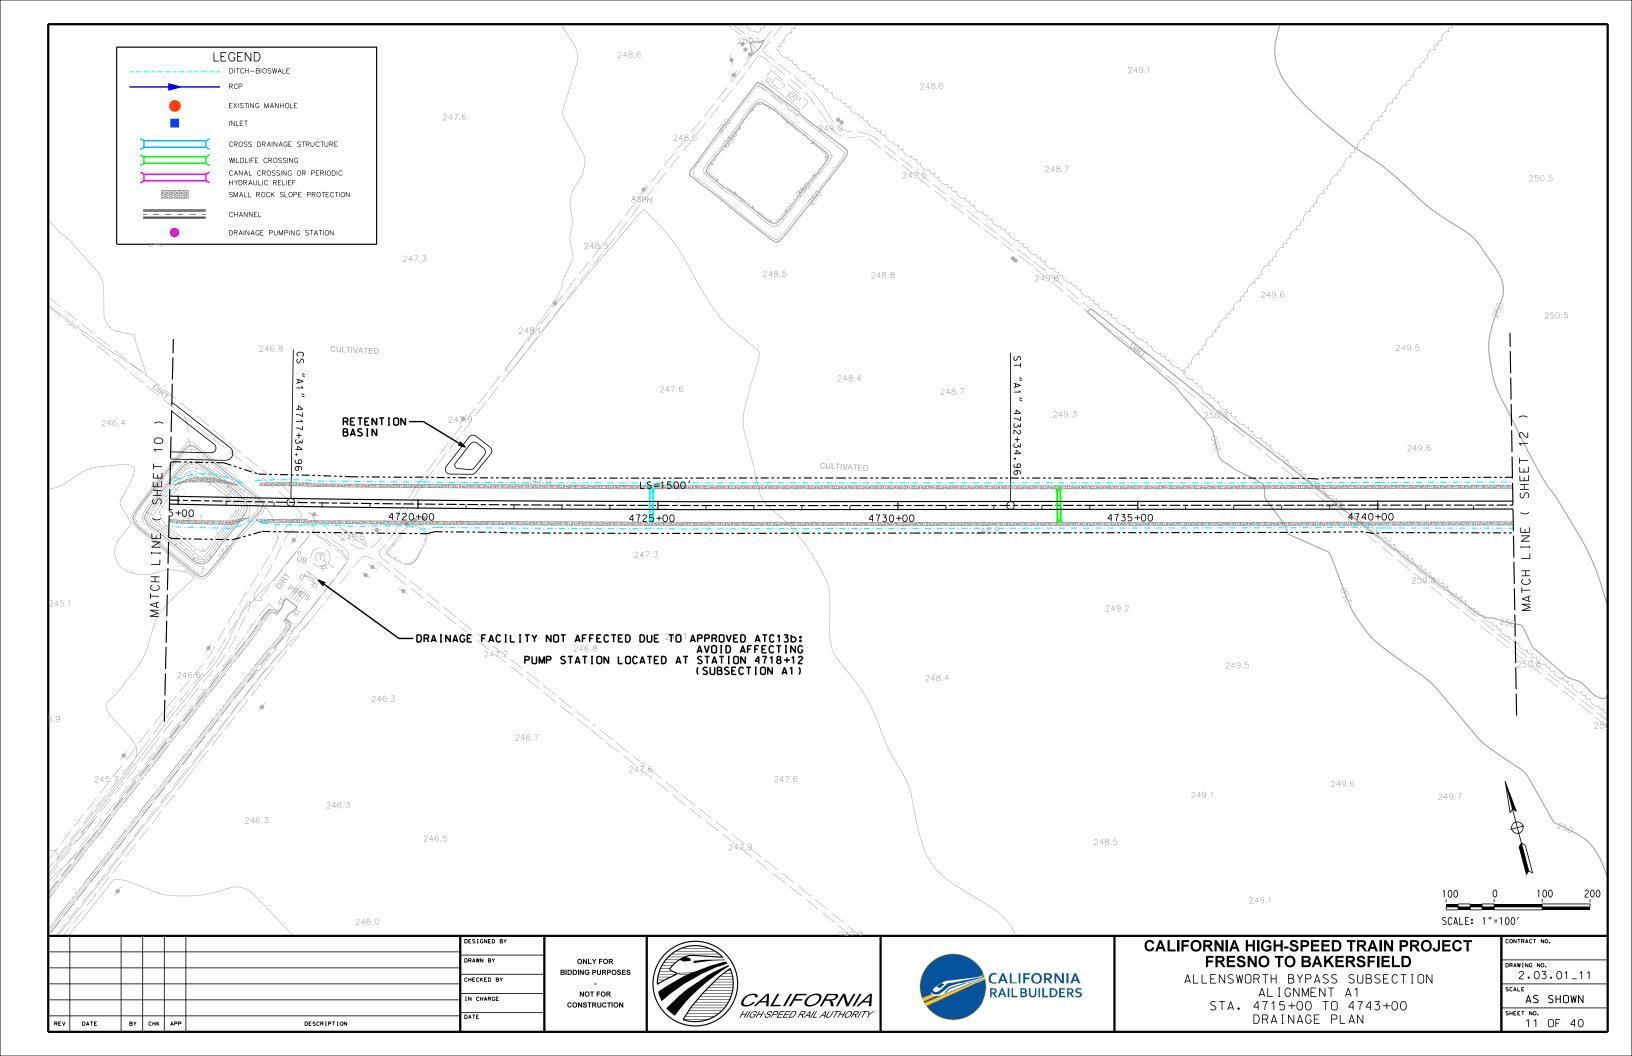


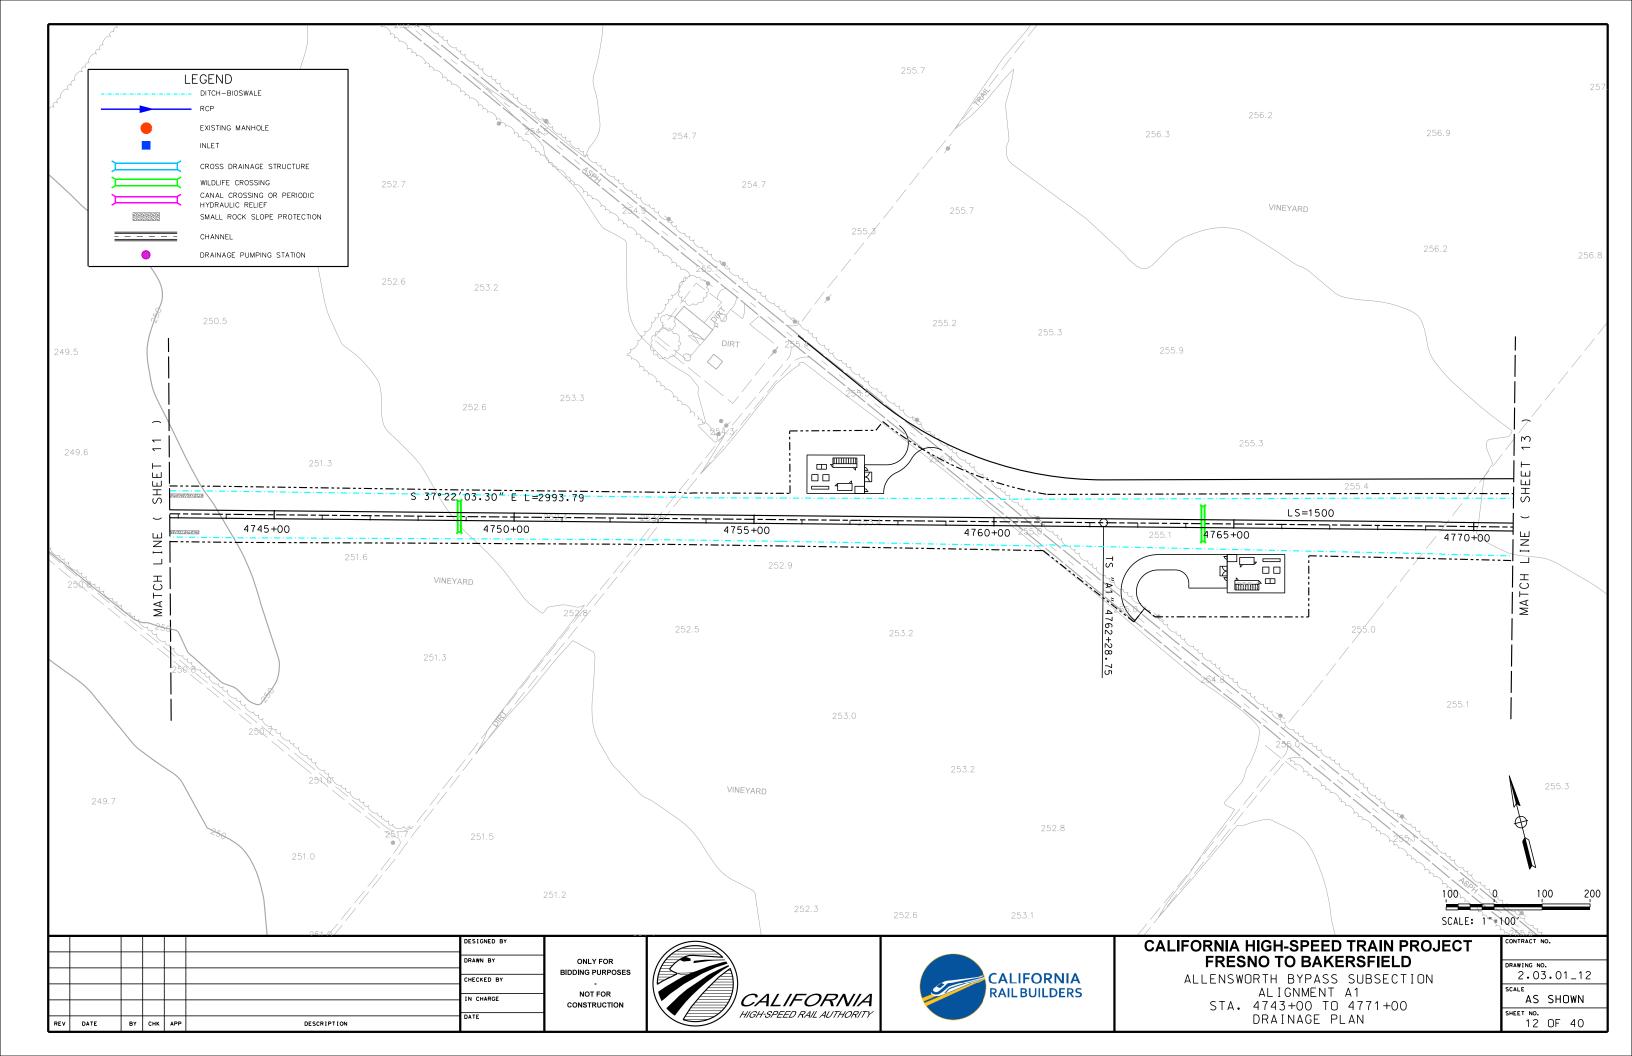


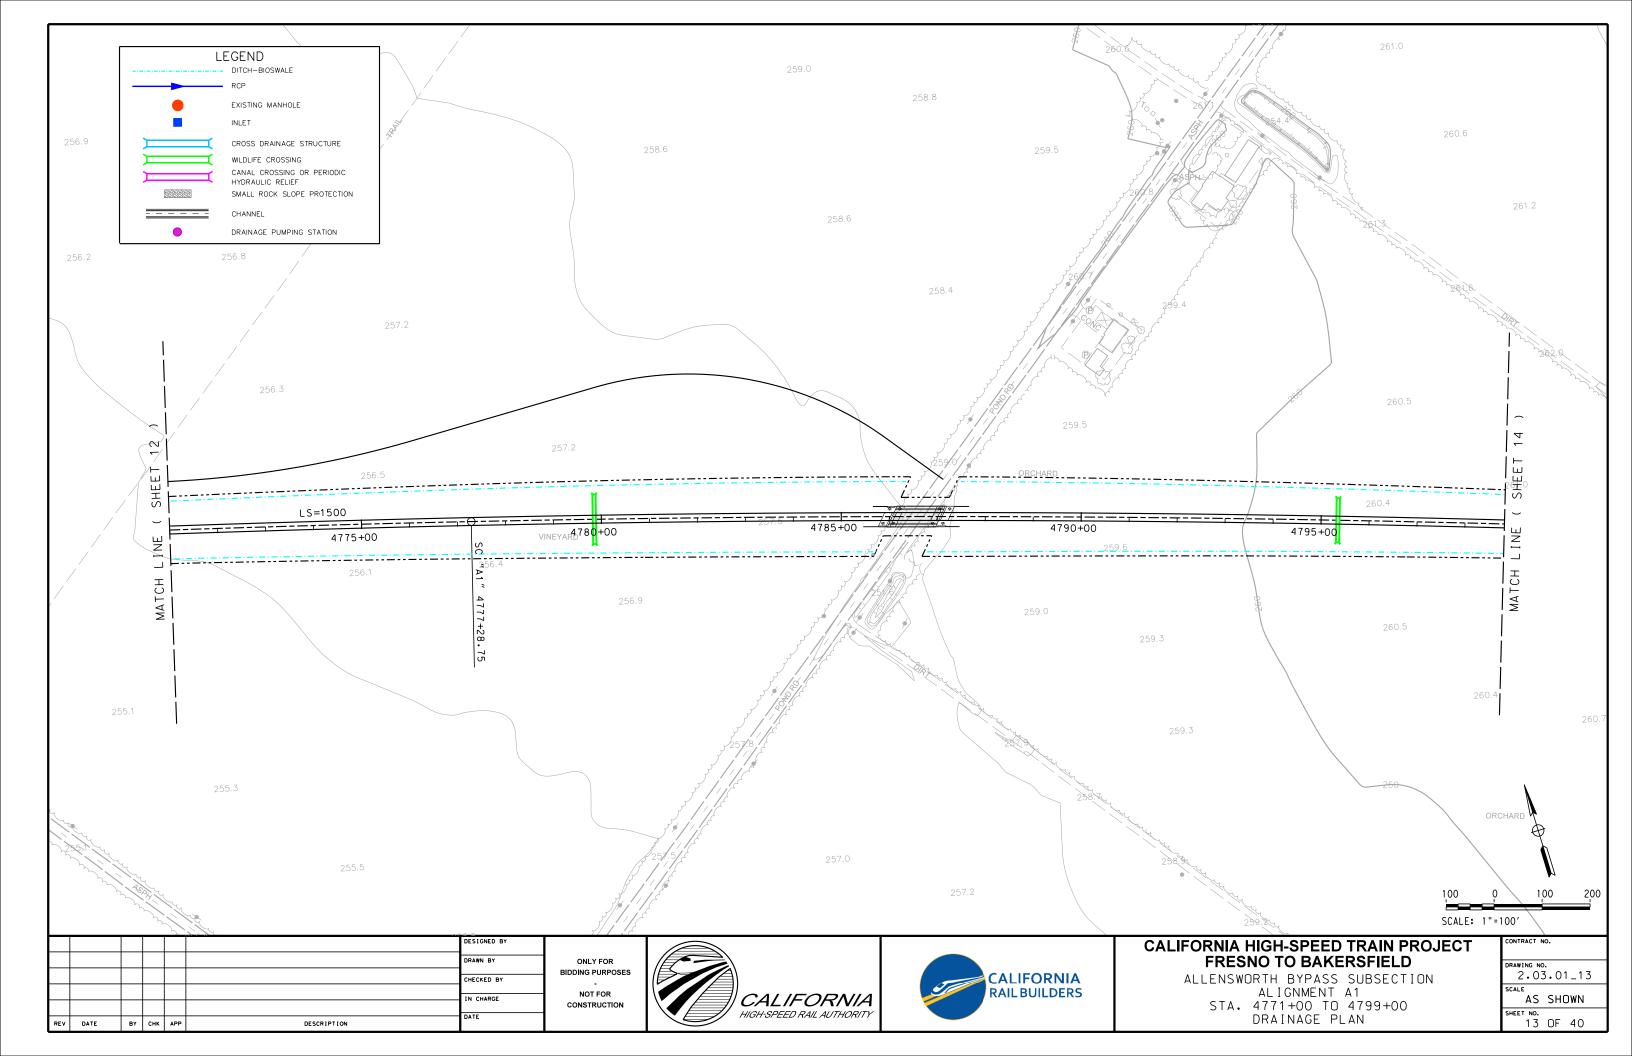


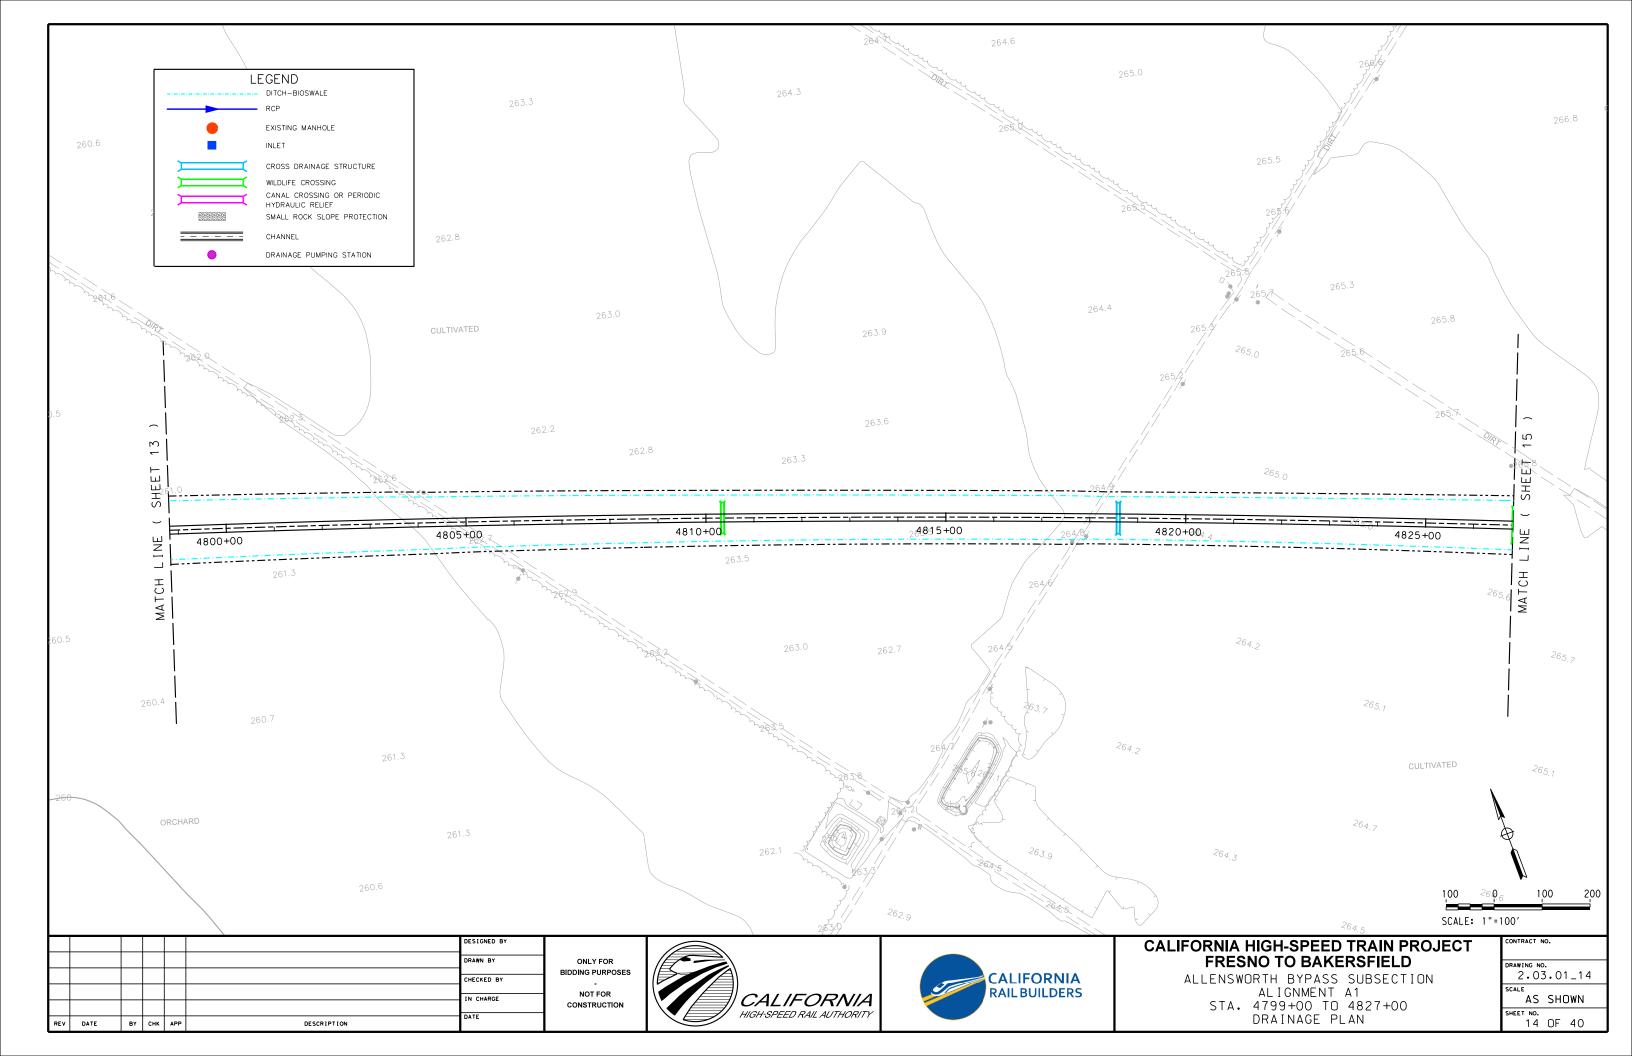


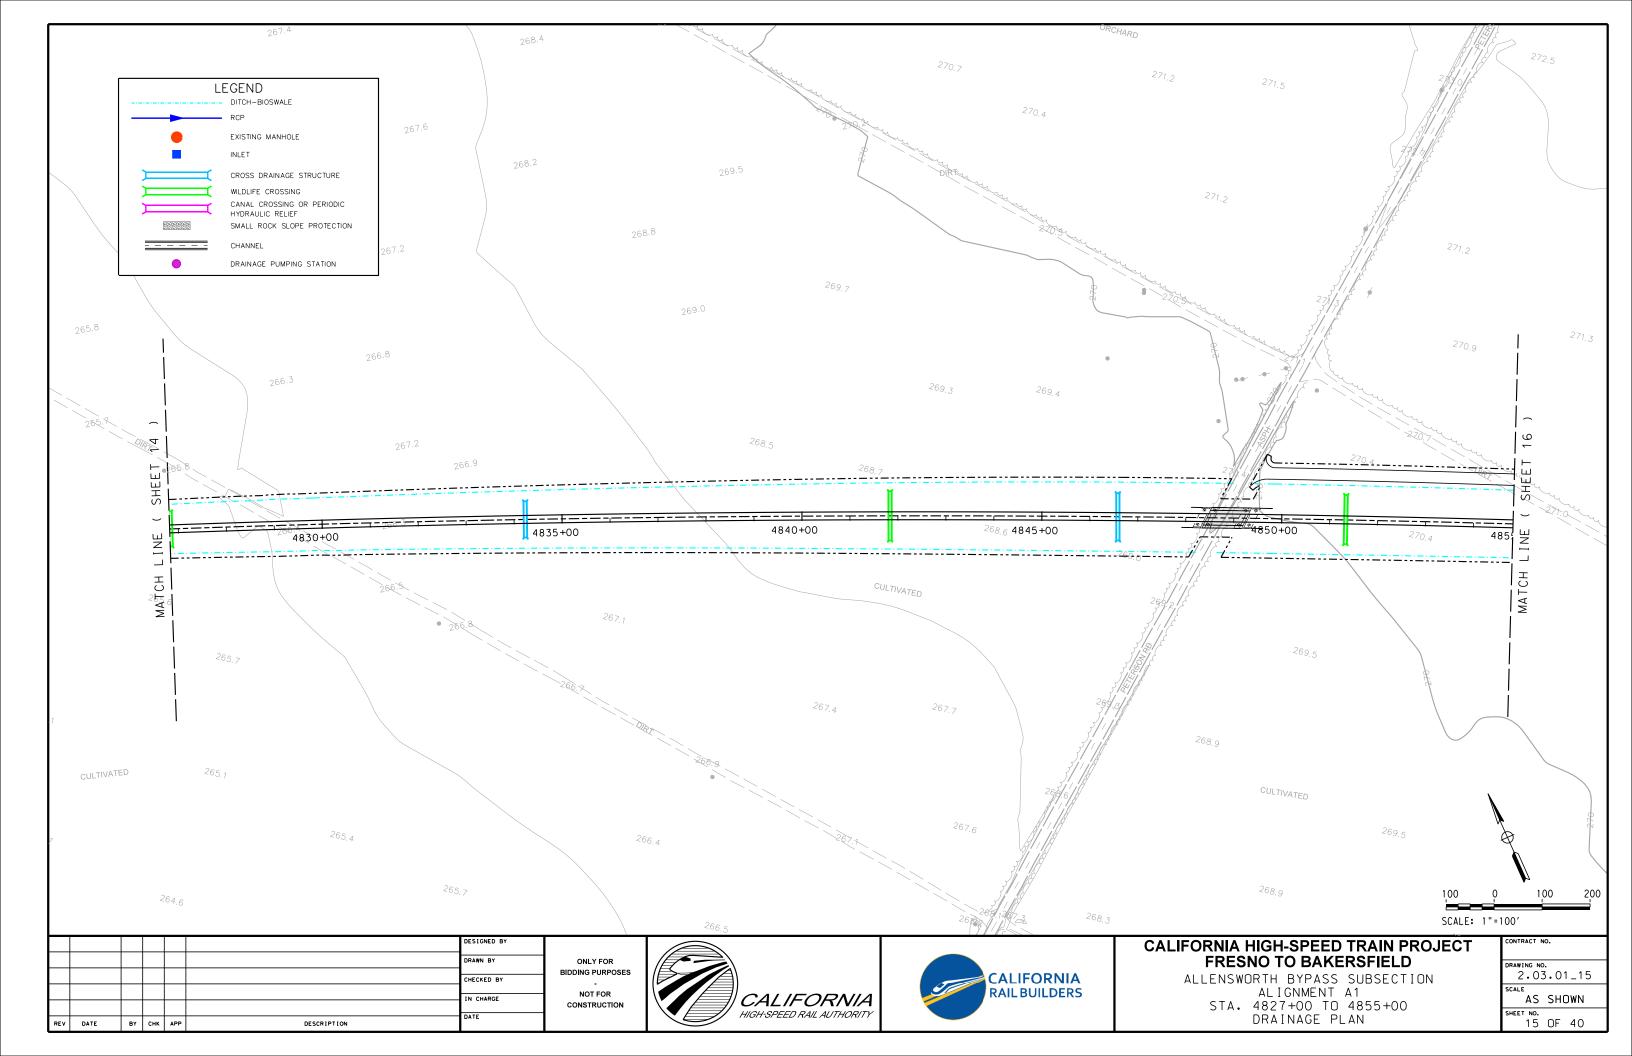


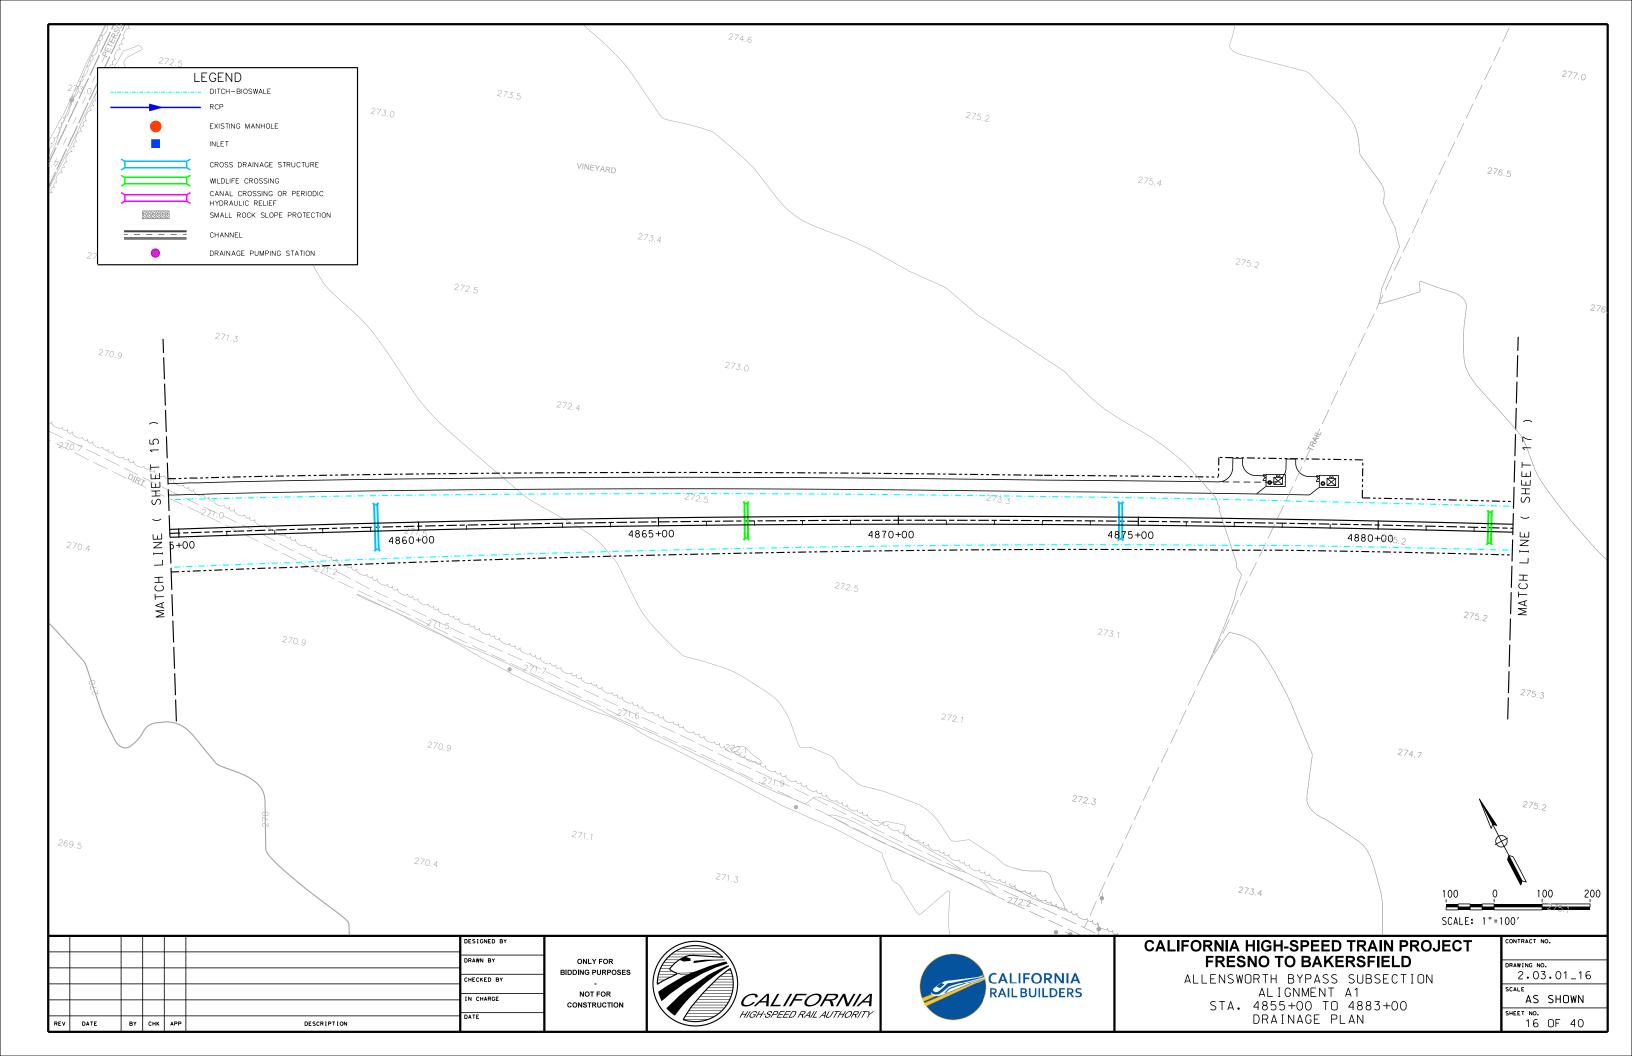


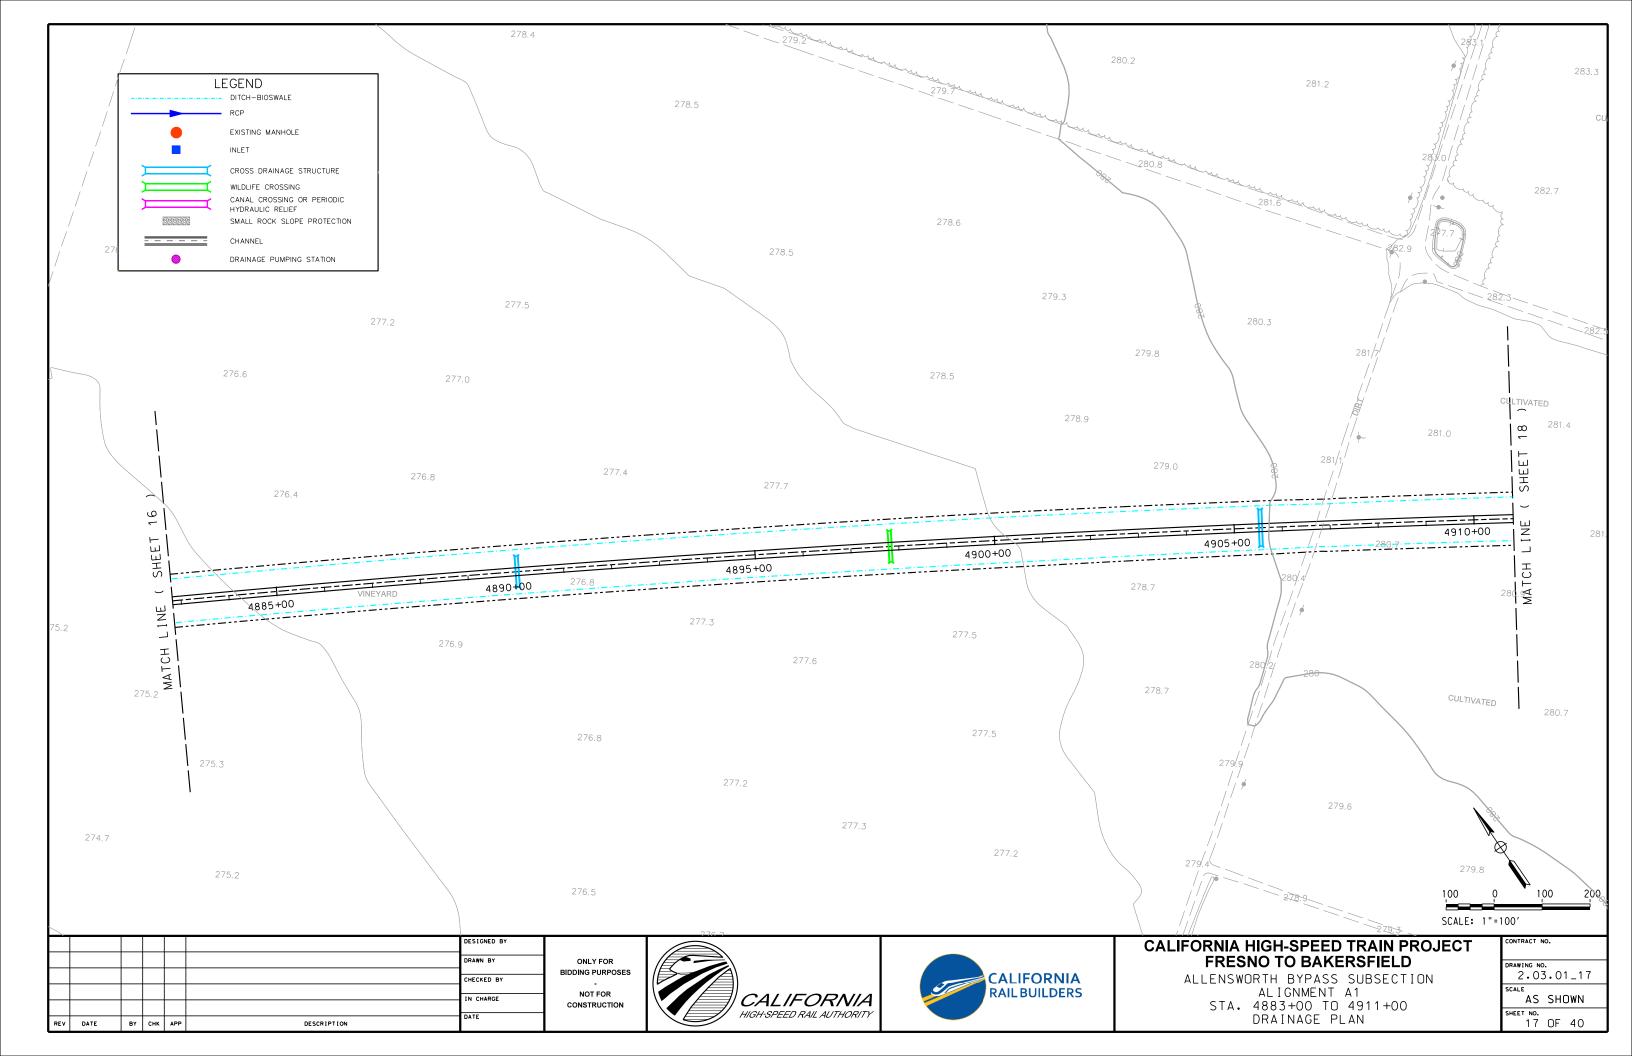


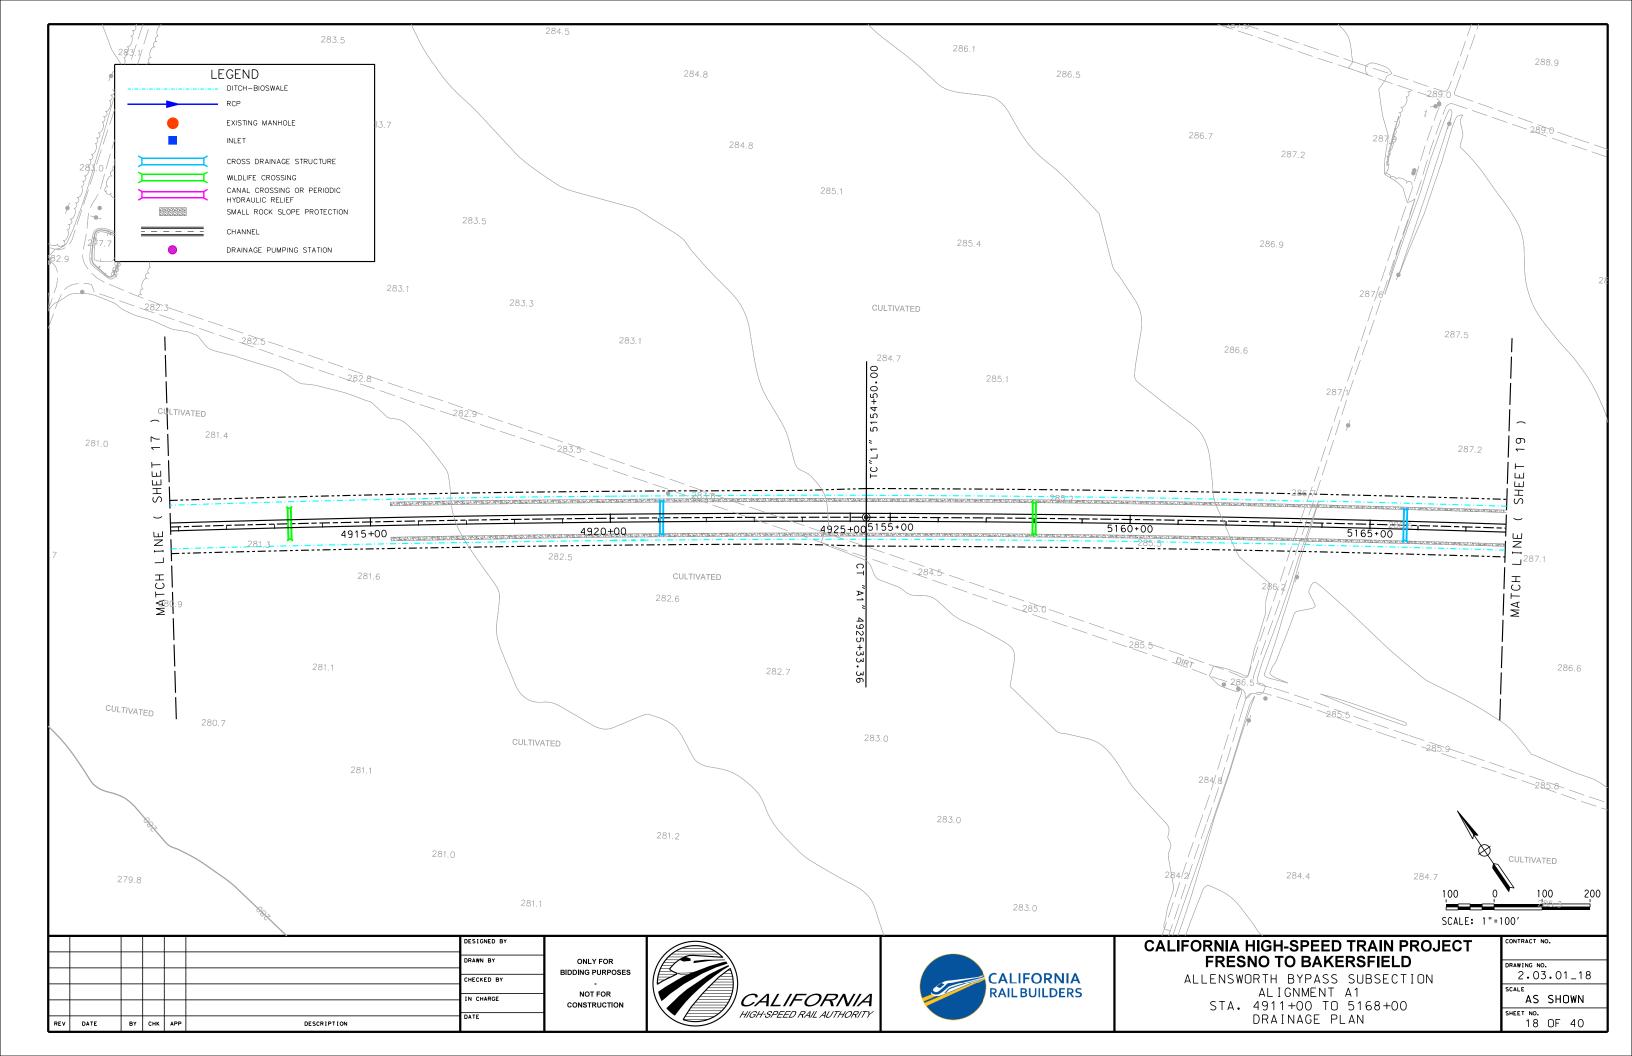


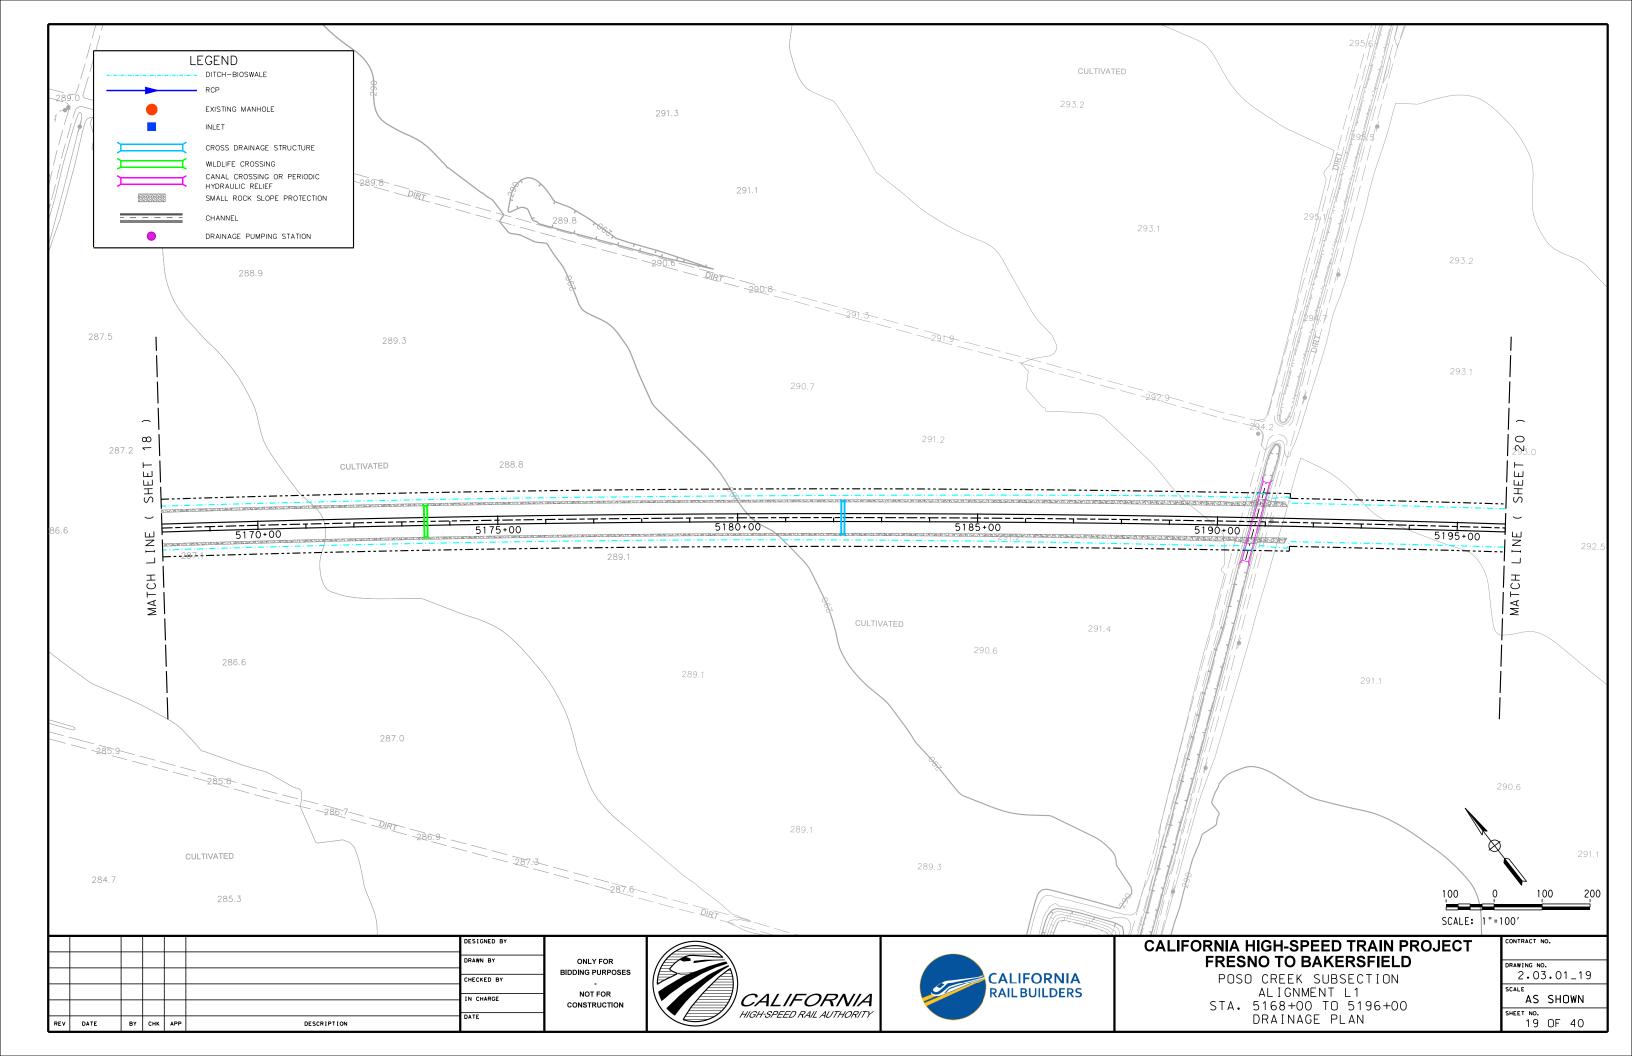


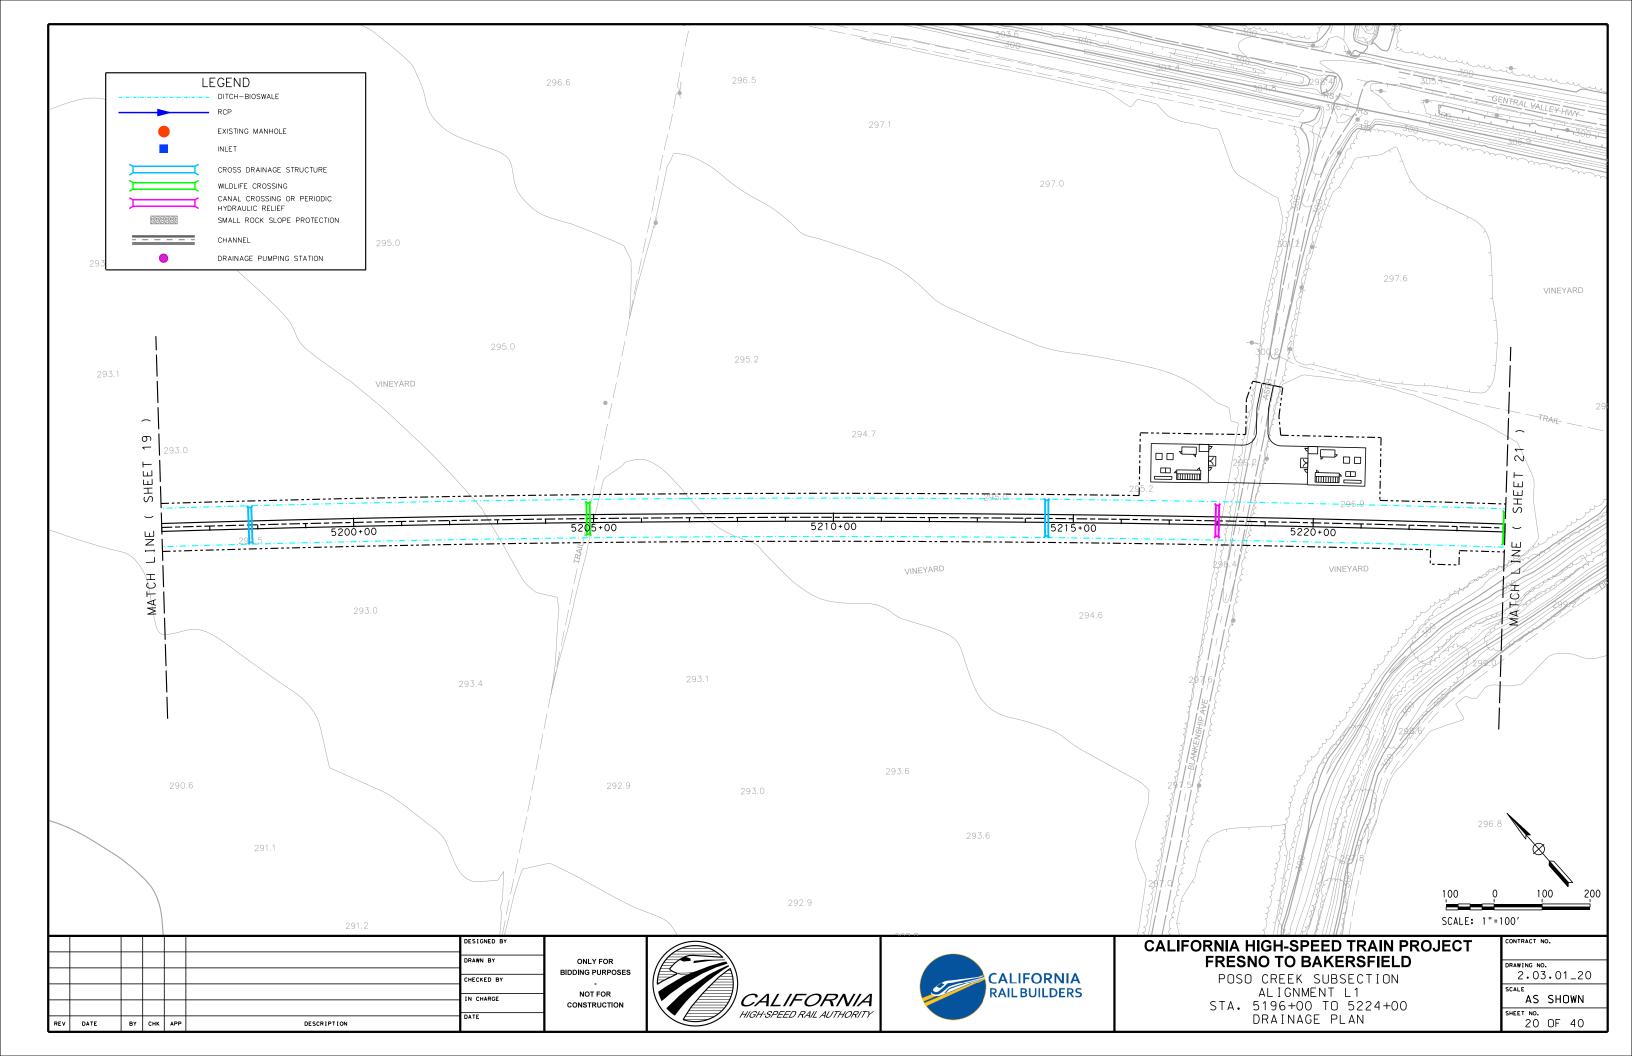


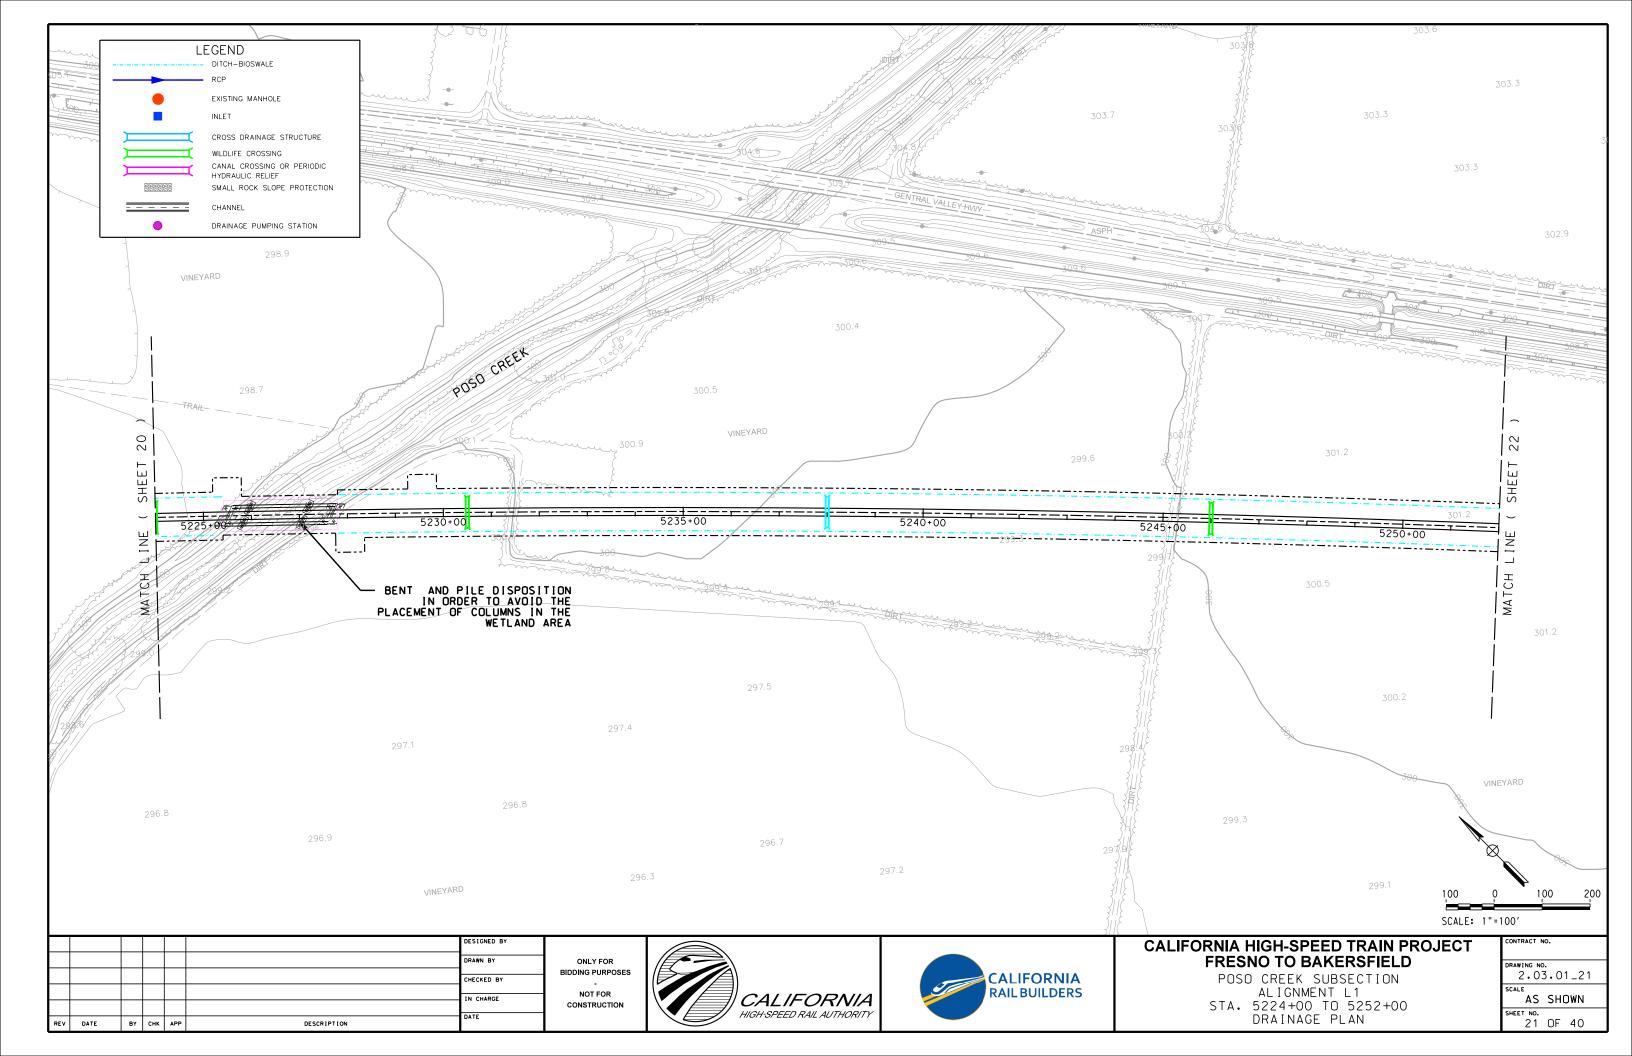


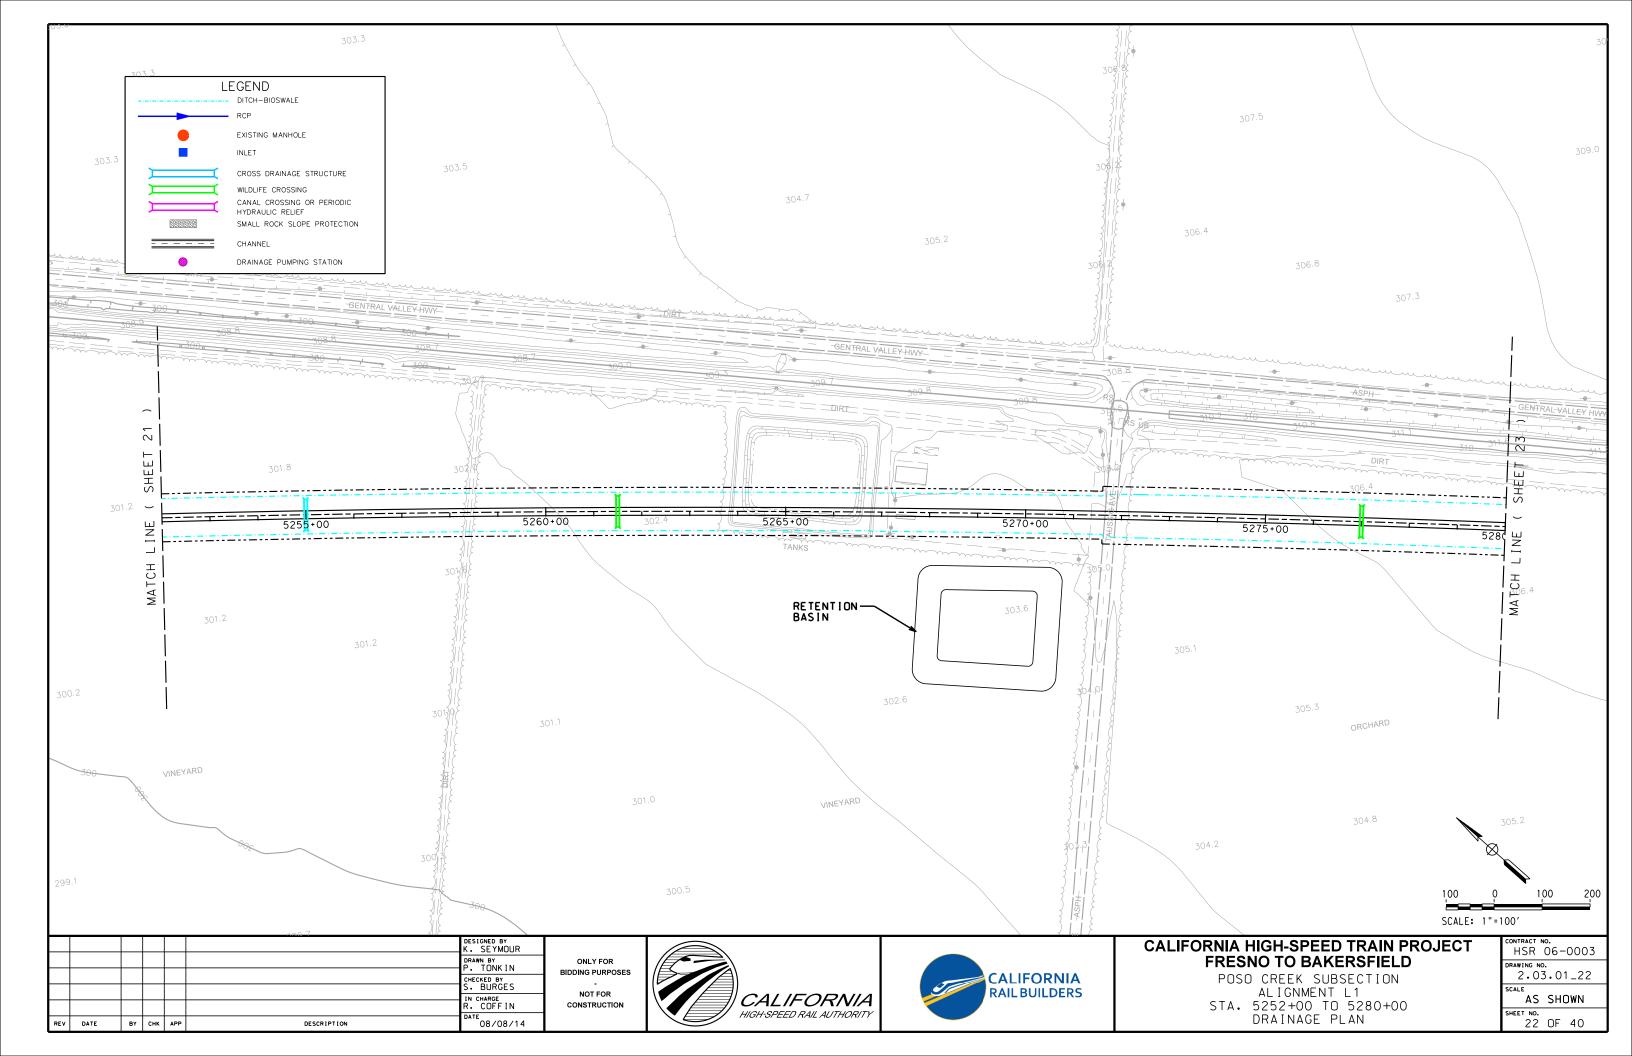


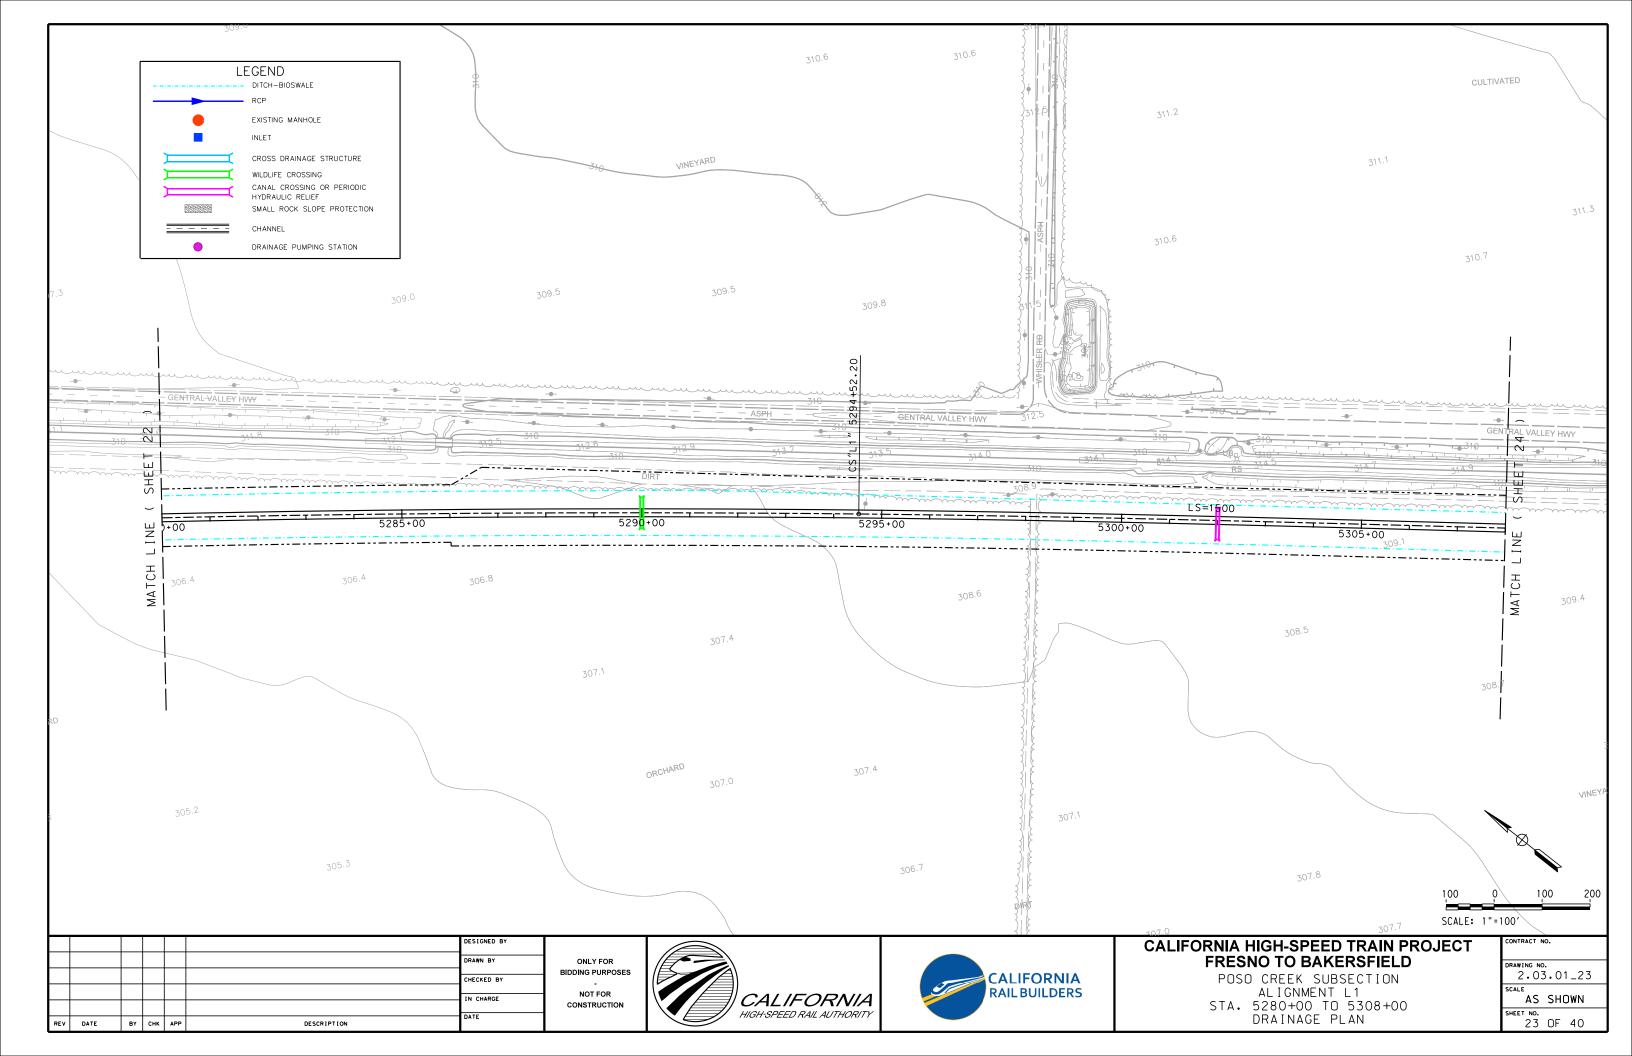


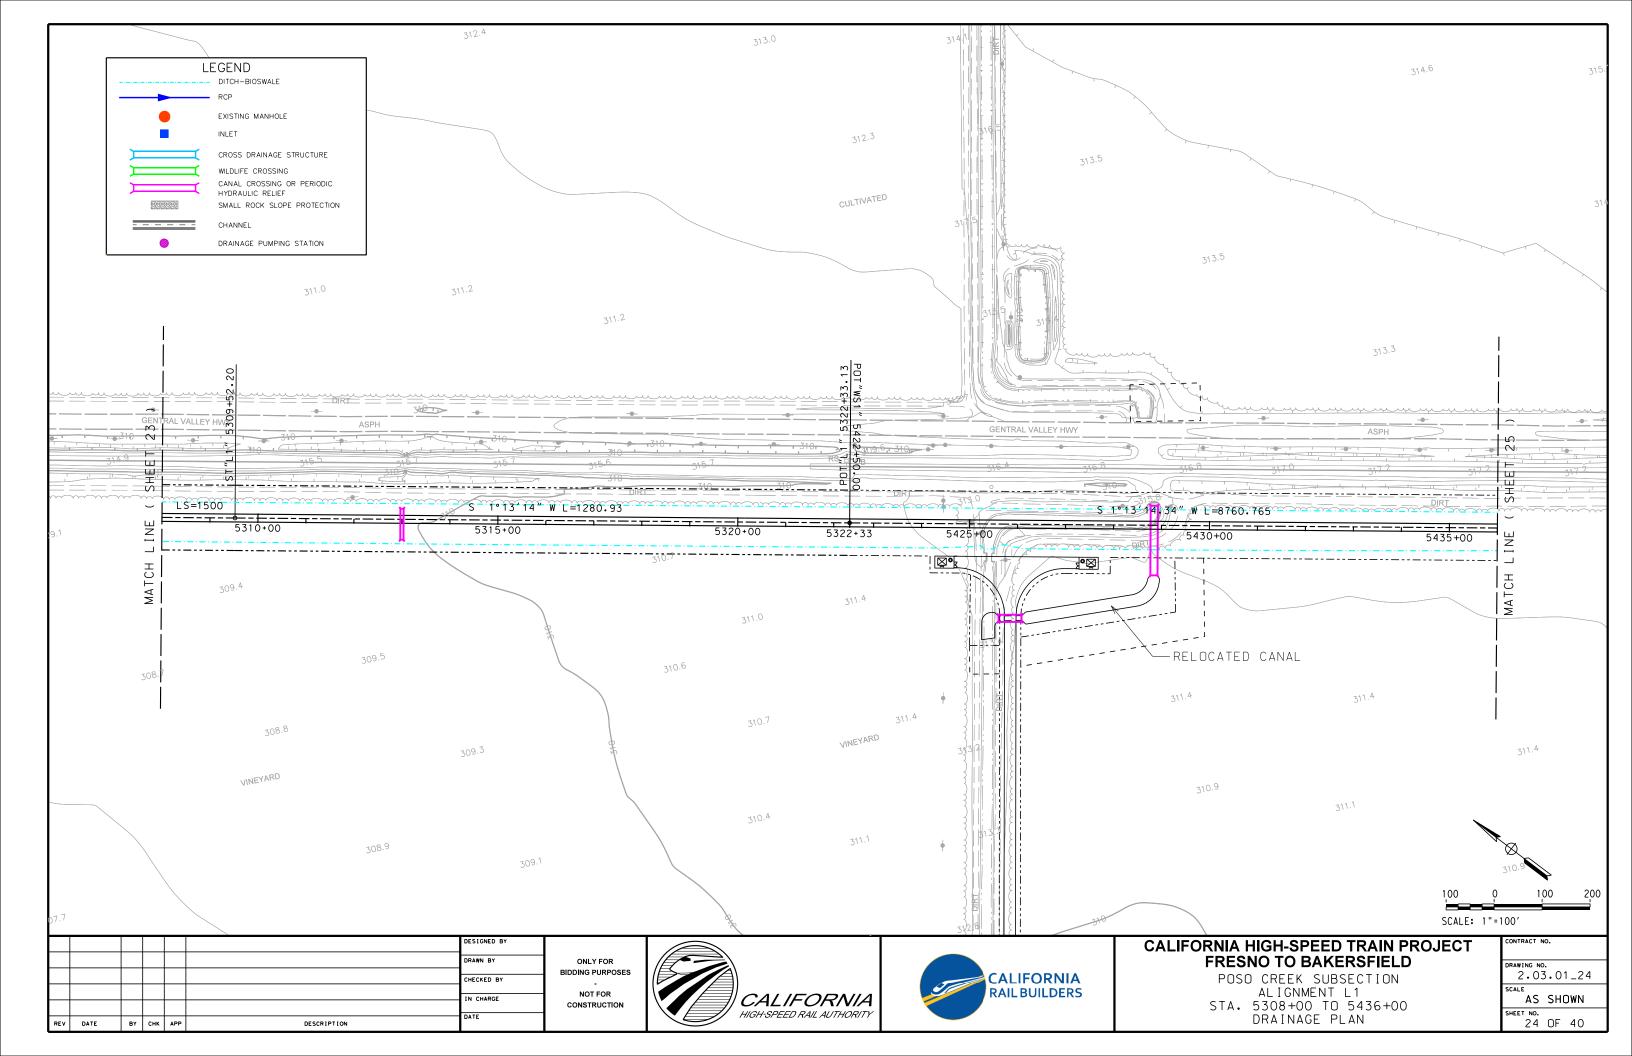


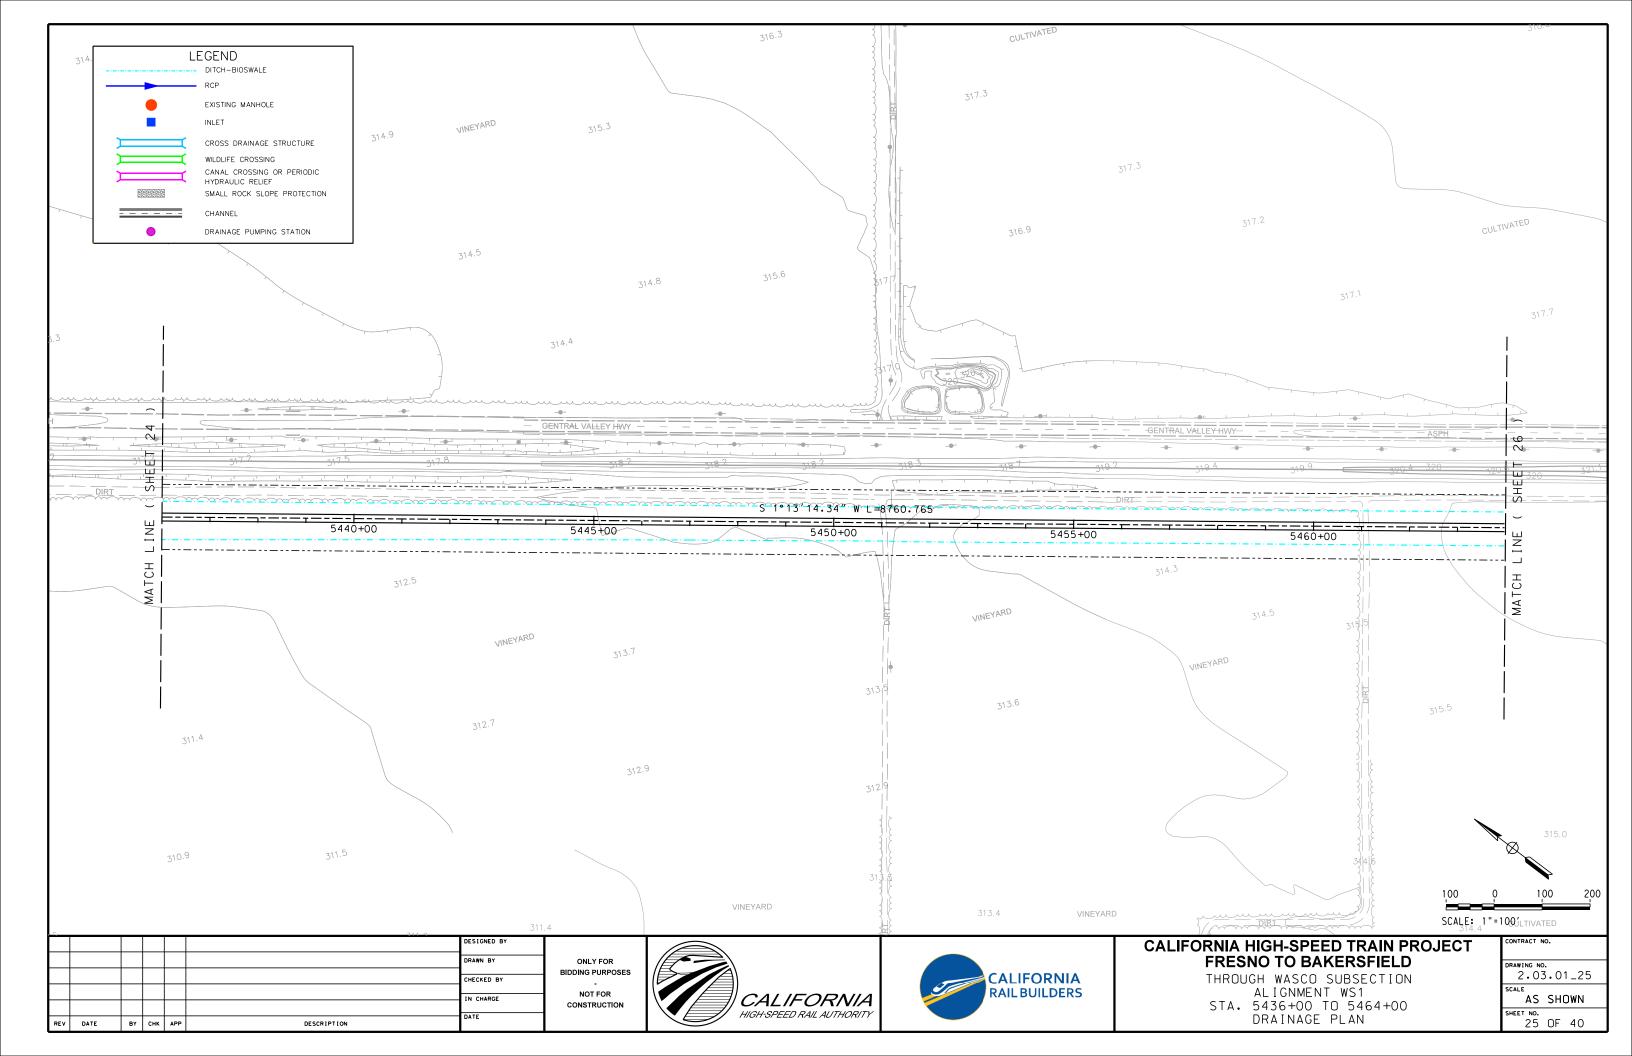


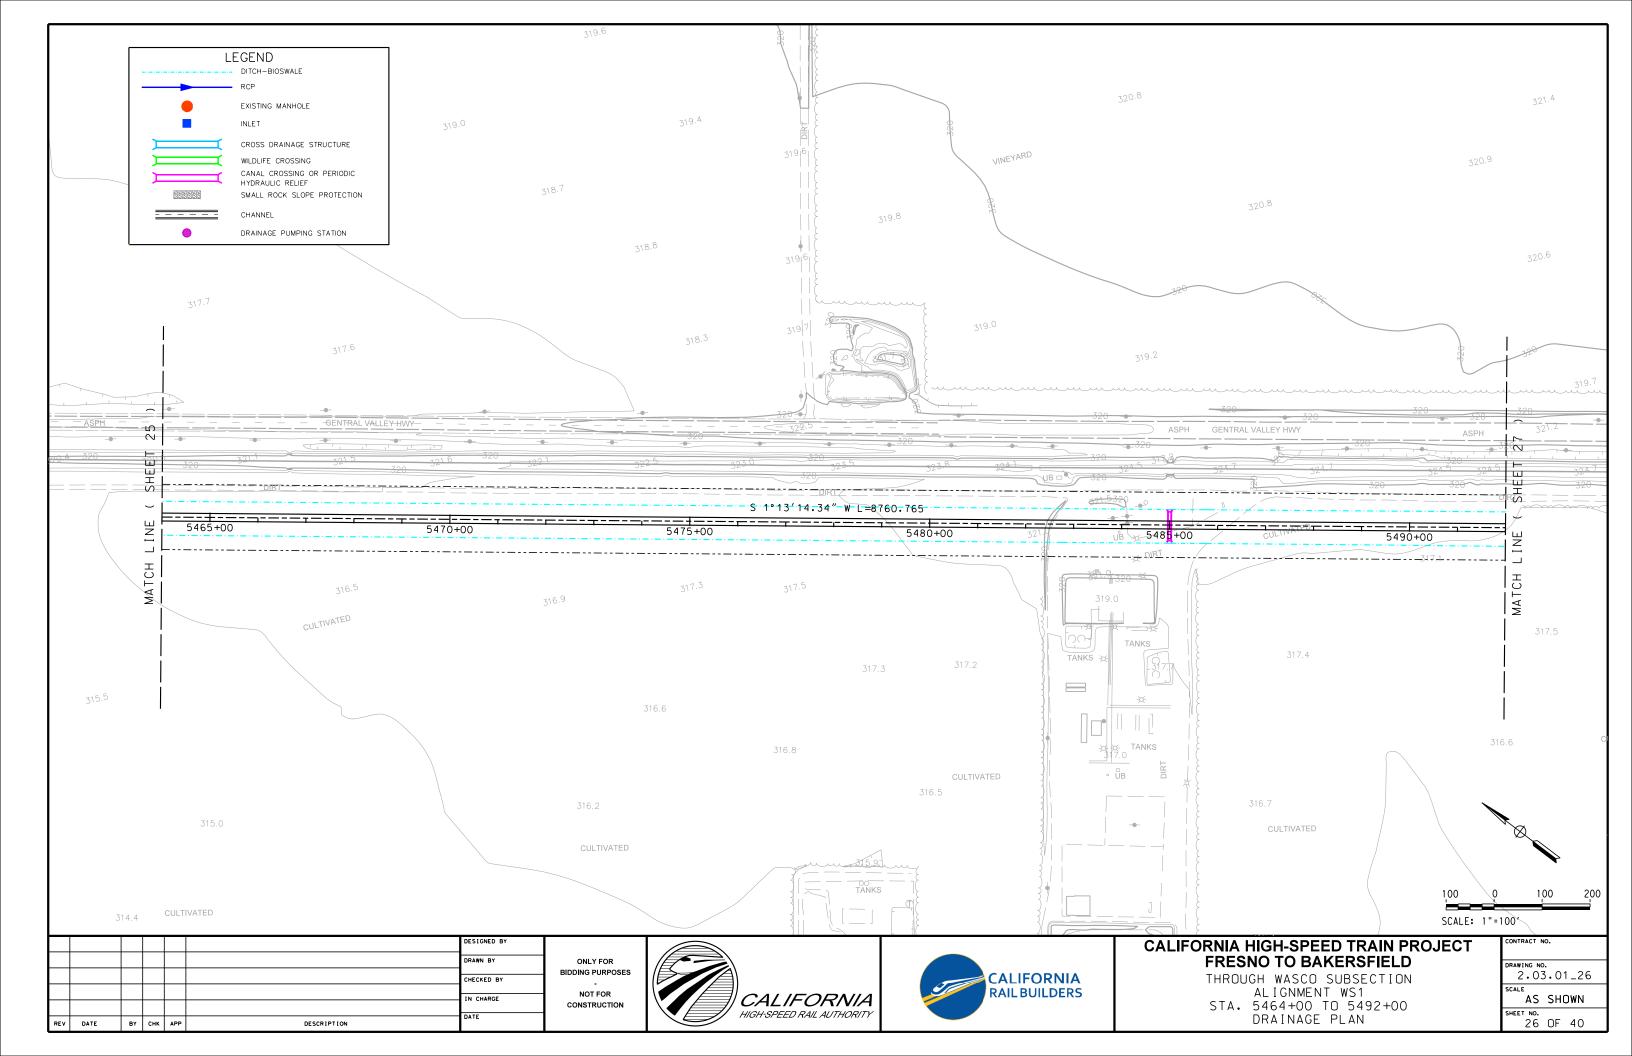


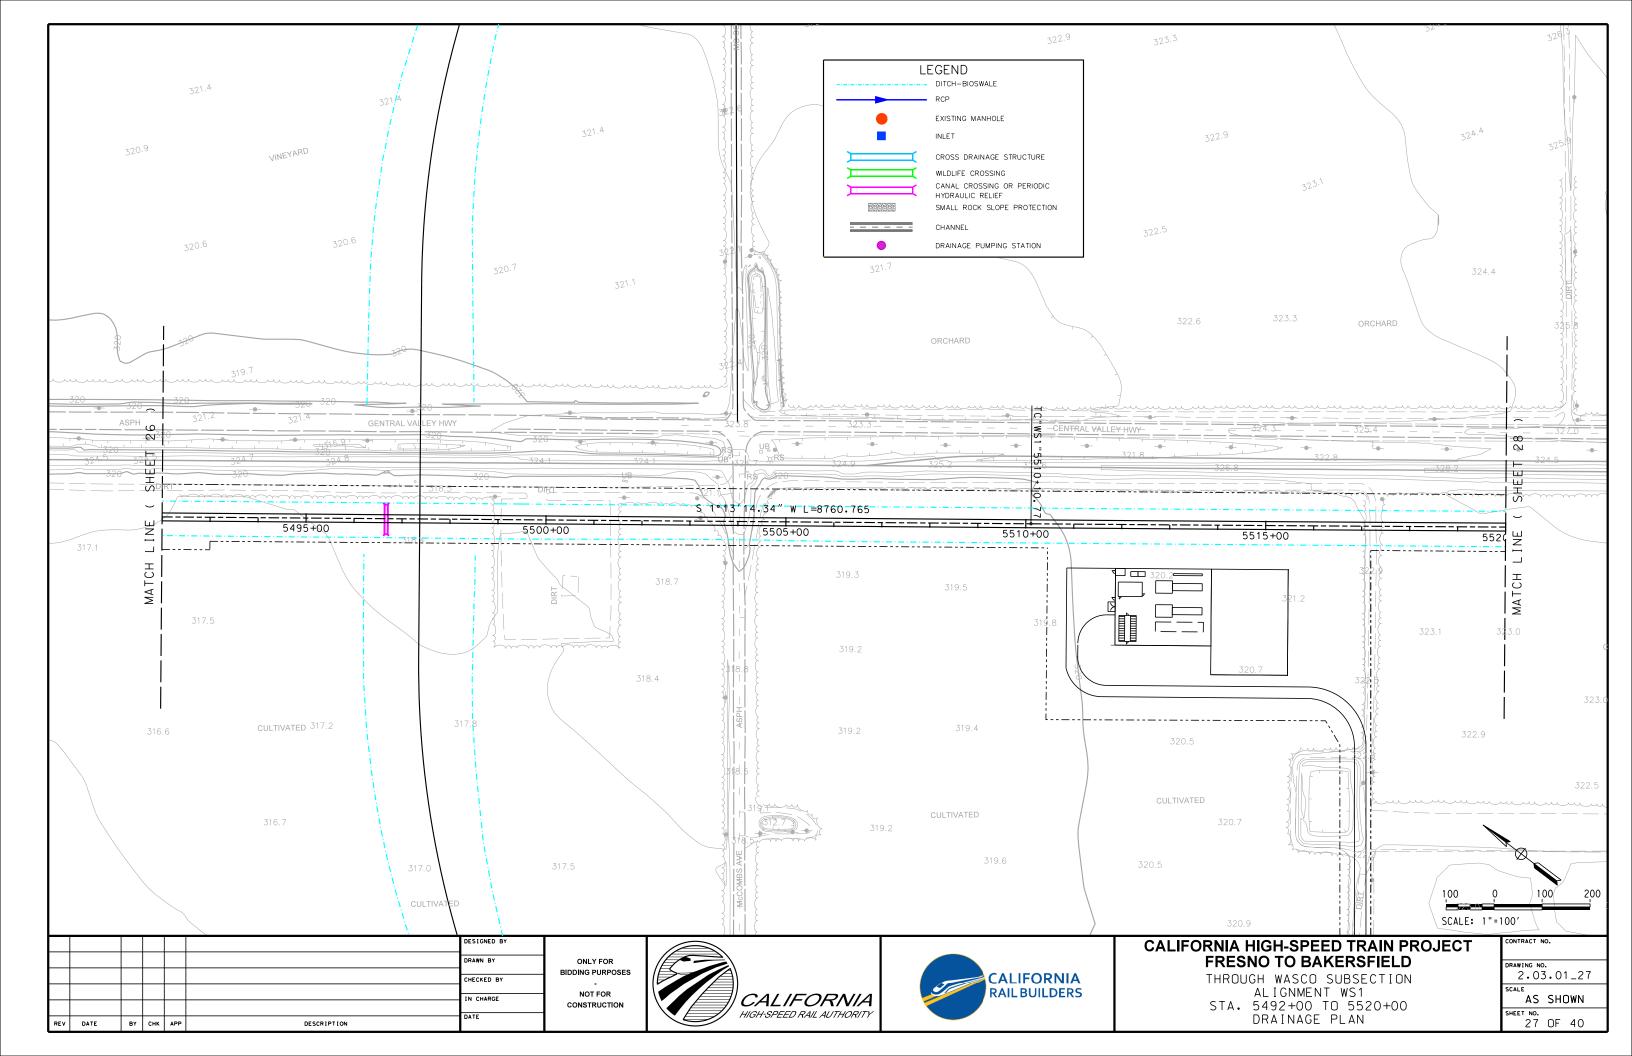


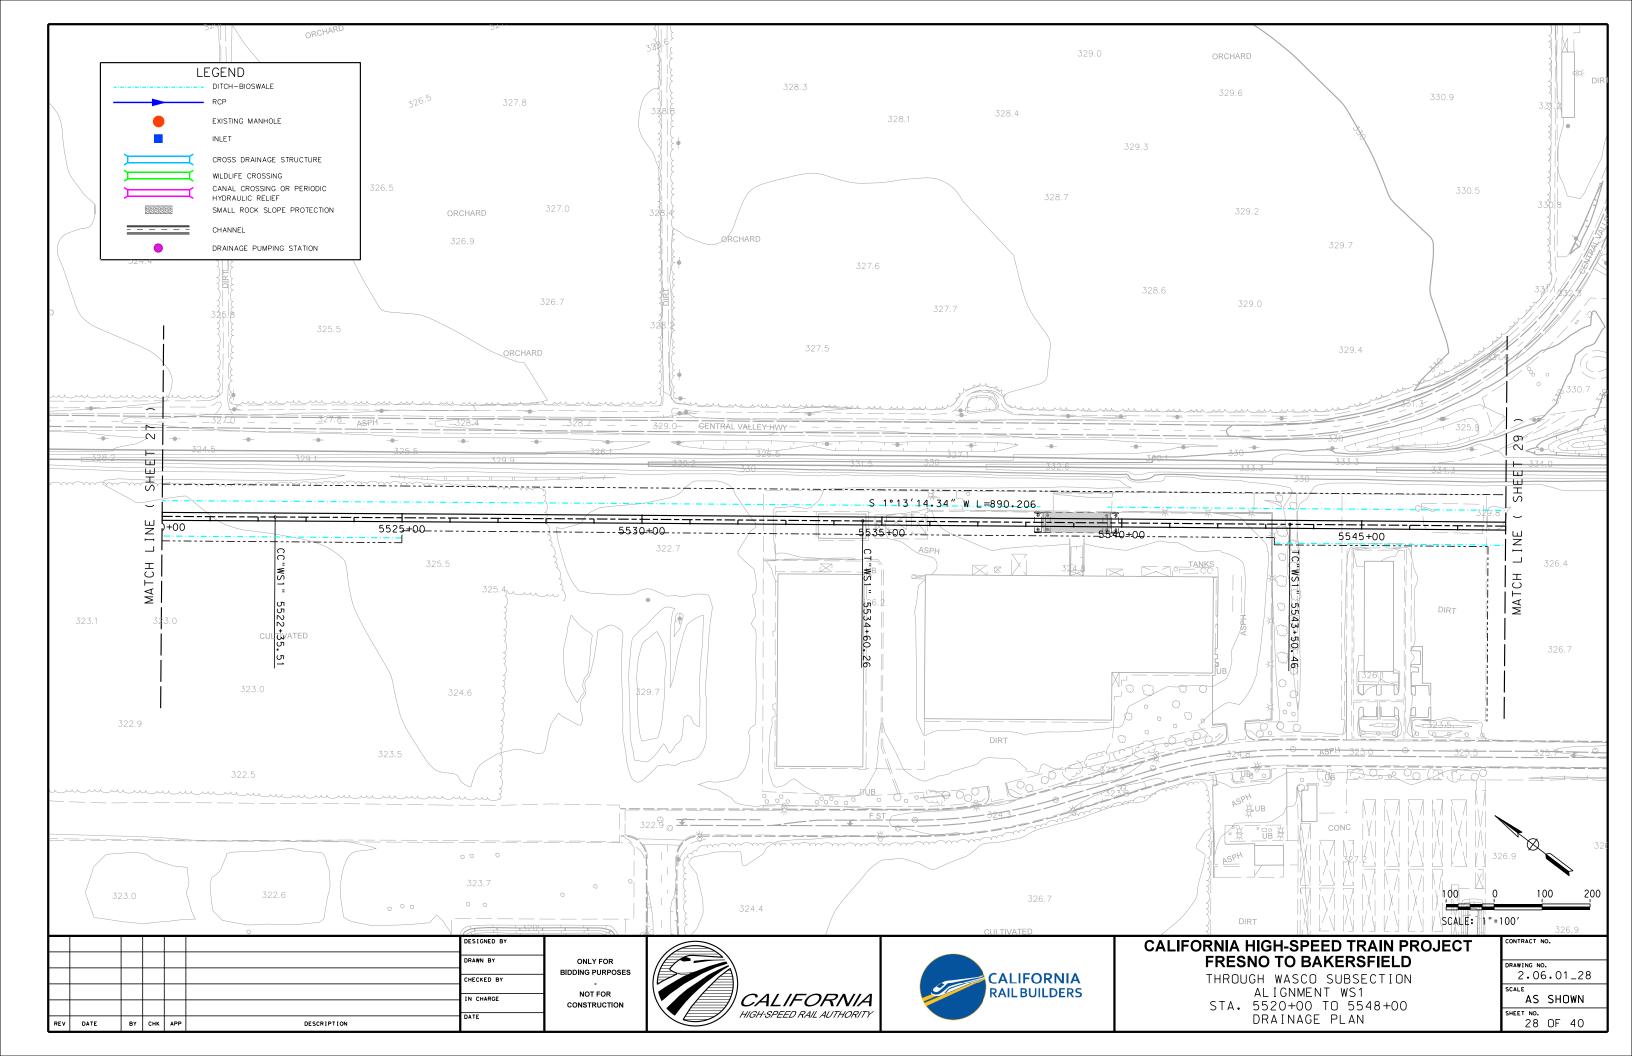


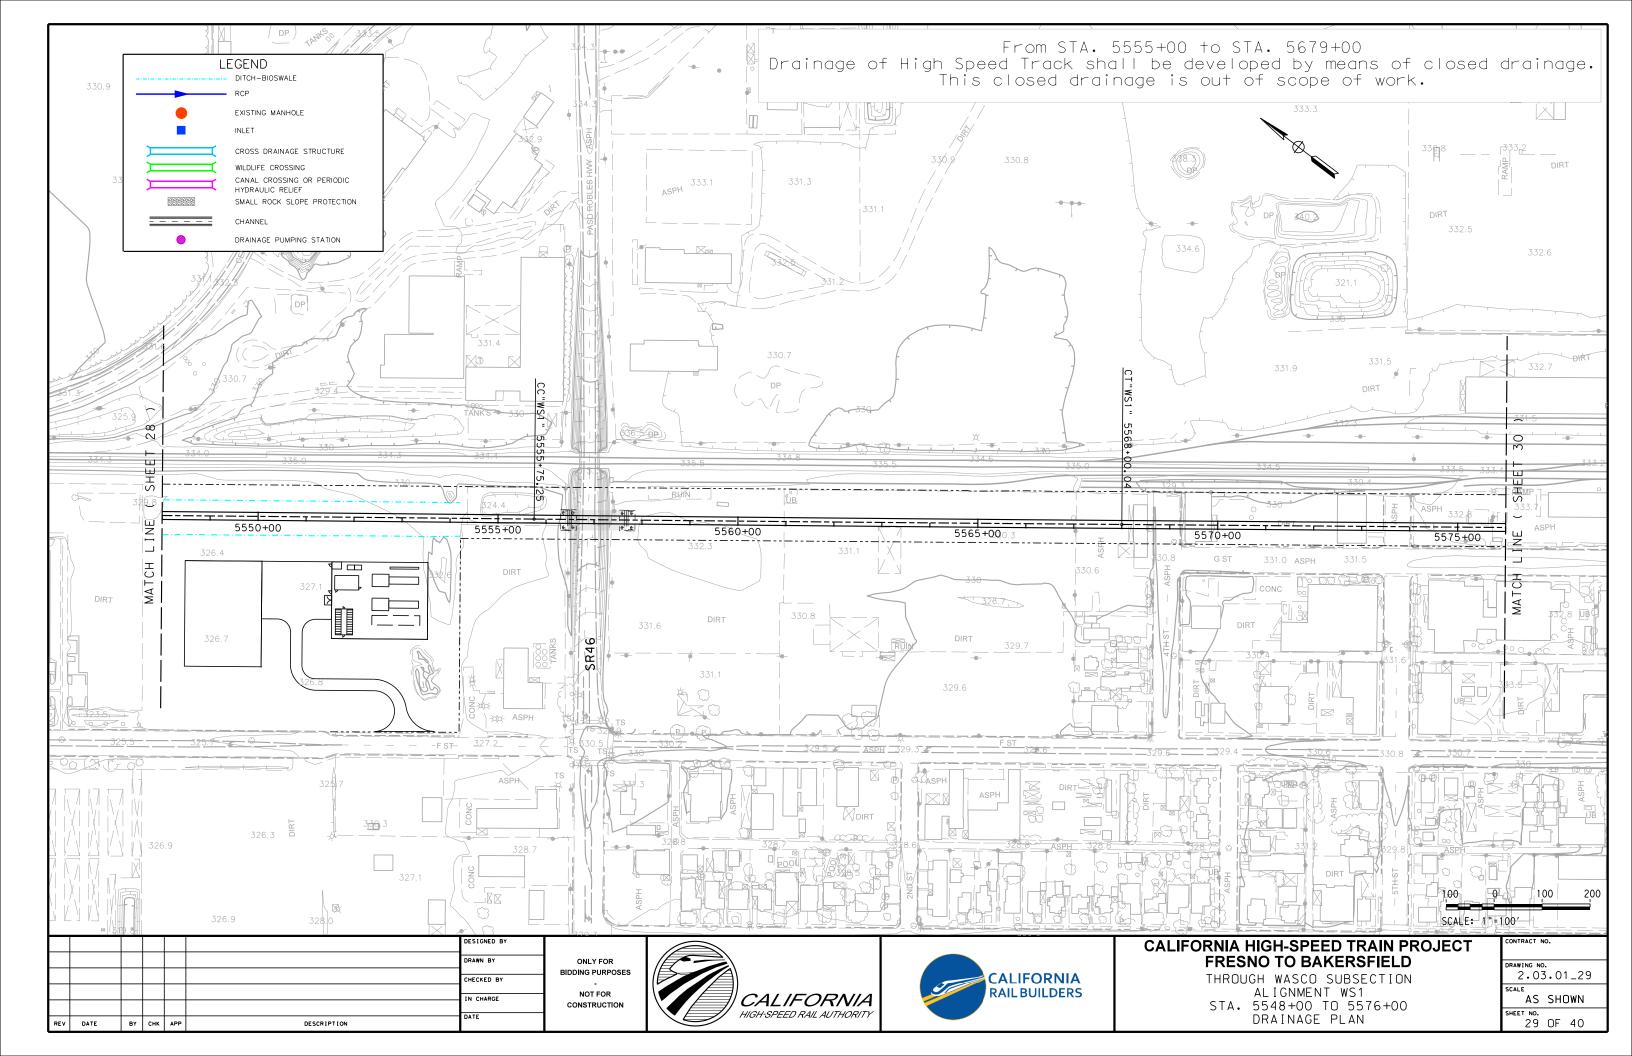


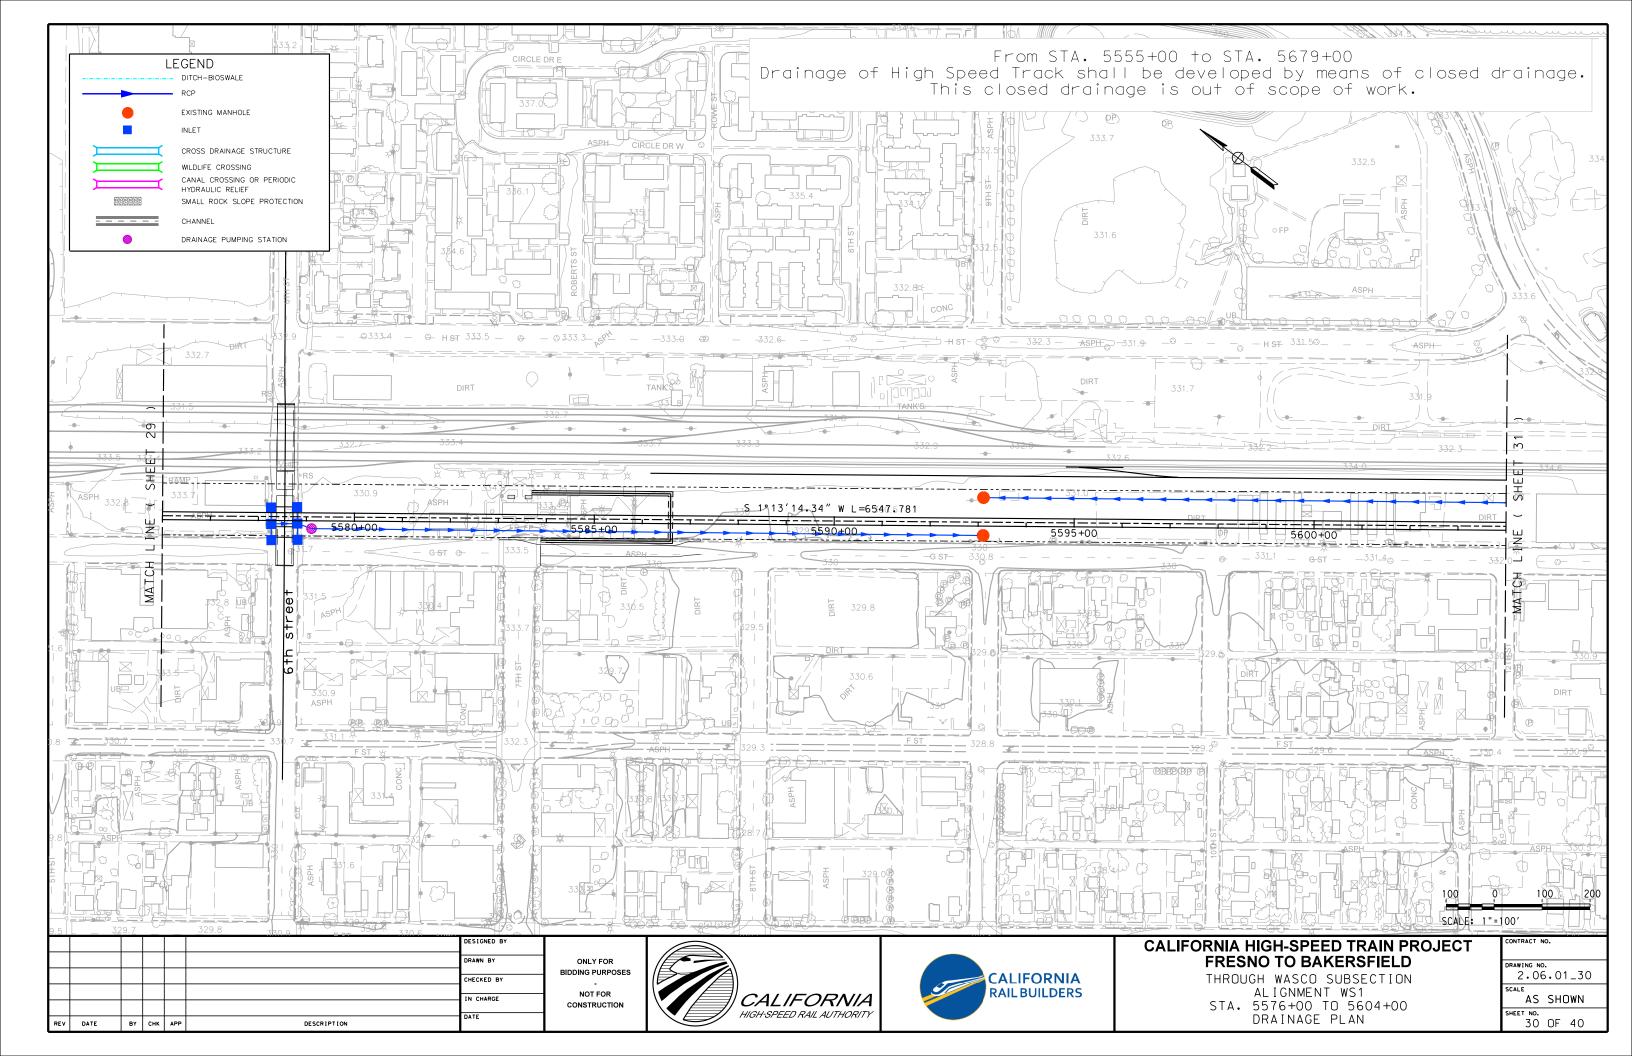


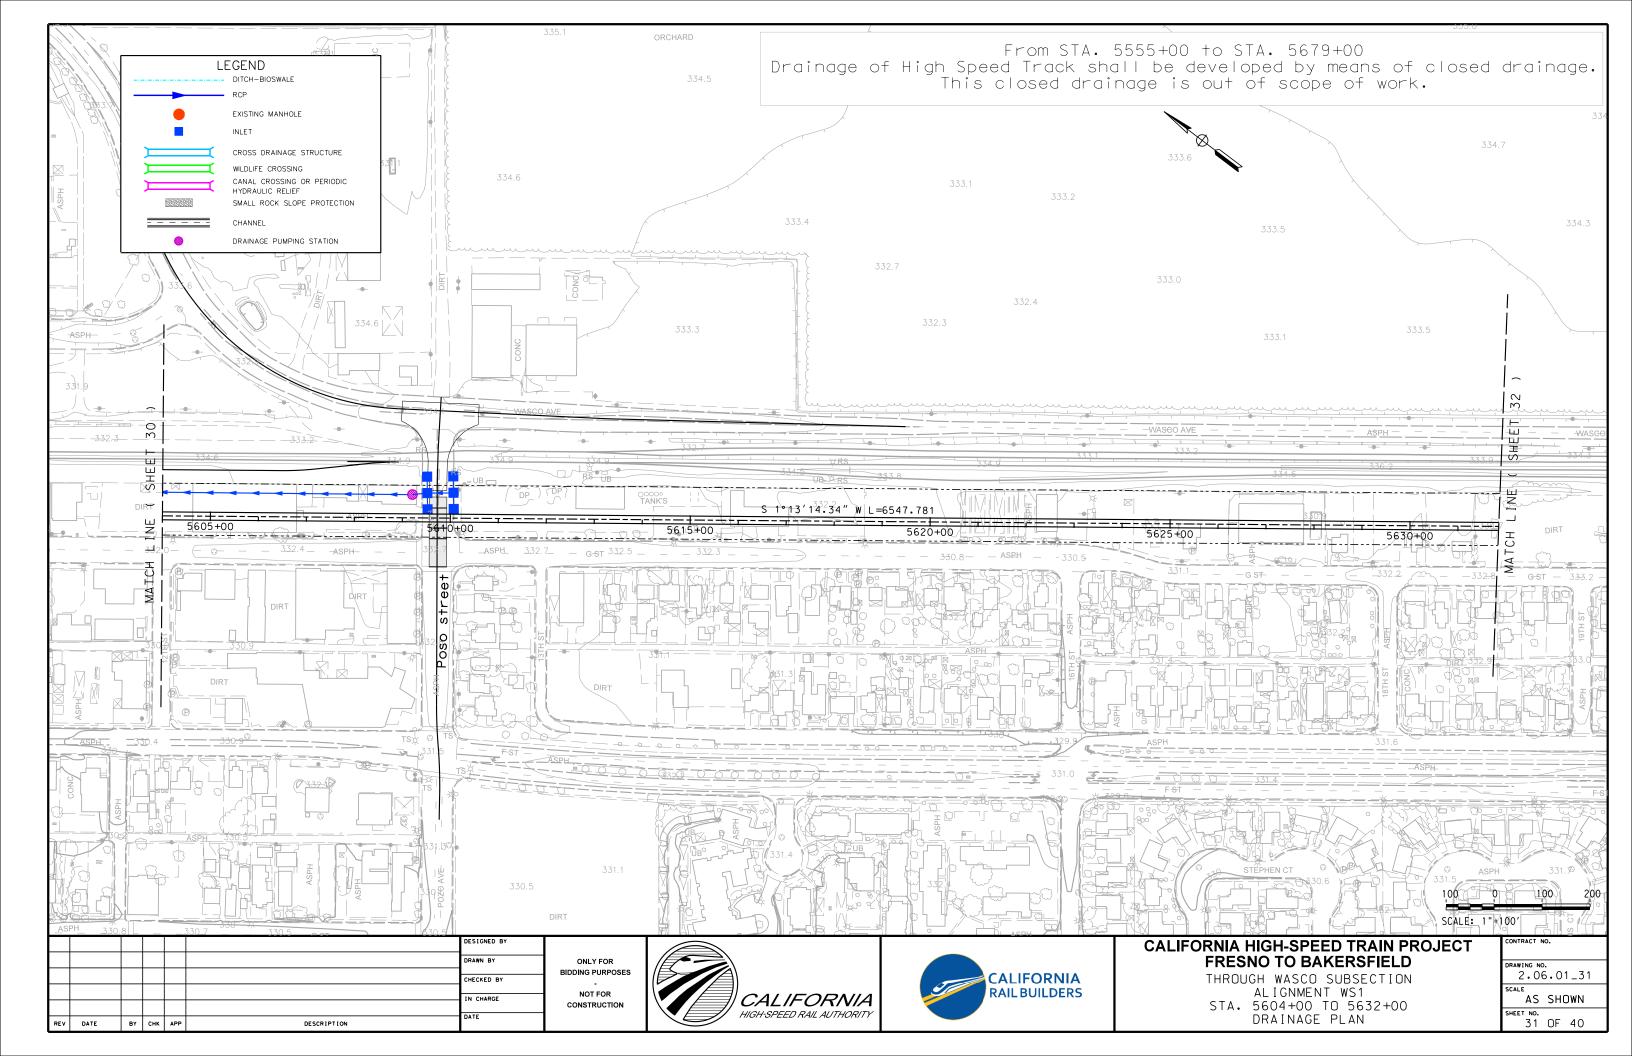


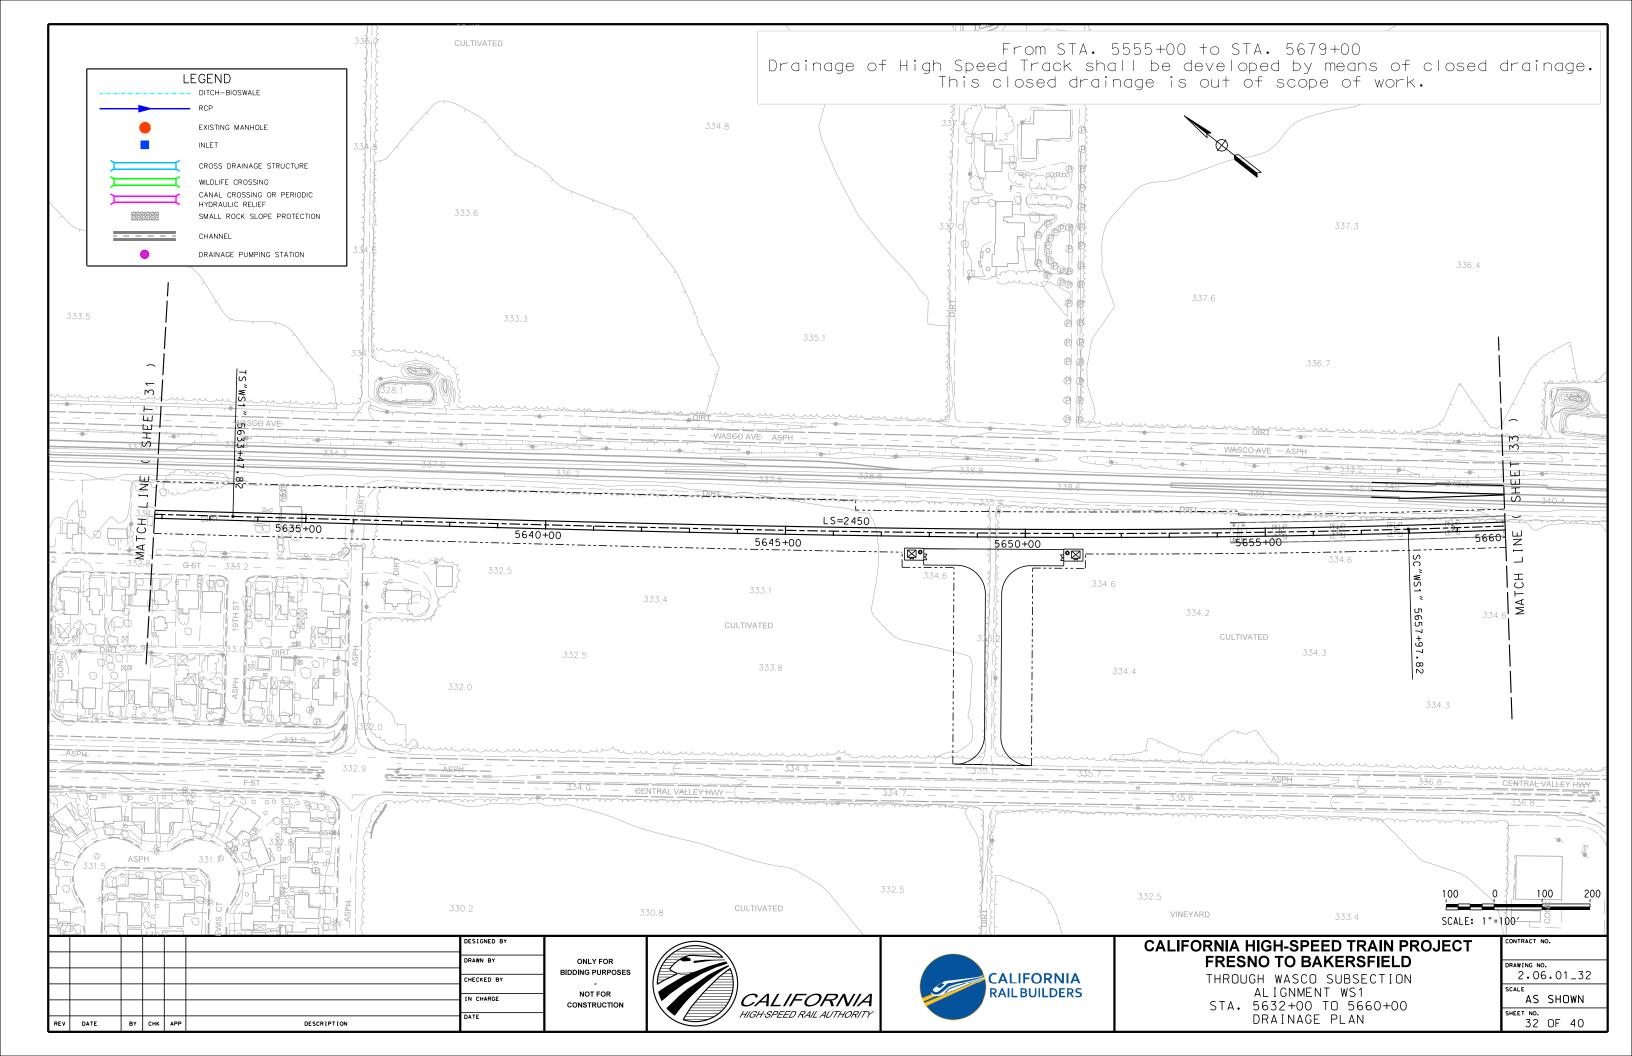


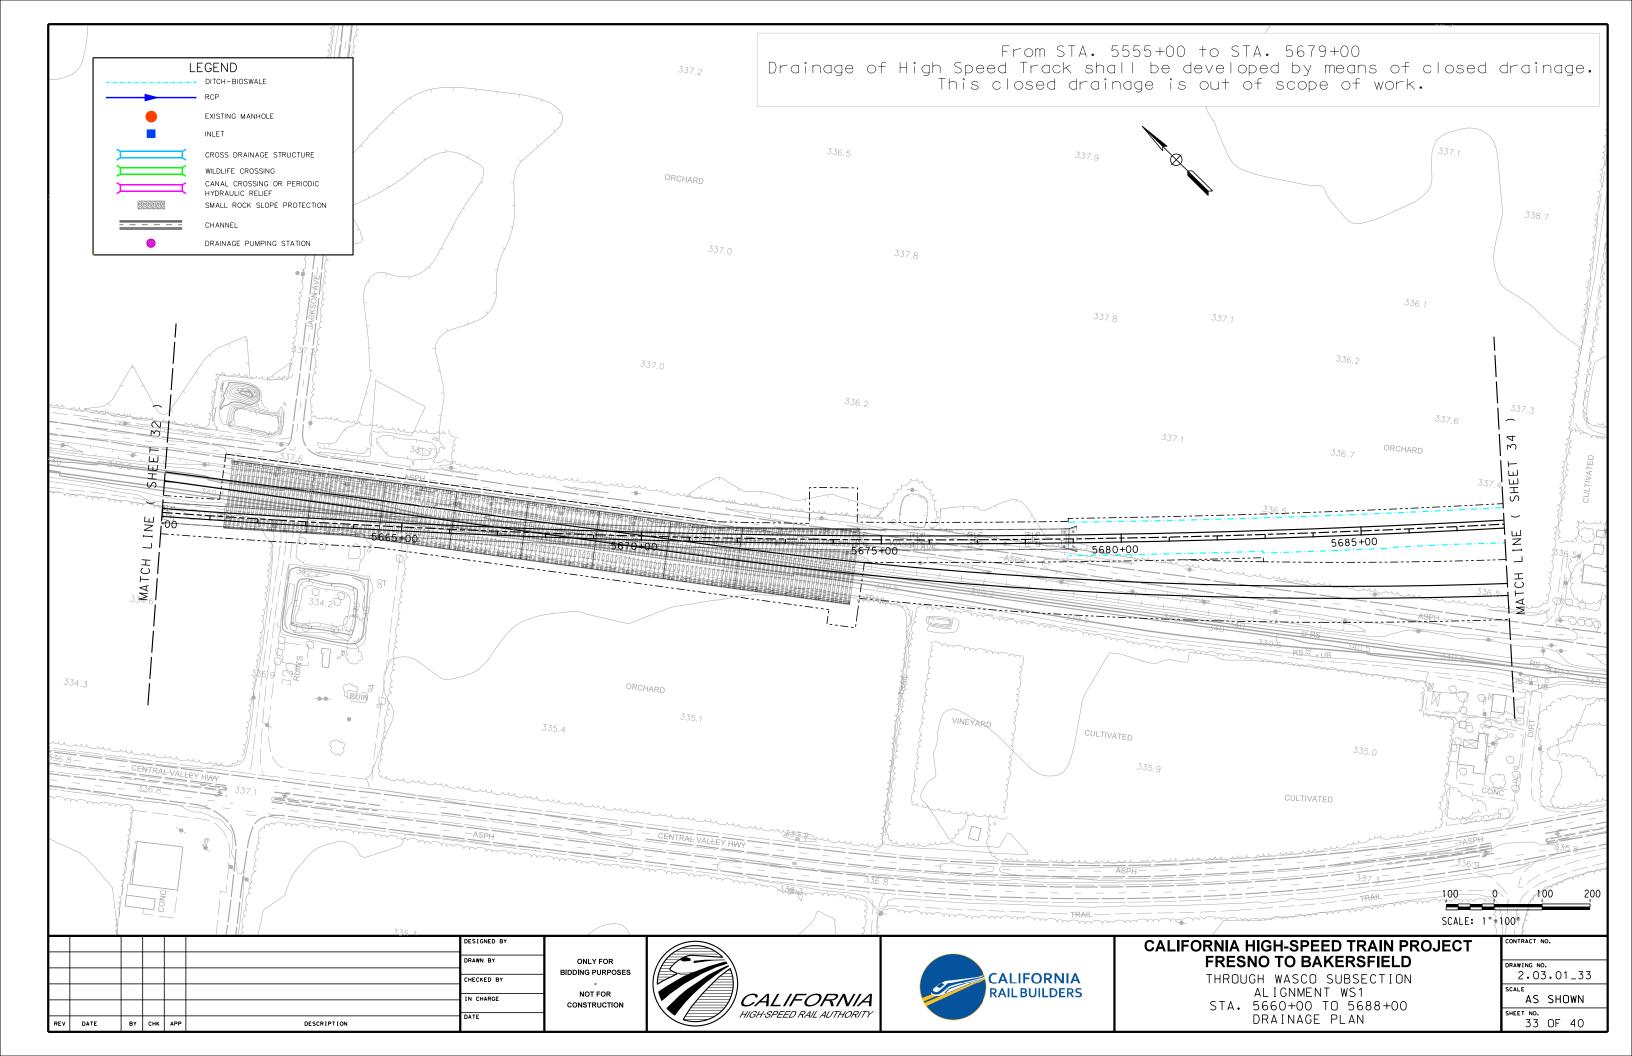


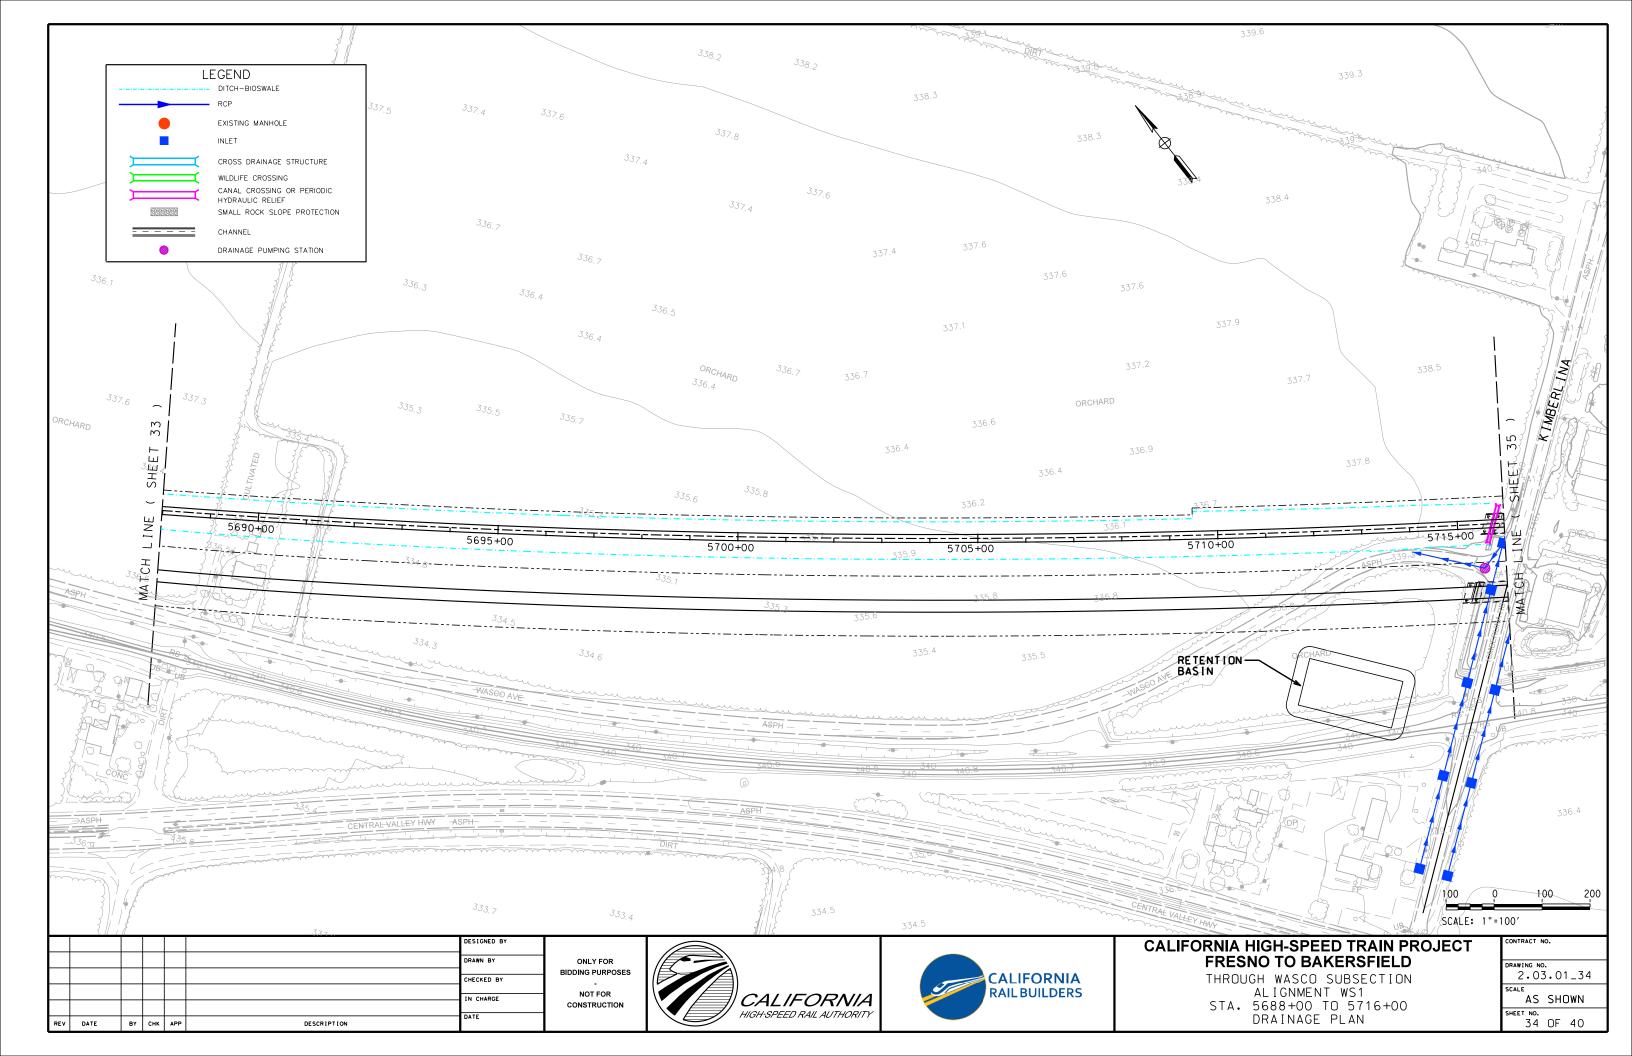


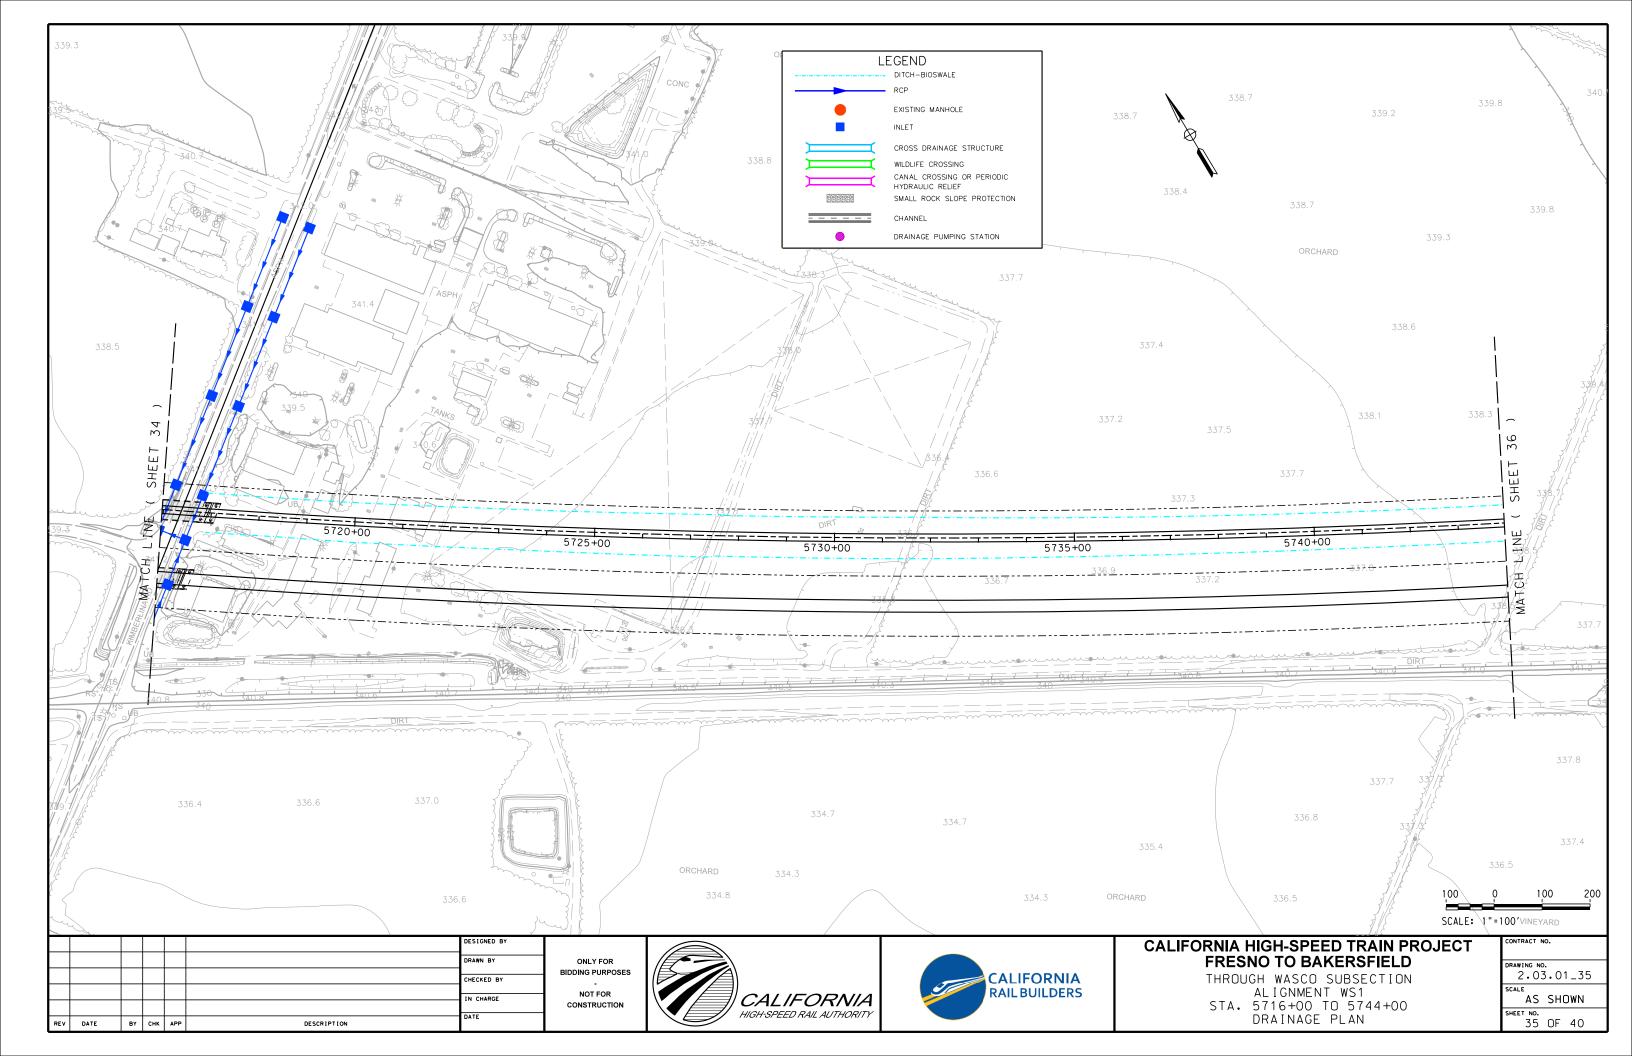


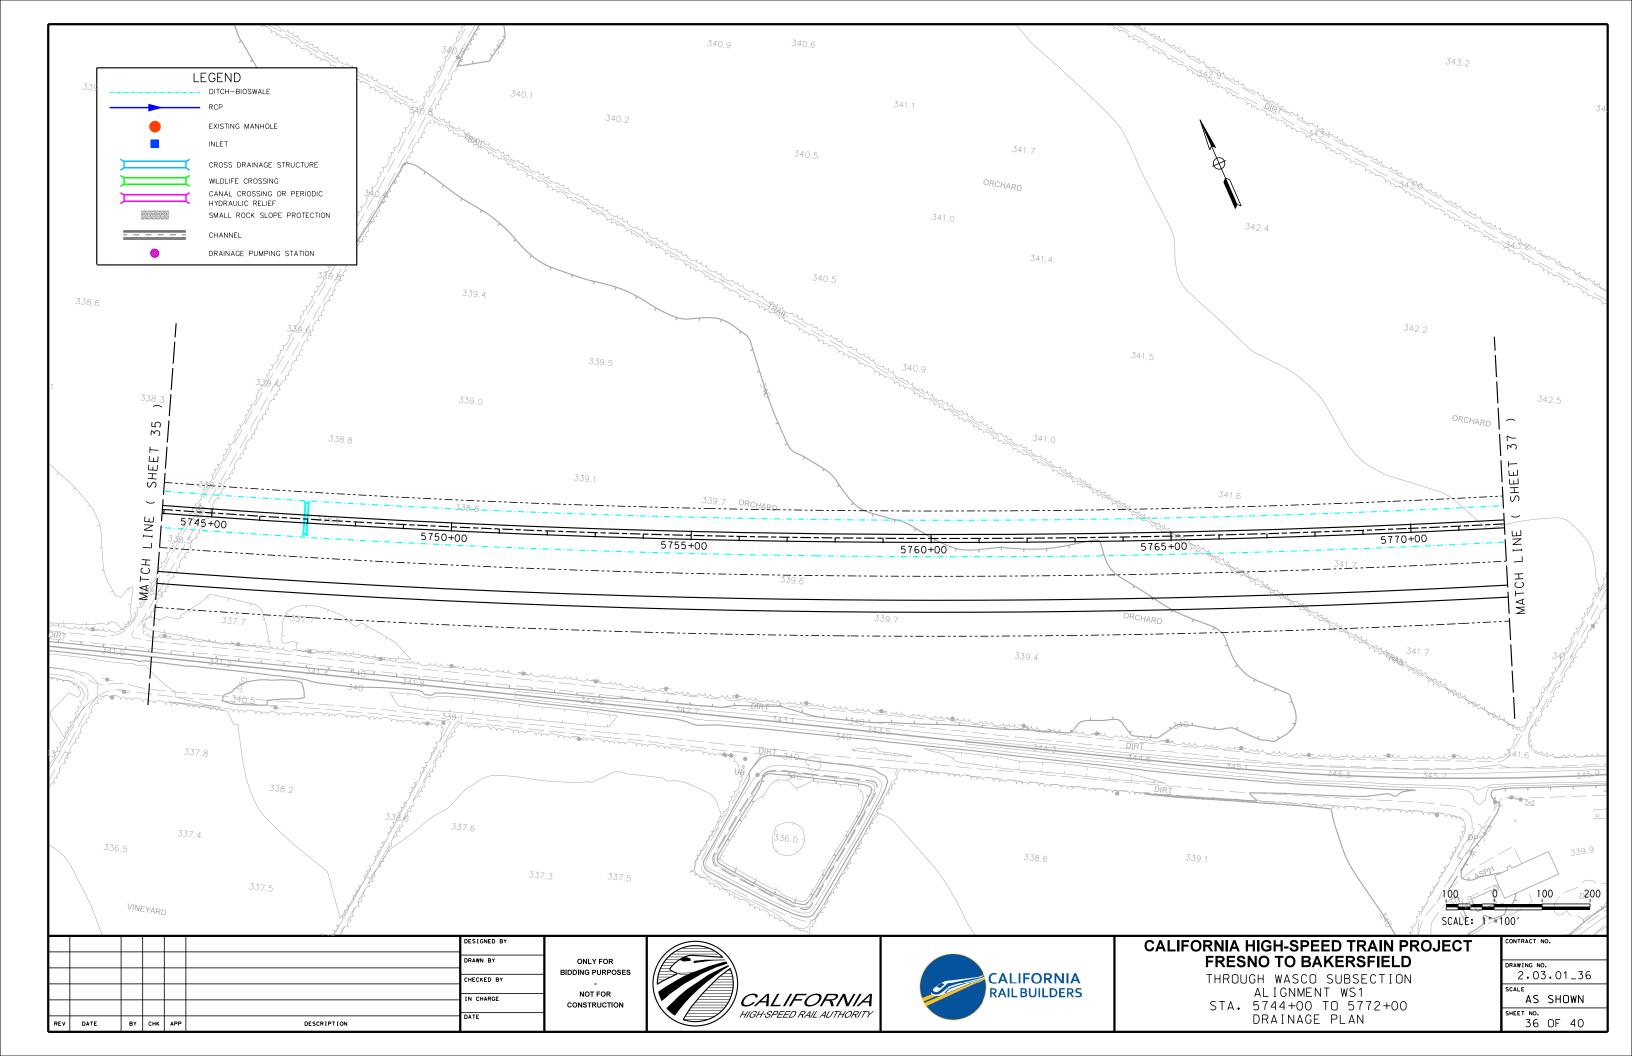

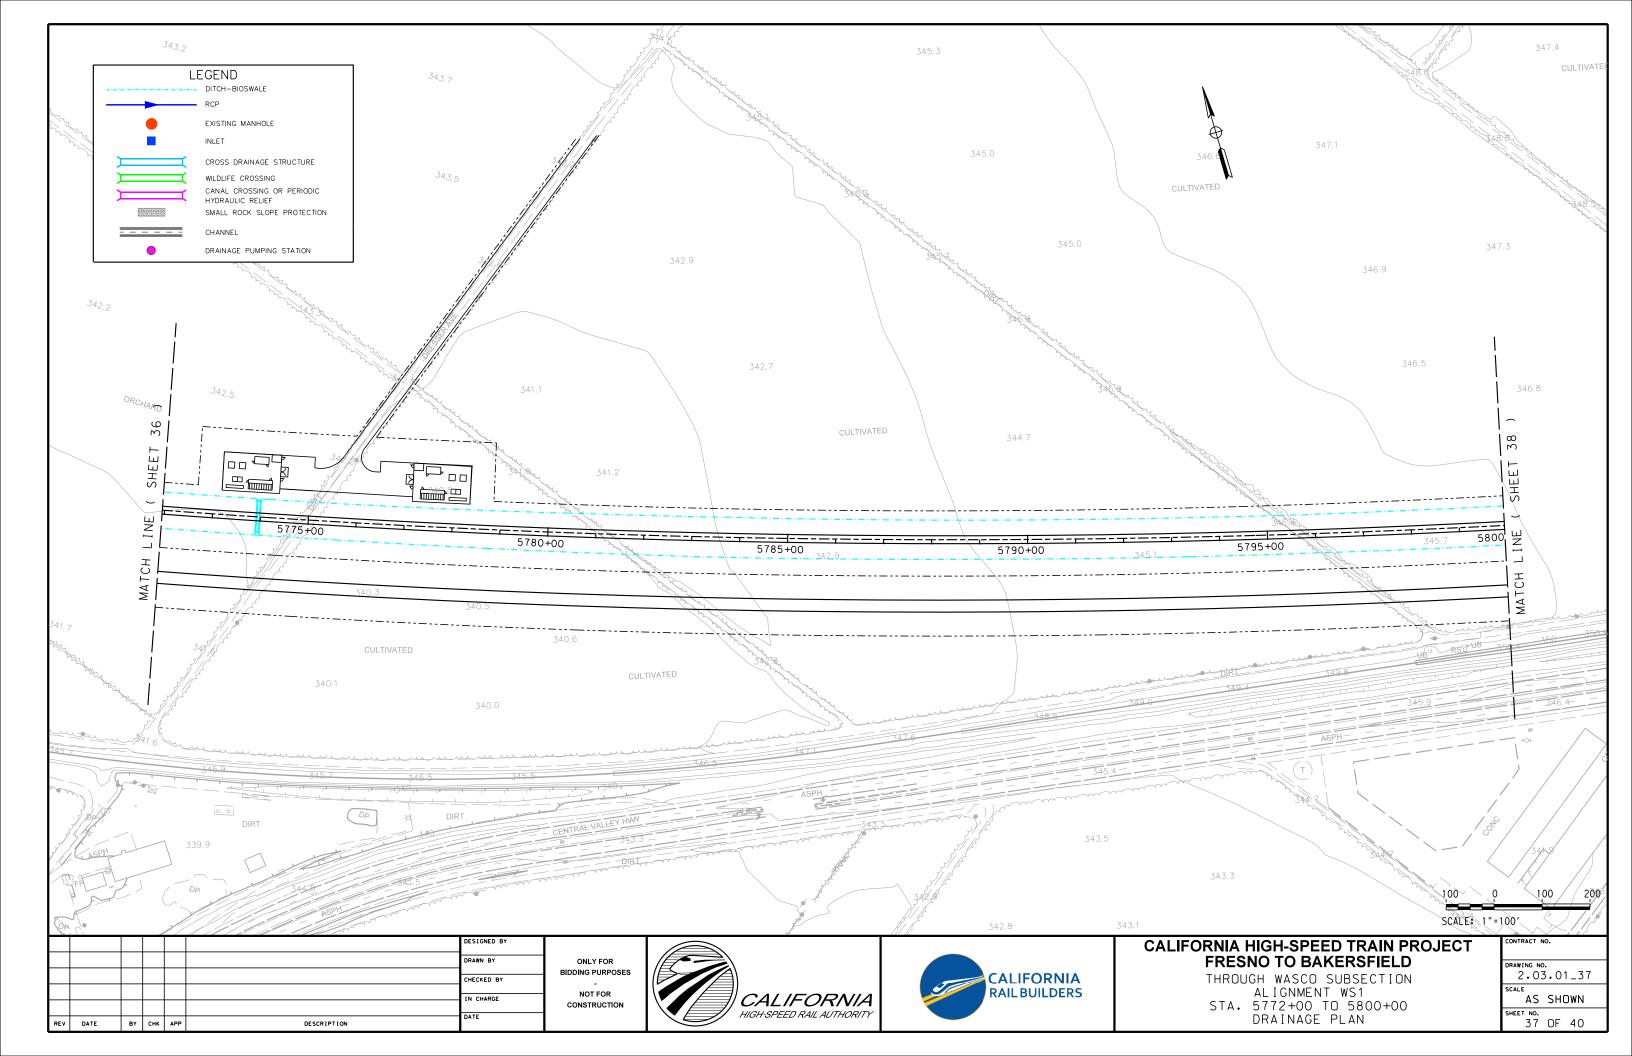

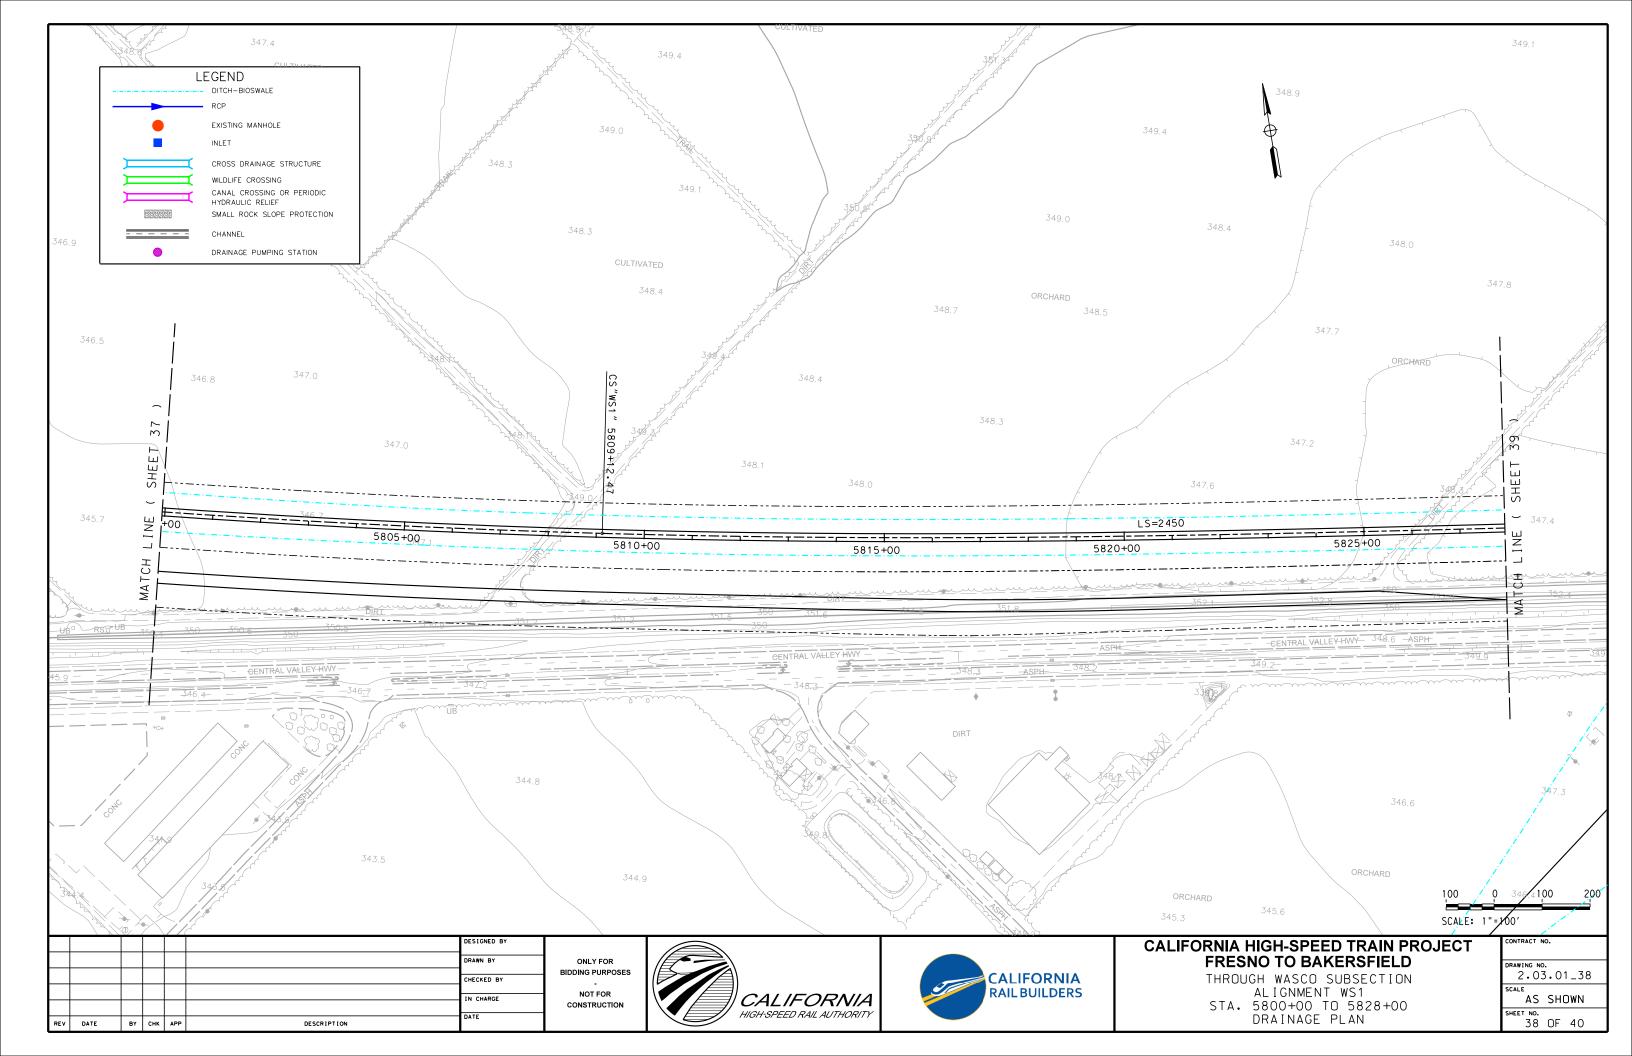

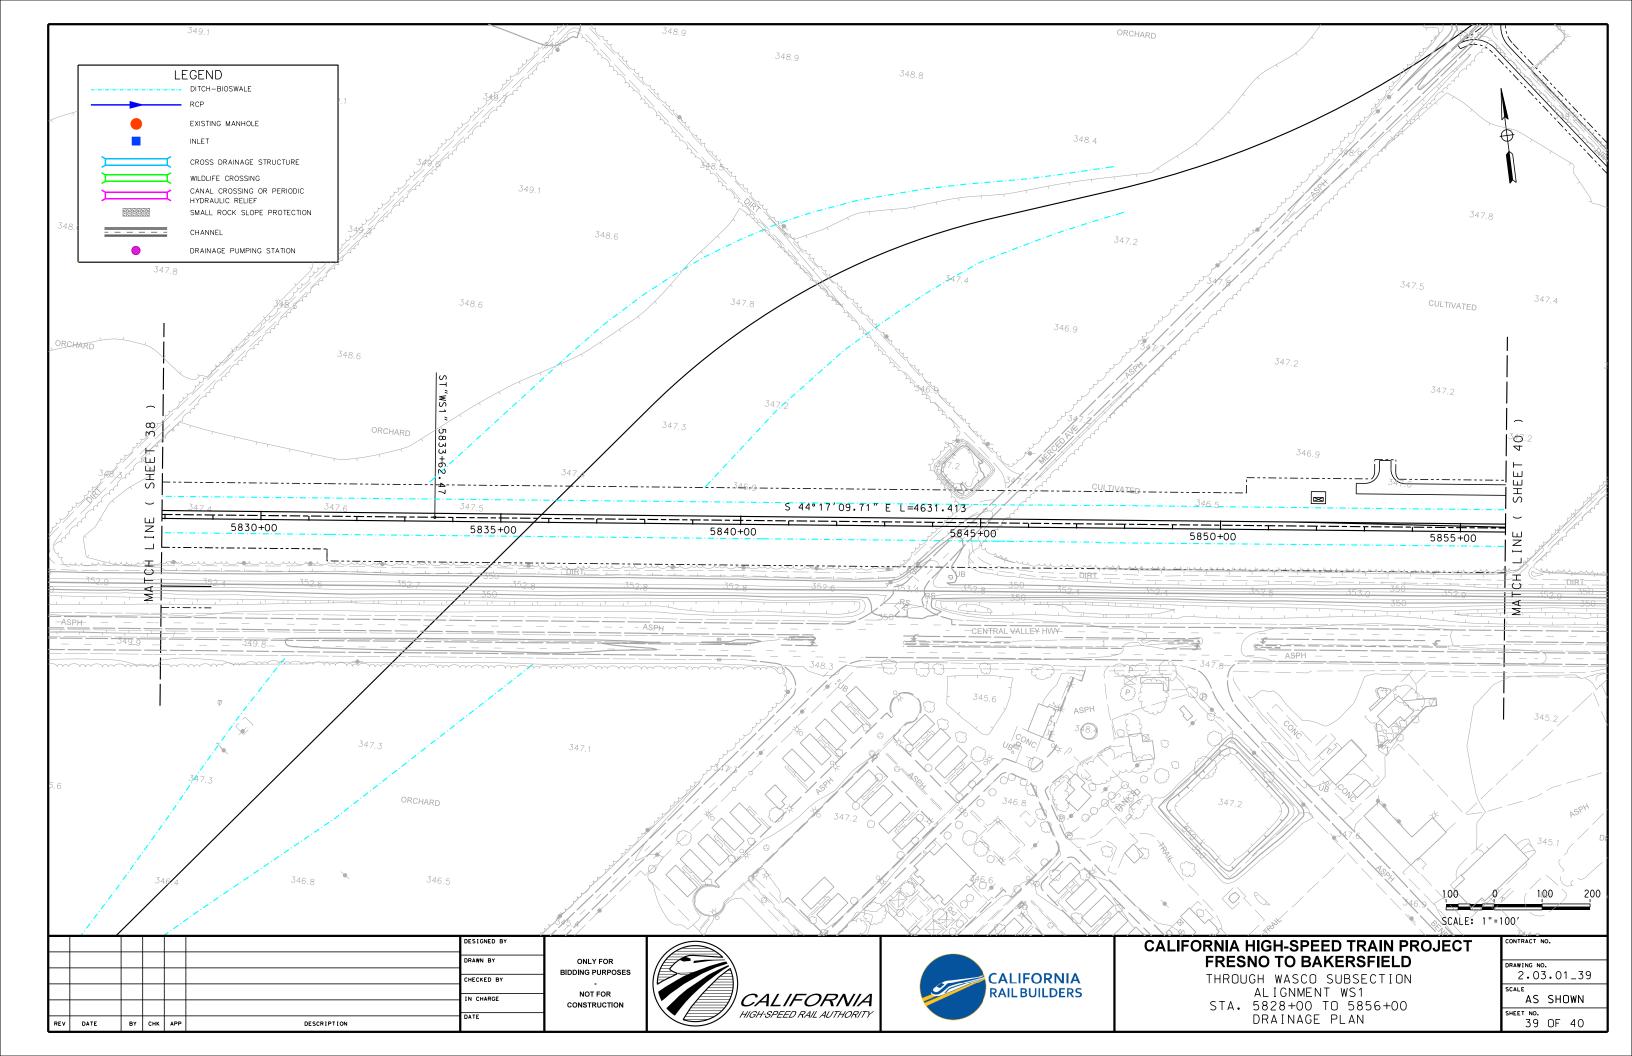

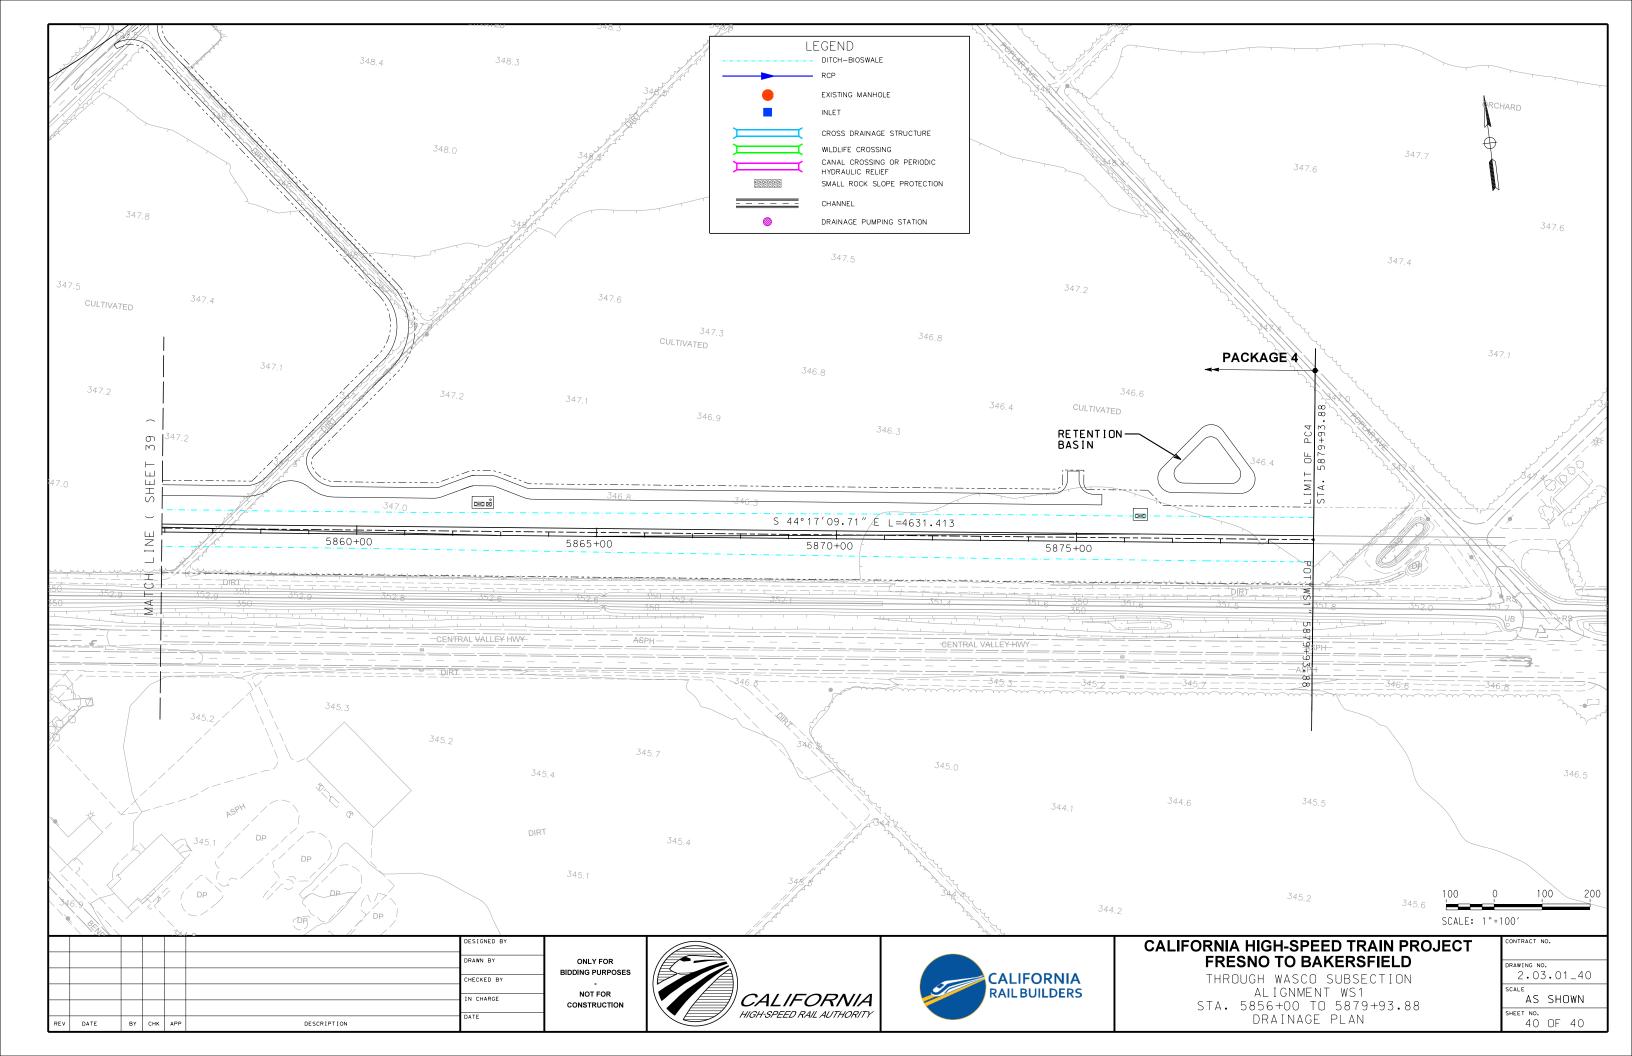

### MAINTENANCE OF TRAFFIC



### INDEX - MAINTENANCE OF TRAFFIC - MAINTENANCE OF ROAD TRAFFIC

DRAWING No.	REV No.	DRAWING DESCRIPTION	SHEET No
2.04.01_01		THROUGH WASCO SUBSECTION - ALIGNMENT WS1 - TRAFFIC CONTROL - MCCOMBS AVE - PHASE 1	1 OF 21
2.04.01_02		THROUGH WASCO SUBSECTION - ALIGNMENT WS1 - TRAFFIC CONTROL - MCCOMBS AVE - PHASE 1	2 OF 21
2.04.01_03		THROUGH WASCO SUBSECTION - ALIGNMENT WS1 - TRAFFIC CONTROL - MCCOMBS AVE - PHASE 2	3 OF 21
2.04.01_04		THROUGH WASCO SUBSECTION - ALIGNMENT WS1 - TRAFFIC CONTROL - MCCOMBS AVE - PHASE 2	4 OF 21
2.04.01_05		THROUGH WASCO SUBSECTION - ALIGNMENT WS1 - TRAFFIC CONTROL - MCCOMBS AVE - PHASE 3	5 OF 21
2.04.01_06		THROUGH WASCO SUBSECTION - ALIGNMENT WS1 - TRAFFIC CONTROL - MCCOMBS AVE - PHASE 3	6 OF 21
2.04.01_07		THROUGH WASCO SUBSECTION - ALIGNMENT WS1 - TRAFFIC CONTROL - 6TH STREET - PHASE 1	7 OF 21
2.04.01_08		THROUGH WASCO SUBSECTION - ALIGNMENT WS1 - TRAFFIC CONTROL - 6TH STREET - PHASE 2	8 OF 21
2.04.01_09		THROUGH WASCO SUBSECTION - ALIGNMENT WS1 - TRAFFIC CONTROL - 6TH STREET - PHASE 3	9 OF 21
2.04.01_10		THROUGH WASCO SUBSECTION - ALIGNMENT WS1 - TRAFFIC CONTROL - POSO AVE - PHASE 1	10 OF 21
2.04.01_11		THROUGH WASCO SUBSECTION - ALIGNMENT WS1 - TRAFFIC CONTROL - POSO AVE - PHASE 2	11 OF 21
2.04.01_12		THROUGH WASCO SUBSECTION - ALIGNMENT WS1 - TRAFFIC CONTROL - POSO AVE - PHASE 3	12 OF 21
2.04.01_13		THROUGH WASCO SUBSECTION - ALIGNMENT WS1 - TRAFFIC CONTROL - KIMBERLINA RD - PHASE 1	13 OF 21
2.04.01_14		THROUGH WASCO SUBSECTION - ALIGNMENT WS1 - TRAFFIC CONTROL - KIMBERLINA RD - PHASE 2	14 OF 21
2.04.01_15		THROUGH WASCO SUBSECTION - ALIGNMENT WS1 - TRAFFIC CONTROL - KIMBERLINA RD - PHASE 3	15 OF 21
2.04.01_16		THROUGH WASCO SUBSECTION - ALIGNMENT WS1 - TRAFFIC CONTROL - MERCED AVE - PHASE 1	16 OF 21
2.04.01_17		THROUGH WASCO SUBSECTION - ALIGNMENT WS1 - TRAFFIC CONTROL - MERCED AVE - PHASE 1	17 OF 21
2.04.01_18		THROUGH WASCO SUBSECTION - ALIGNMENT WS1 - TRAFFIC CONTROL - MERCED AVE - PHASE 2	18 OF 21
2.04.01_19		THROUGH WASCO SUBSECTION - ALIGNMENT WS1 - TRAFFIC CONTROL - MERCED AVE - PHASE 2	19 OF 21
2.04.01_20		THROUGH WASCO SUBSECTION - ALIGNMENT WS1 - TRAFFIC CONTROL - MERCED AVE - PHASE 3	20 OF 21
2.04.01_21		THROUGH WASCO SUBSECTION - ALIGNMENT WS1 - TRAFFIC CONTROL - MERCED AVE - PHASE 3	21 OF 21

- PRELIMINARY, SUBJECT TO CHANGE DURING DETAIL DESIGN.

						DESIGNED BY
						DRAWN BY
						CHECKED BY
						IN CHARGE
REV	DATE	ВΥ	СНК	APP	DESCRIPTION	DATE

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CONSTRUCTION






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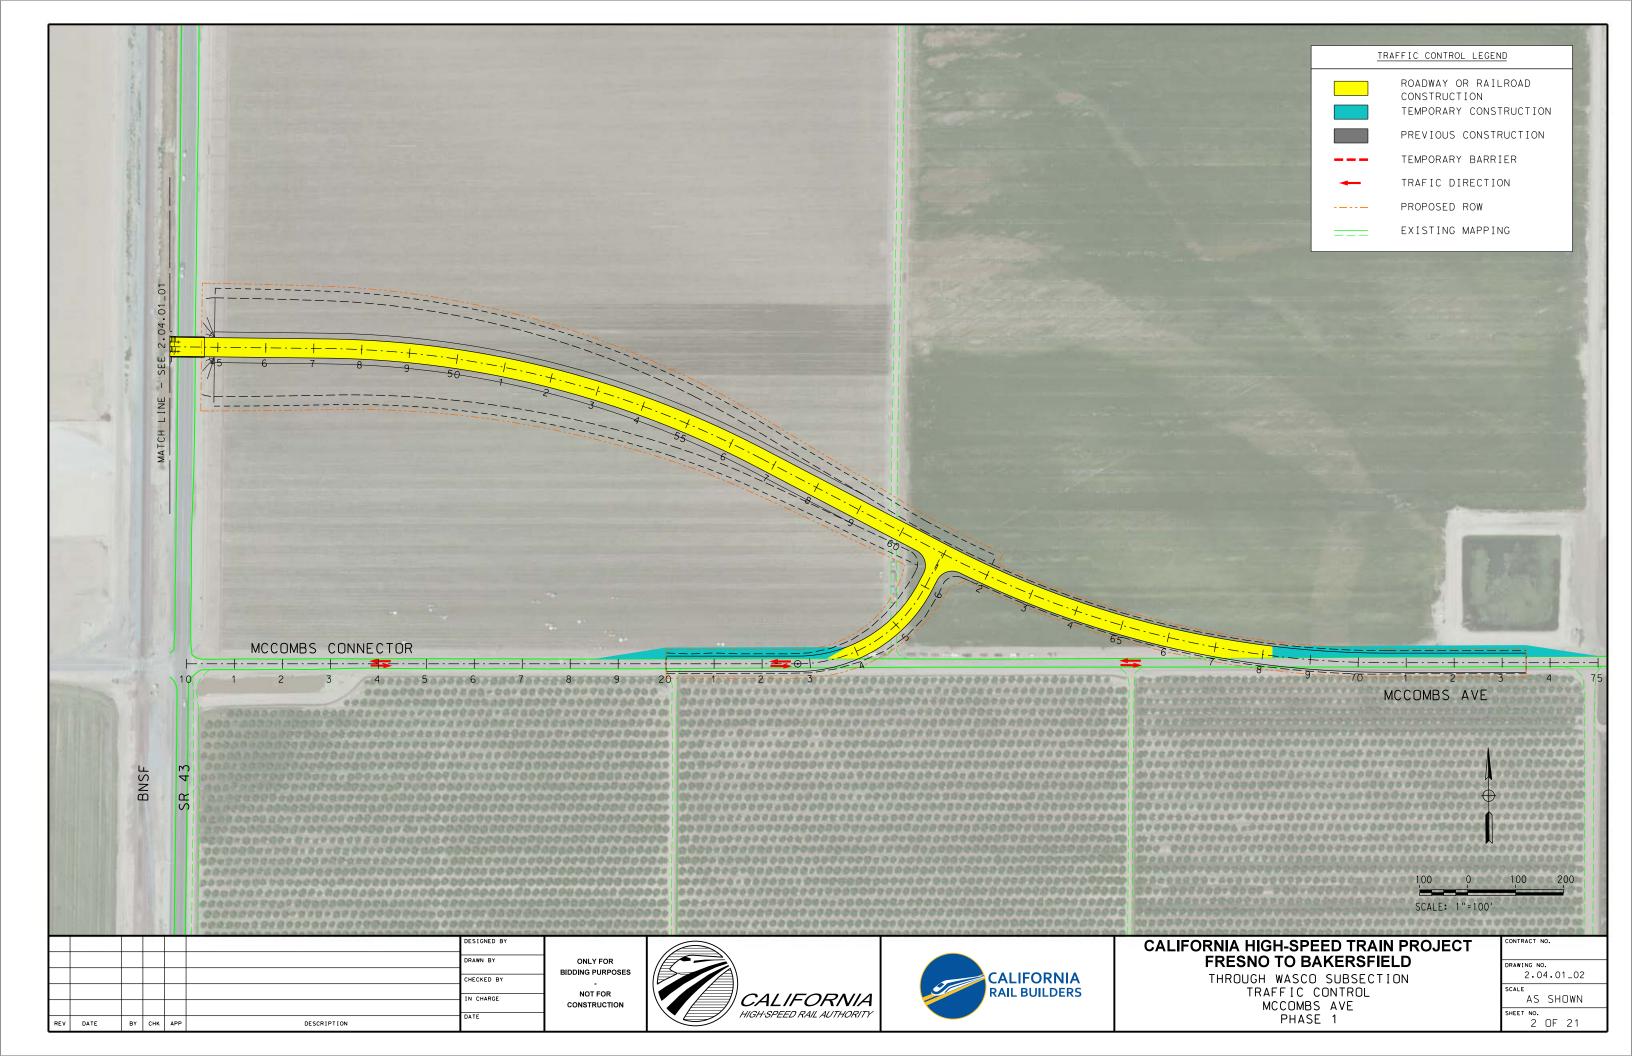
INDEX OF DRAWINGS MAINTENANCE OF TRAFFIC


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DRAWING NO.
2.04
SCALE
NO SCALE
SHEET NO.
1 OF 1


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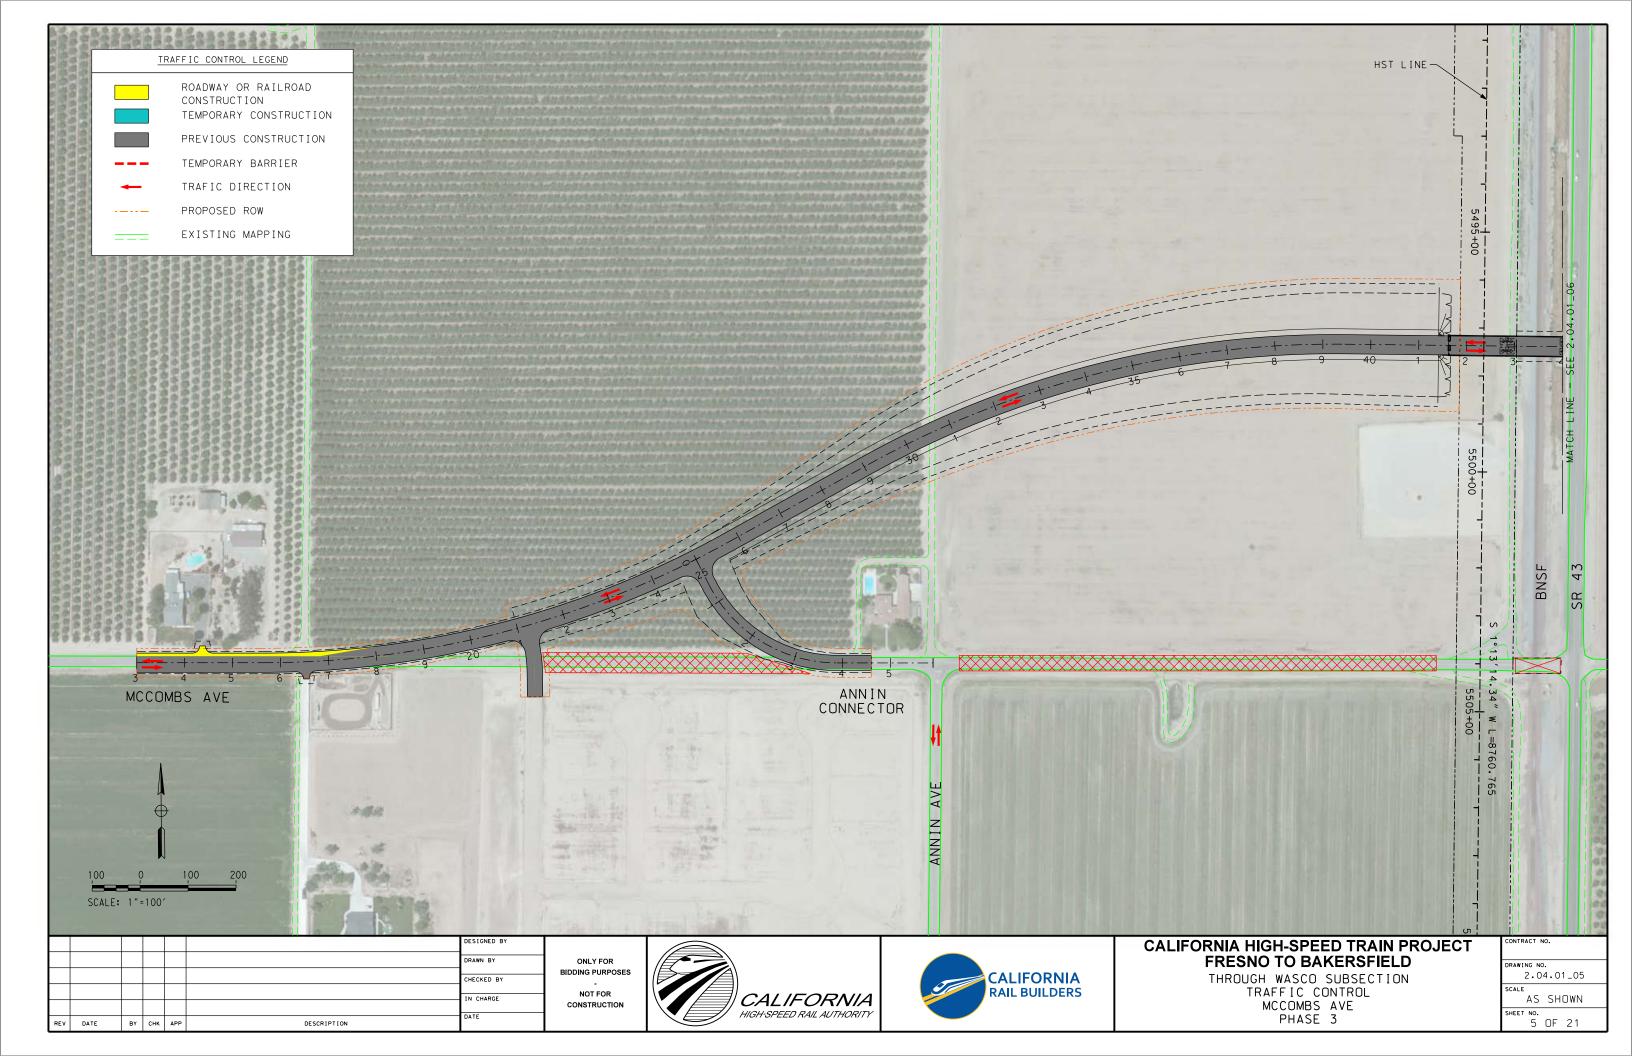








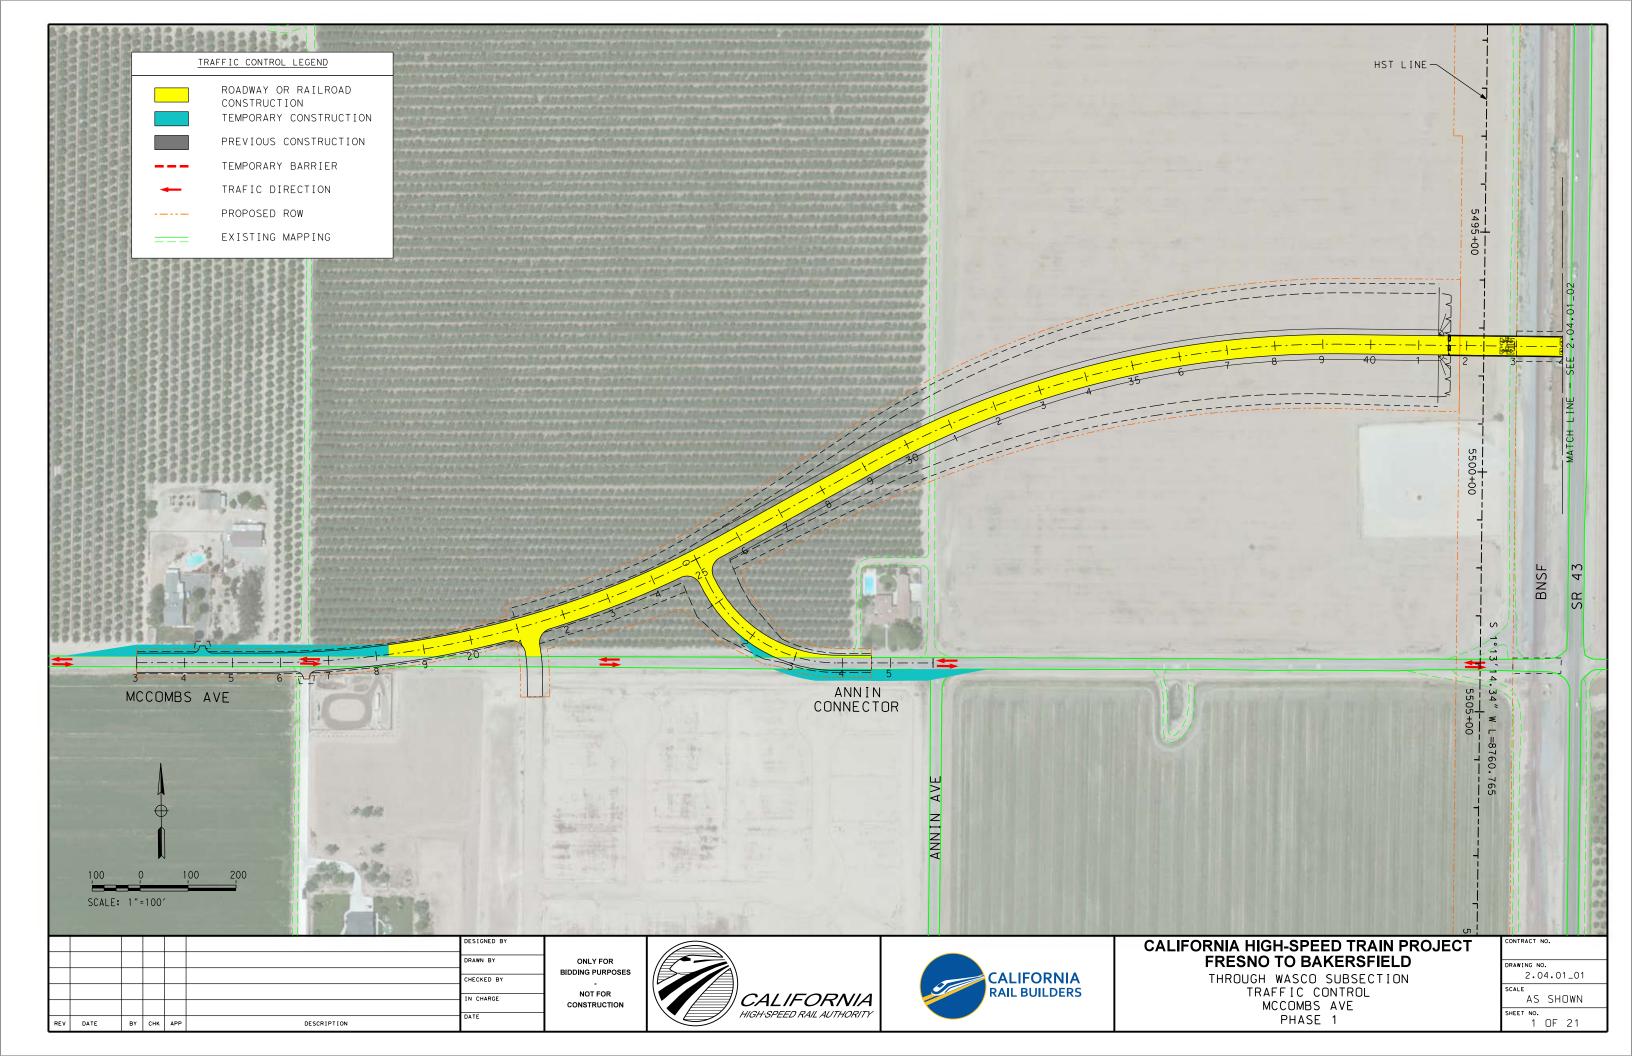


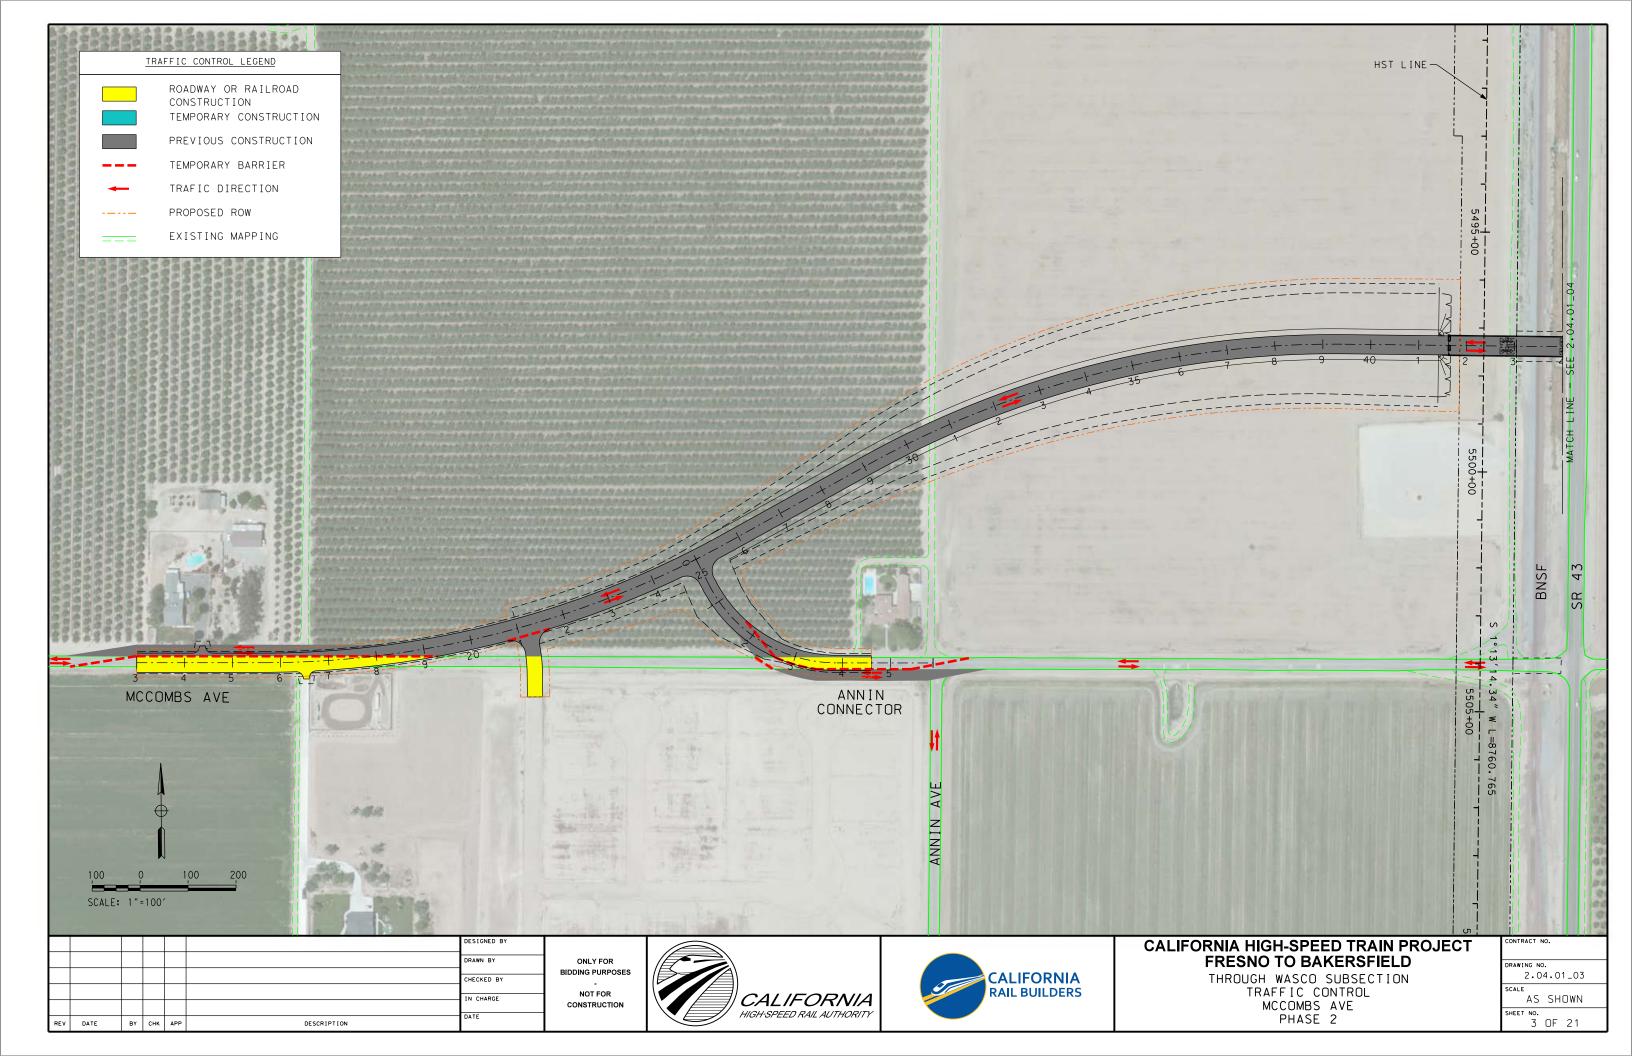


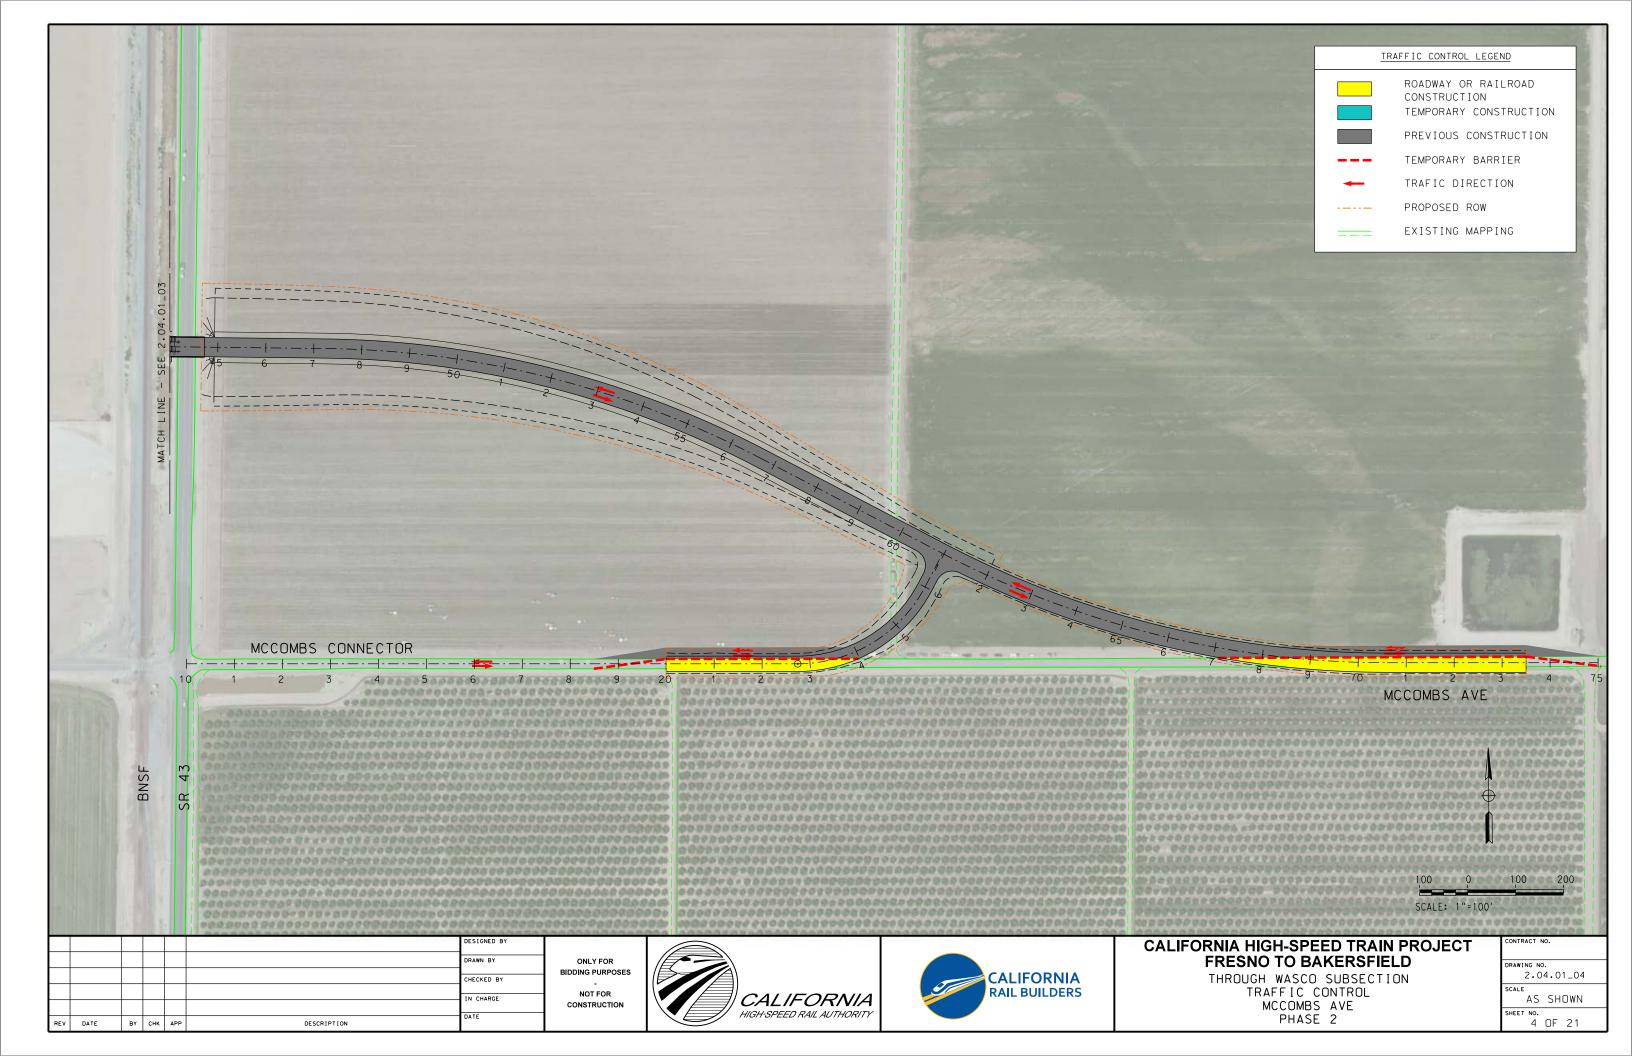


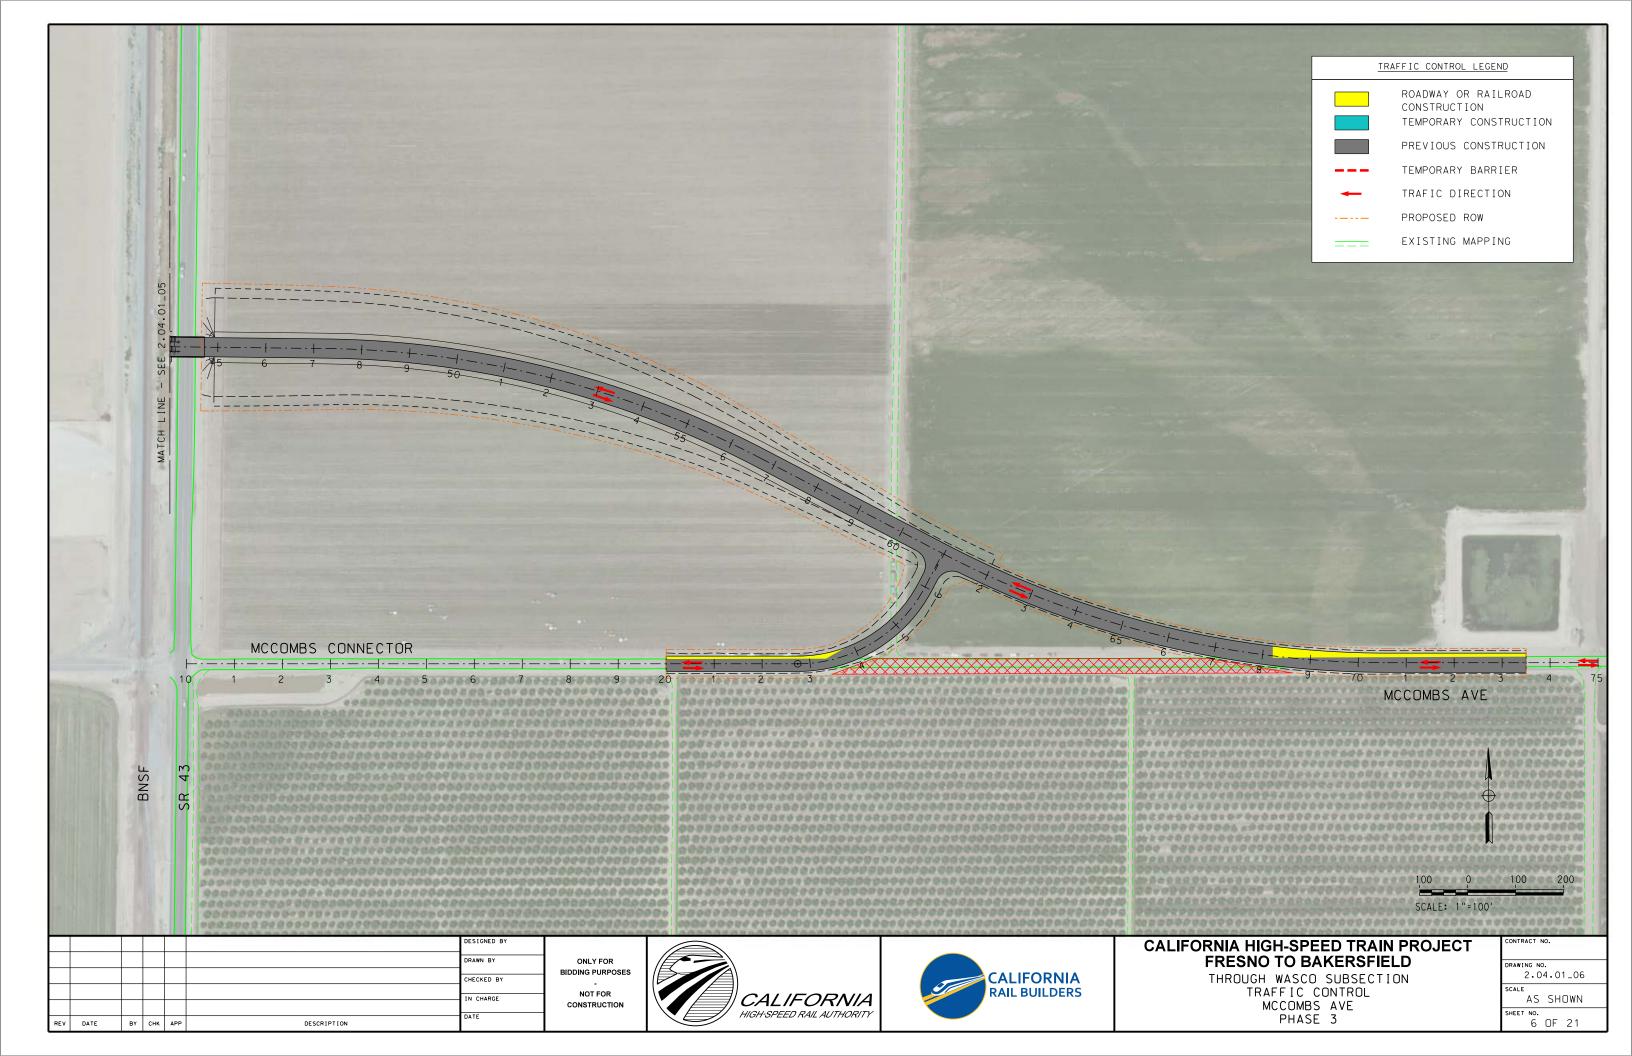


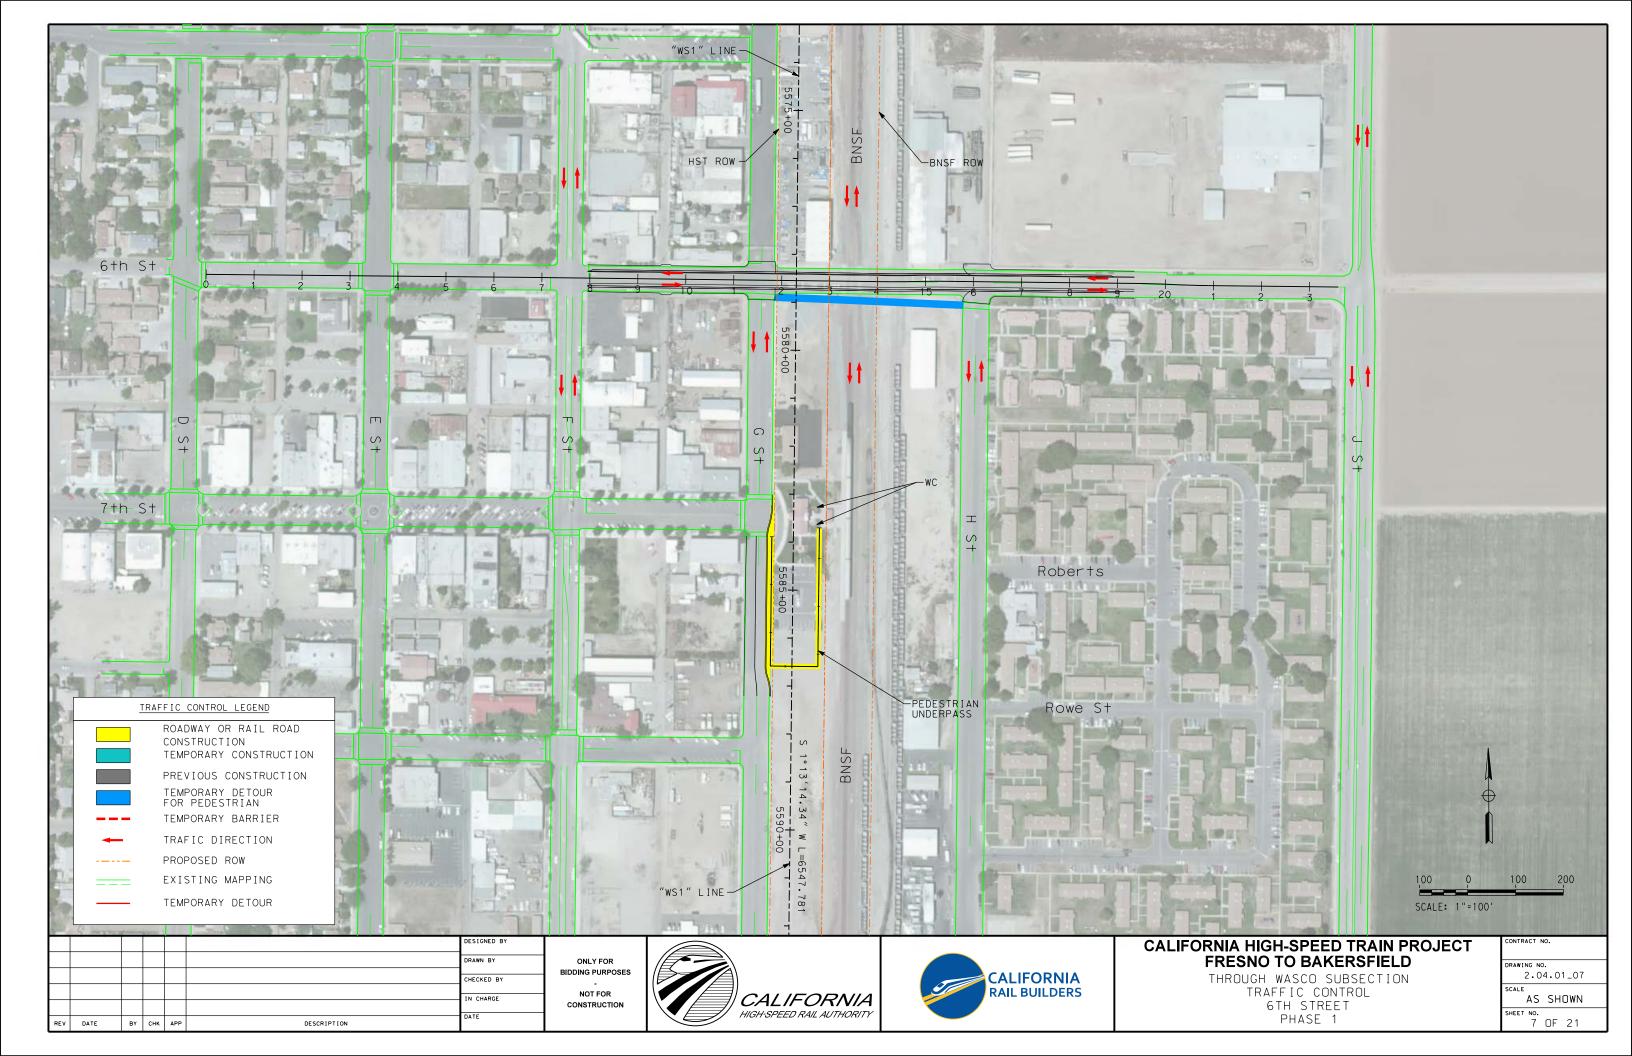


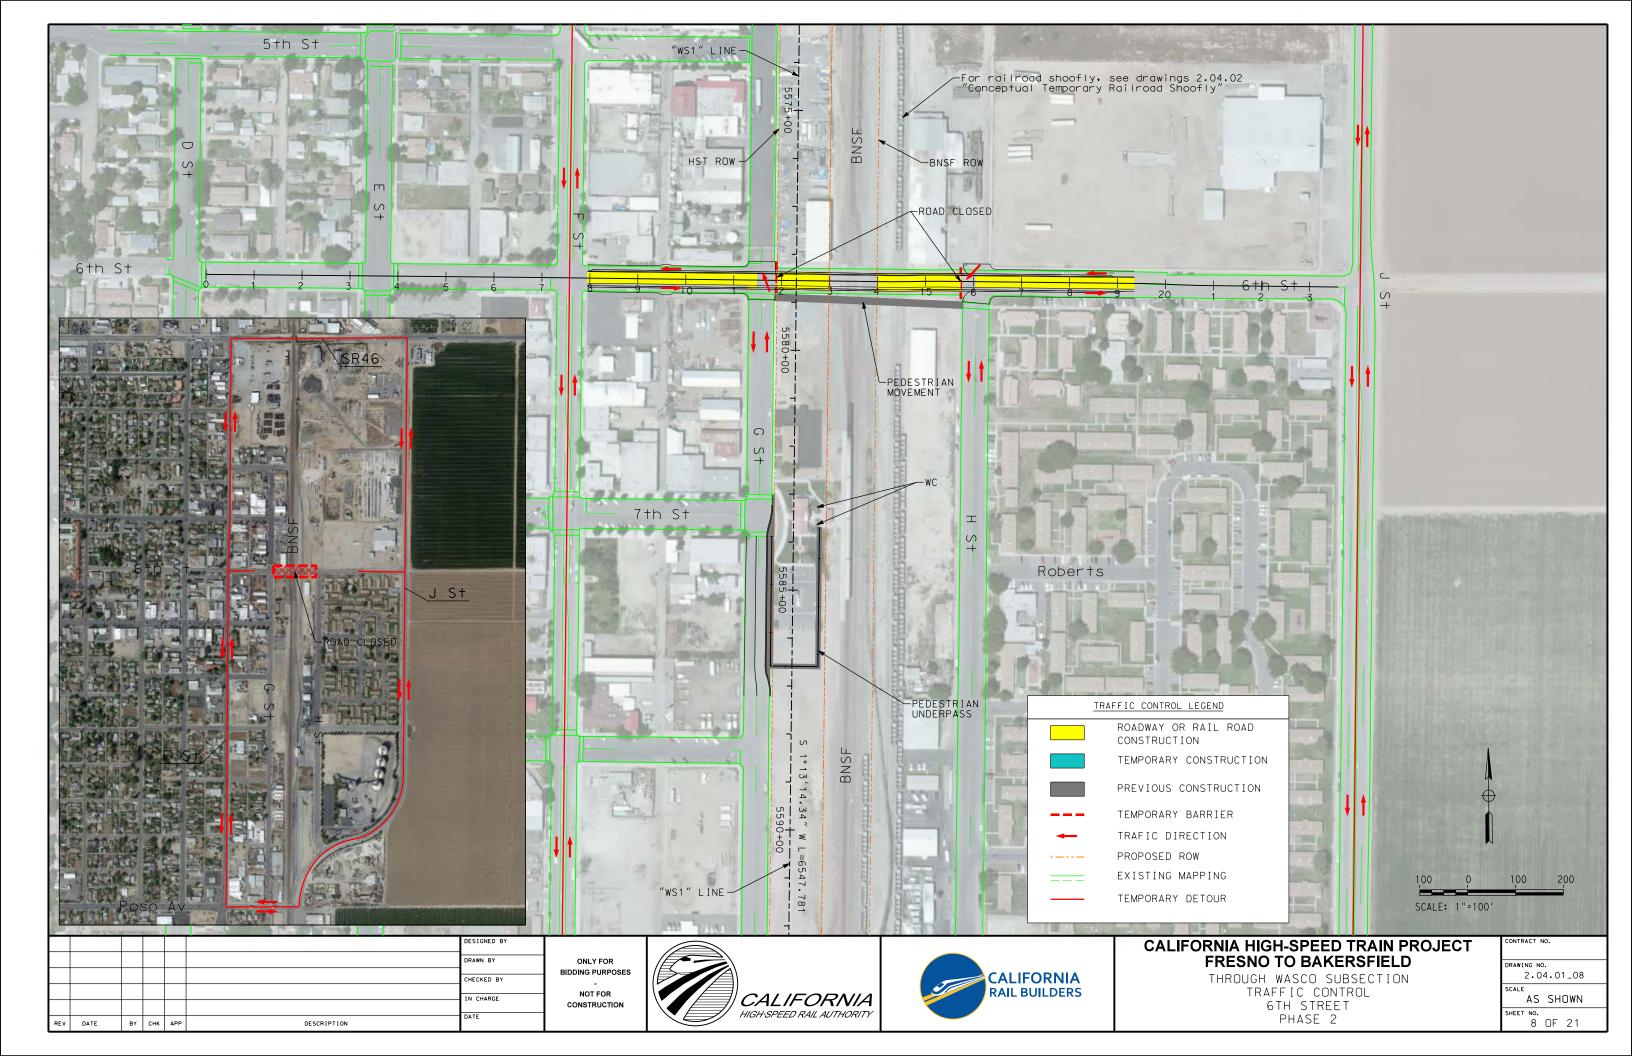


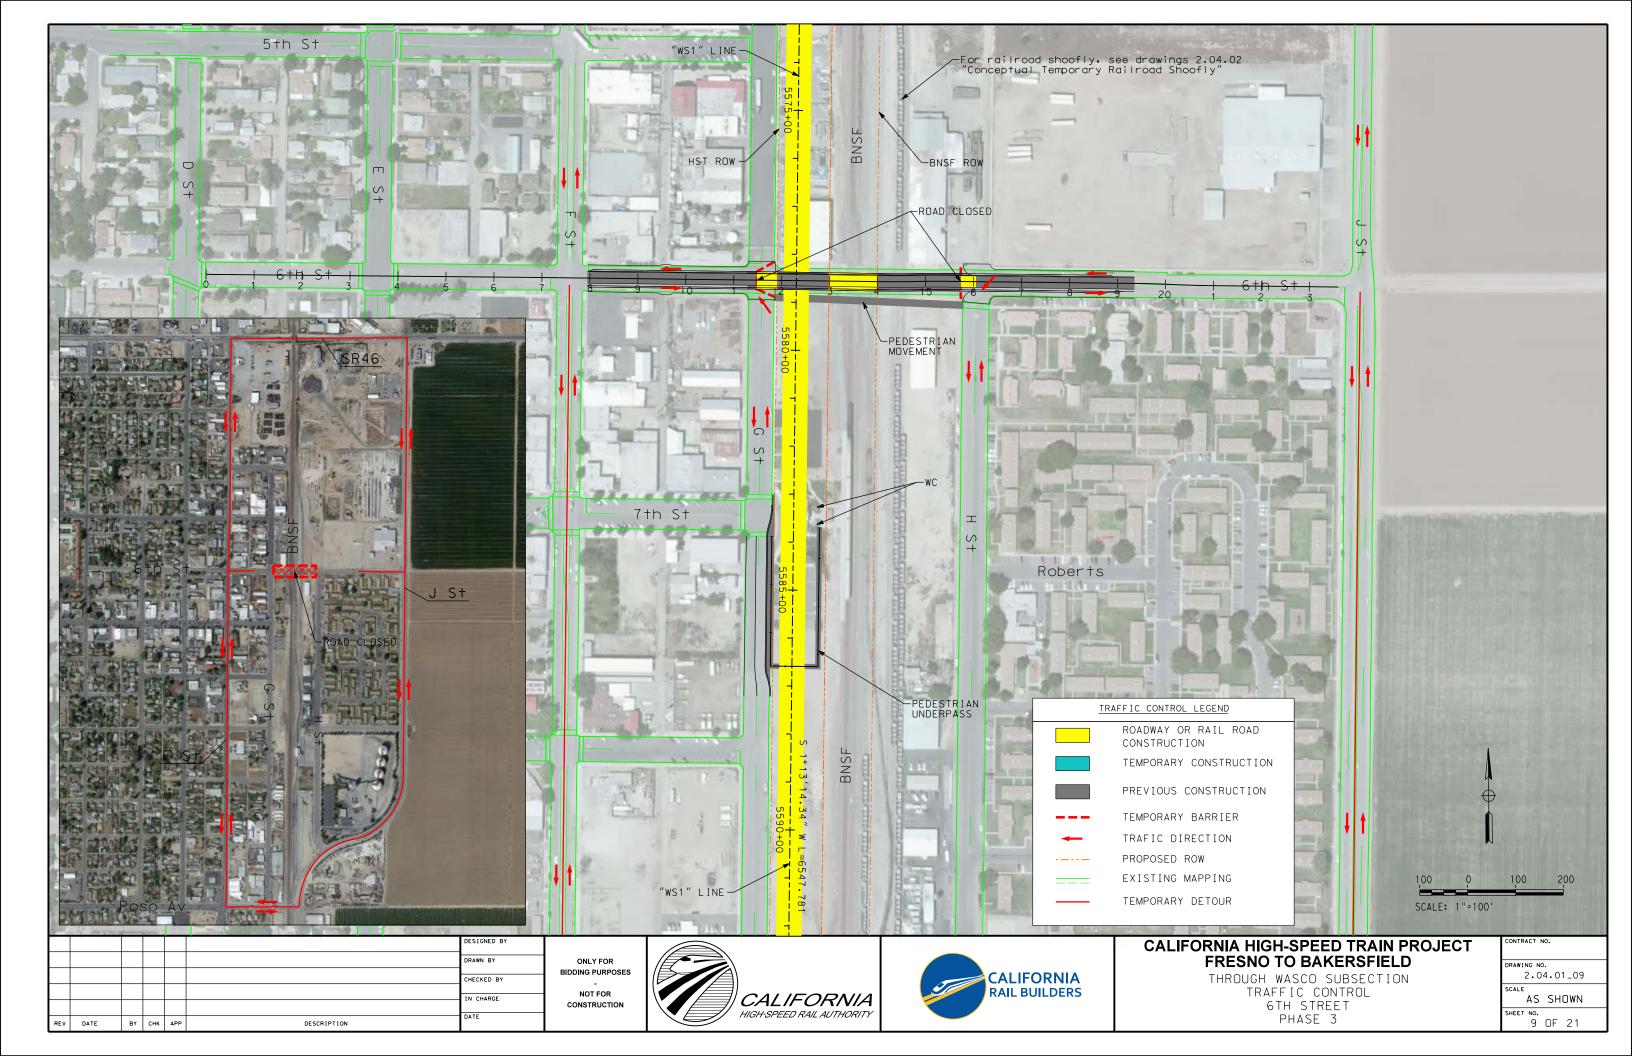


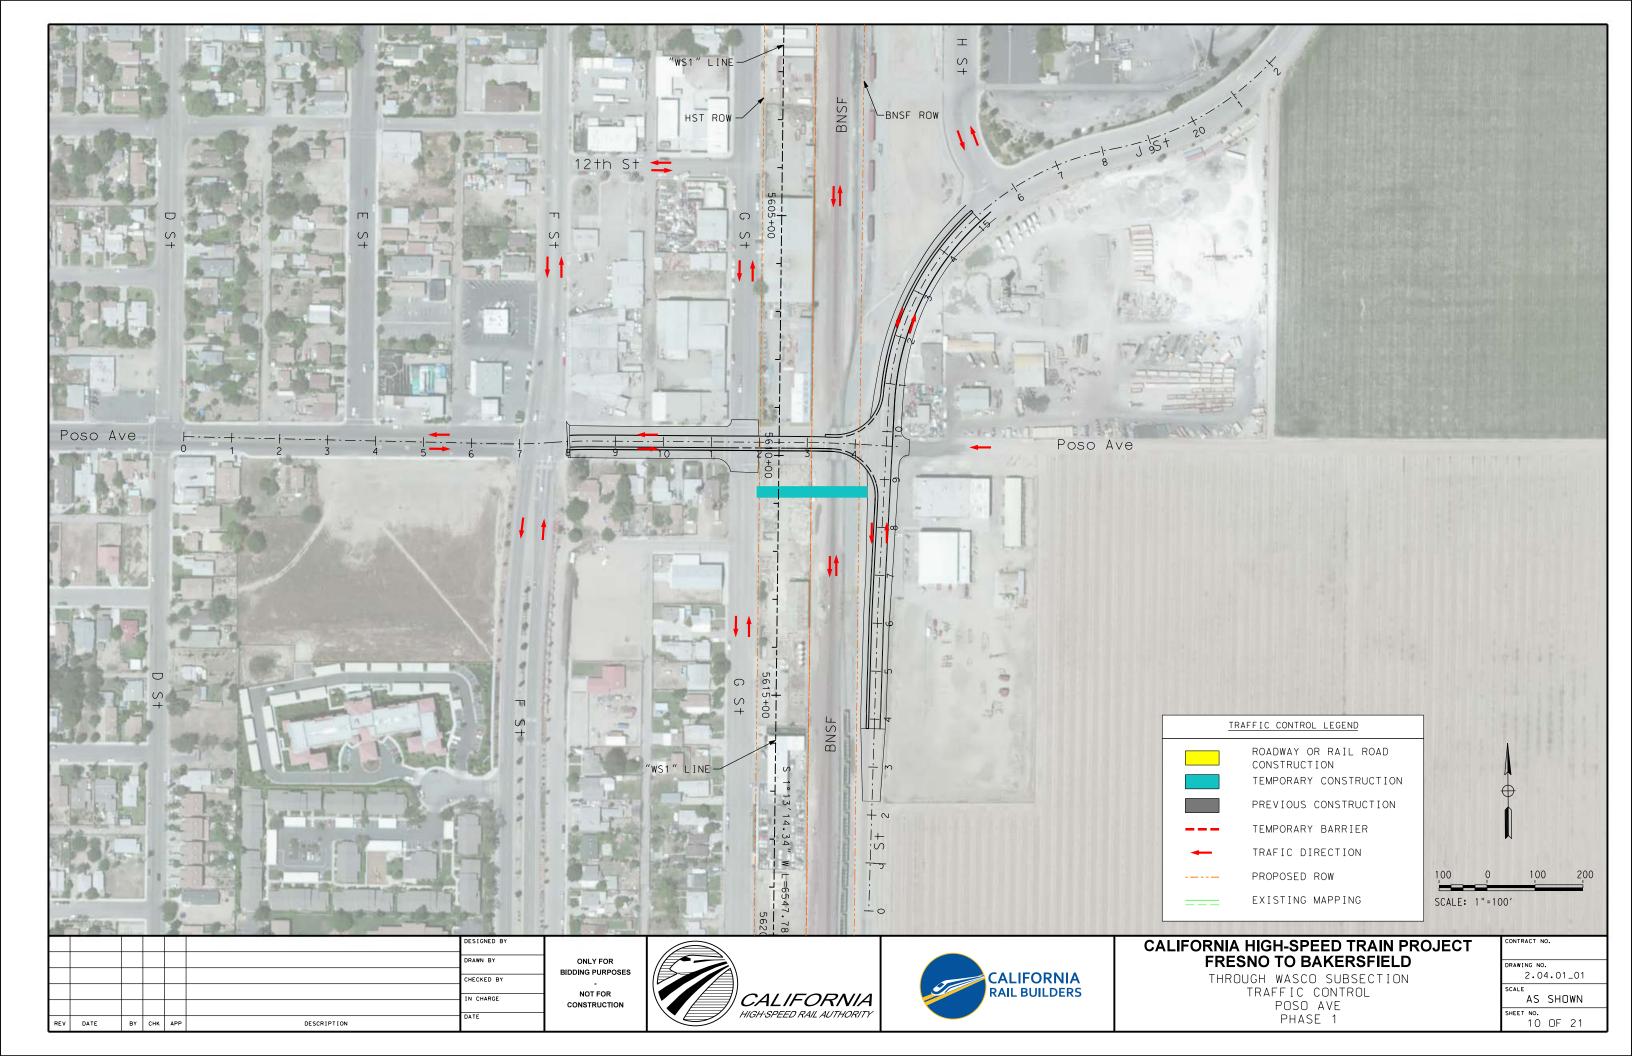


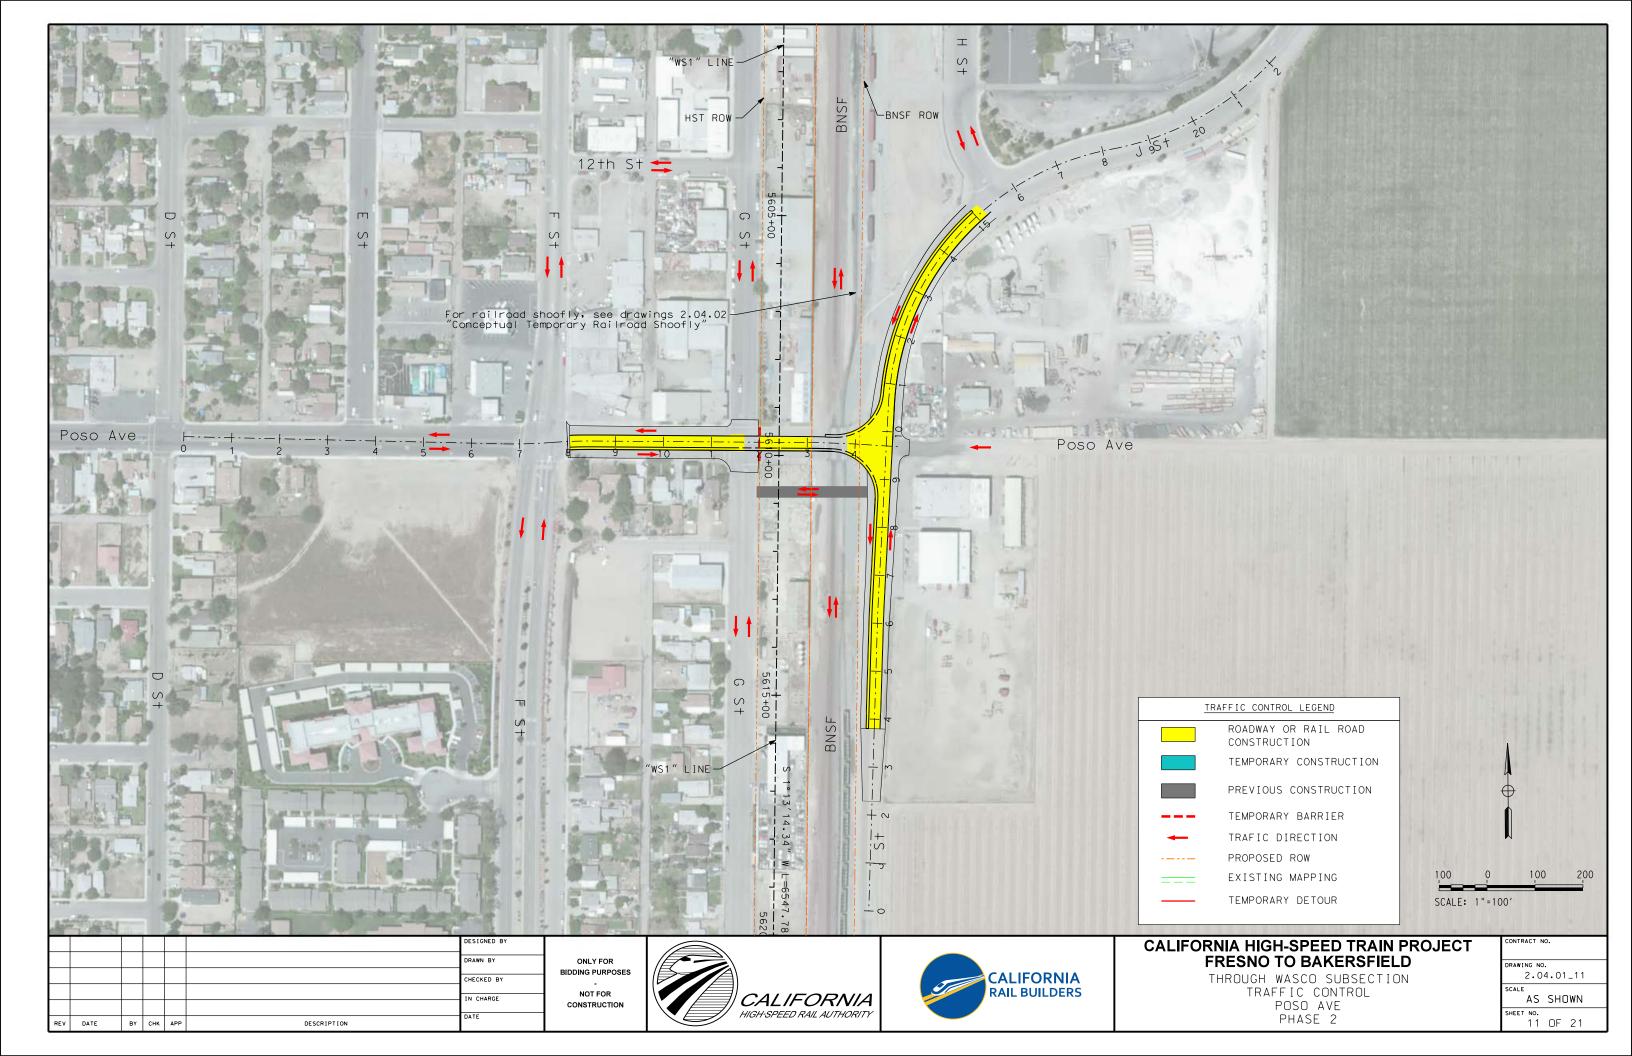


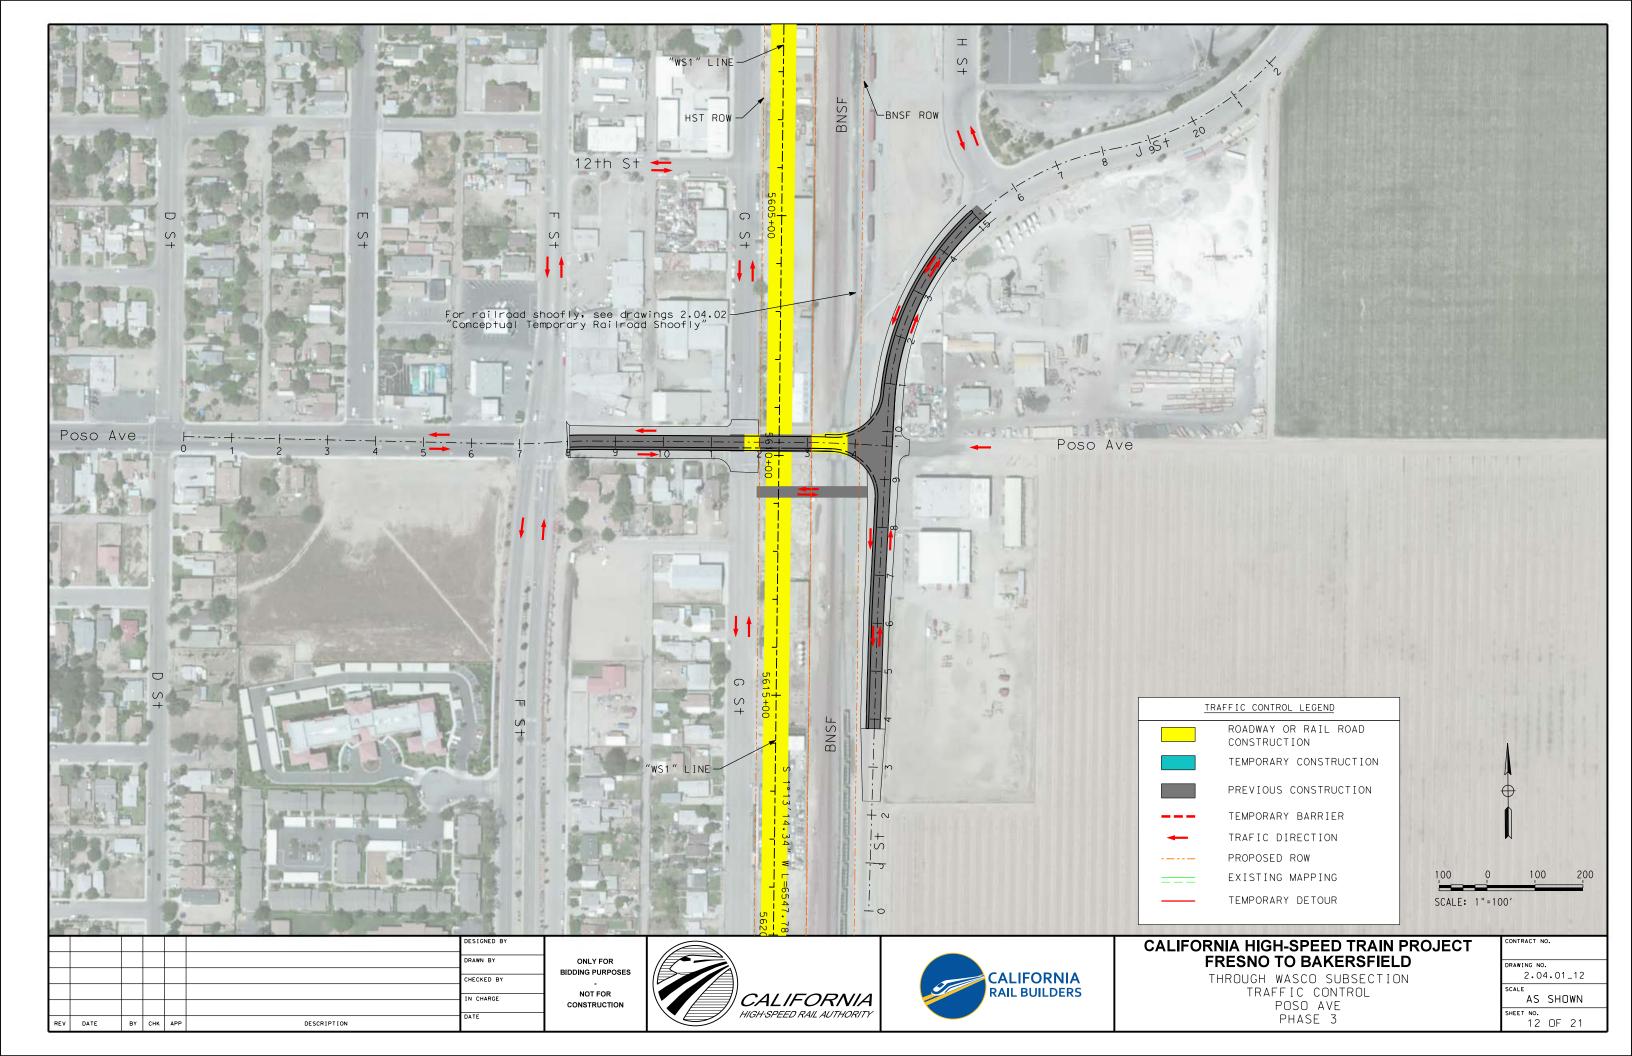


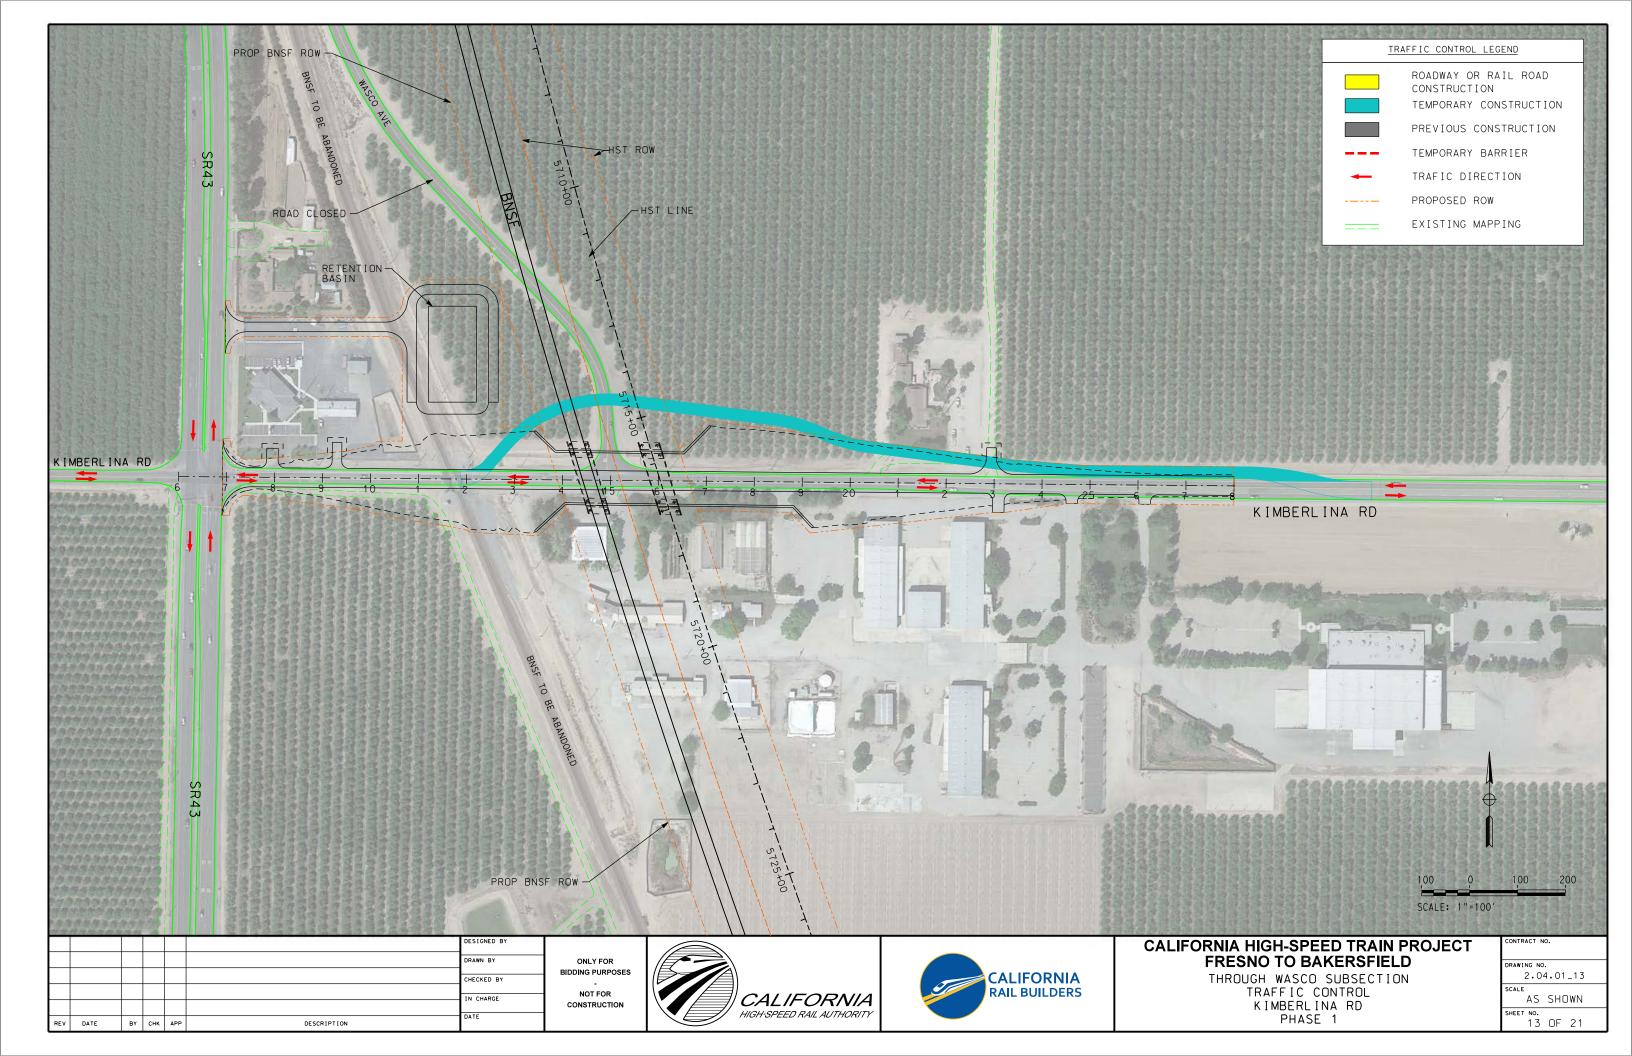


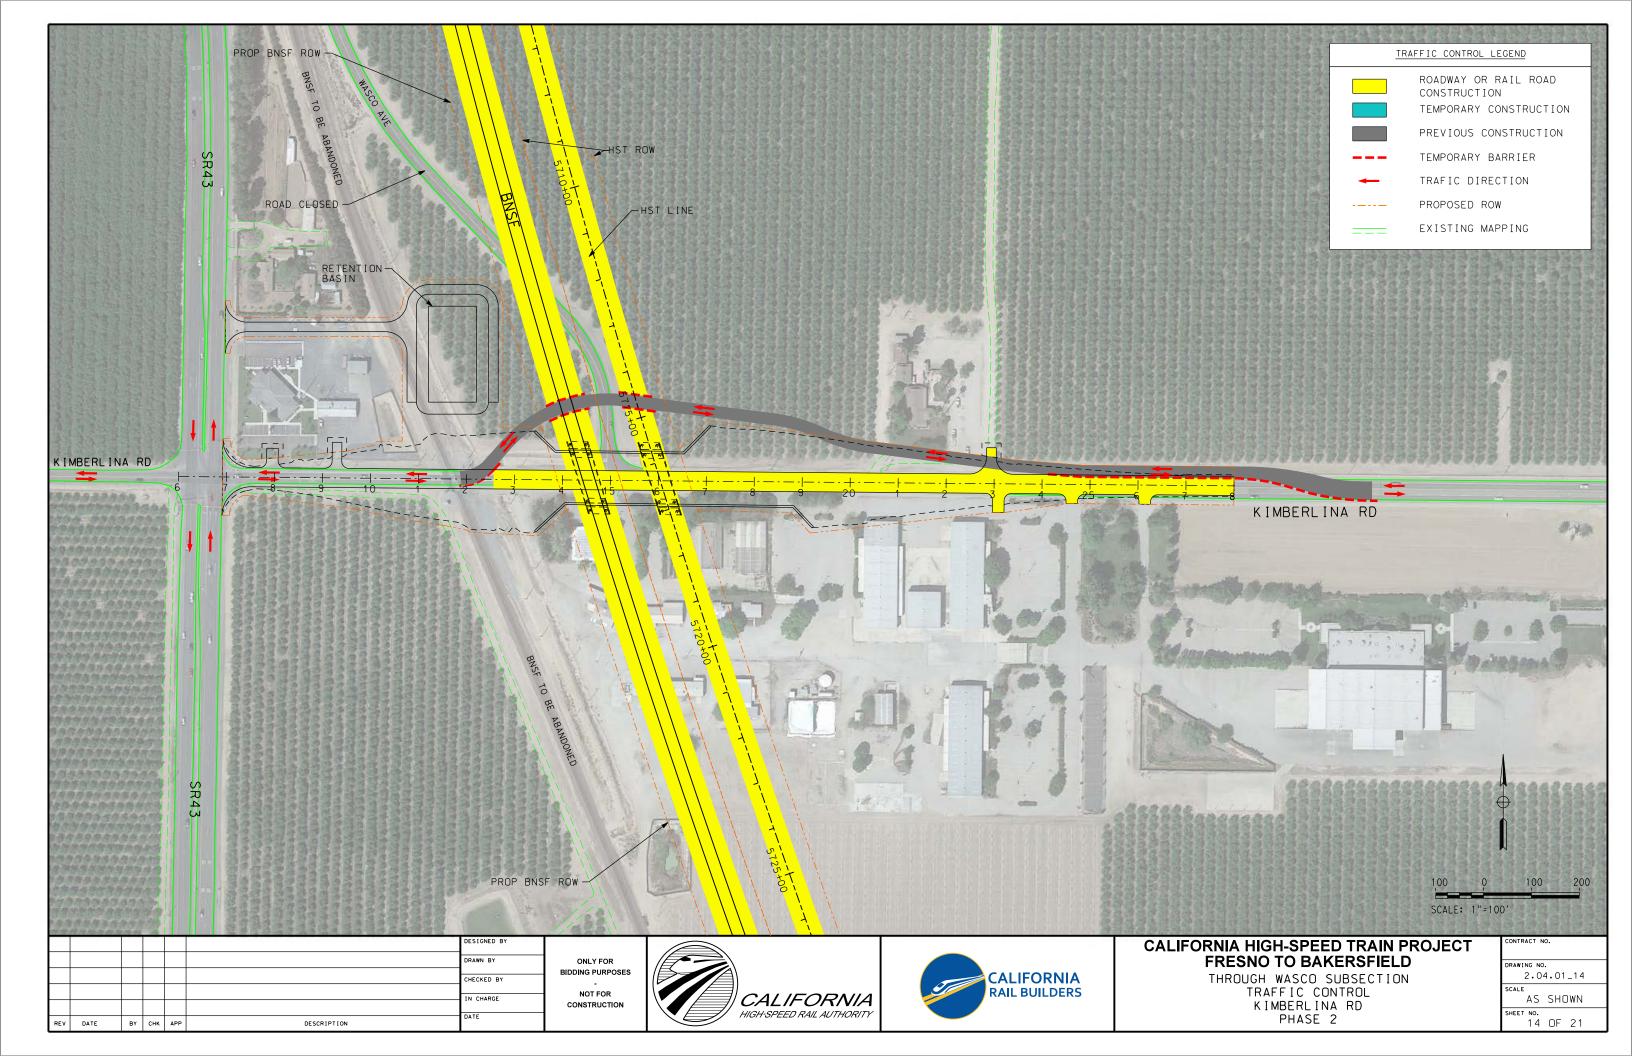


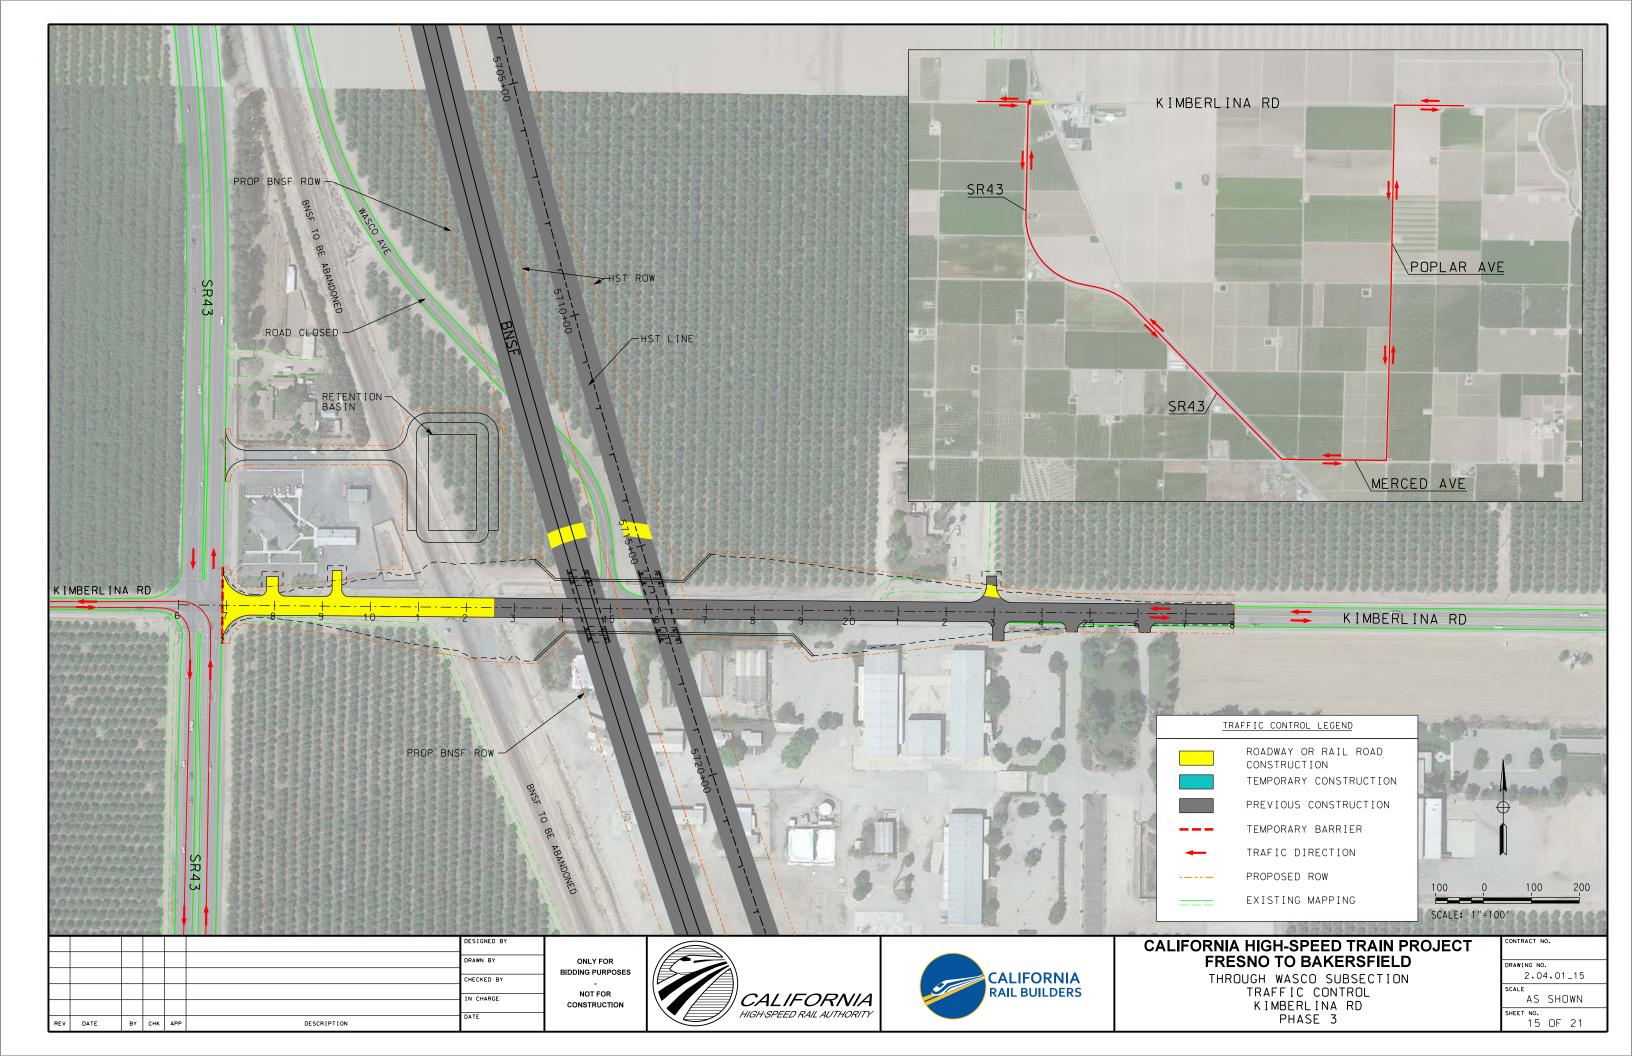


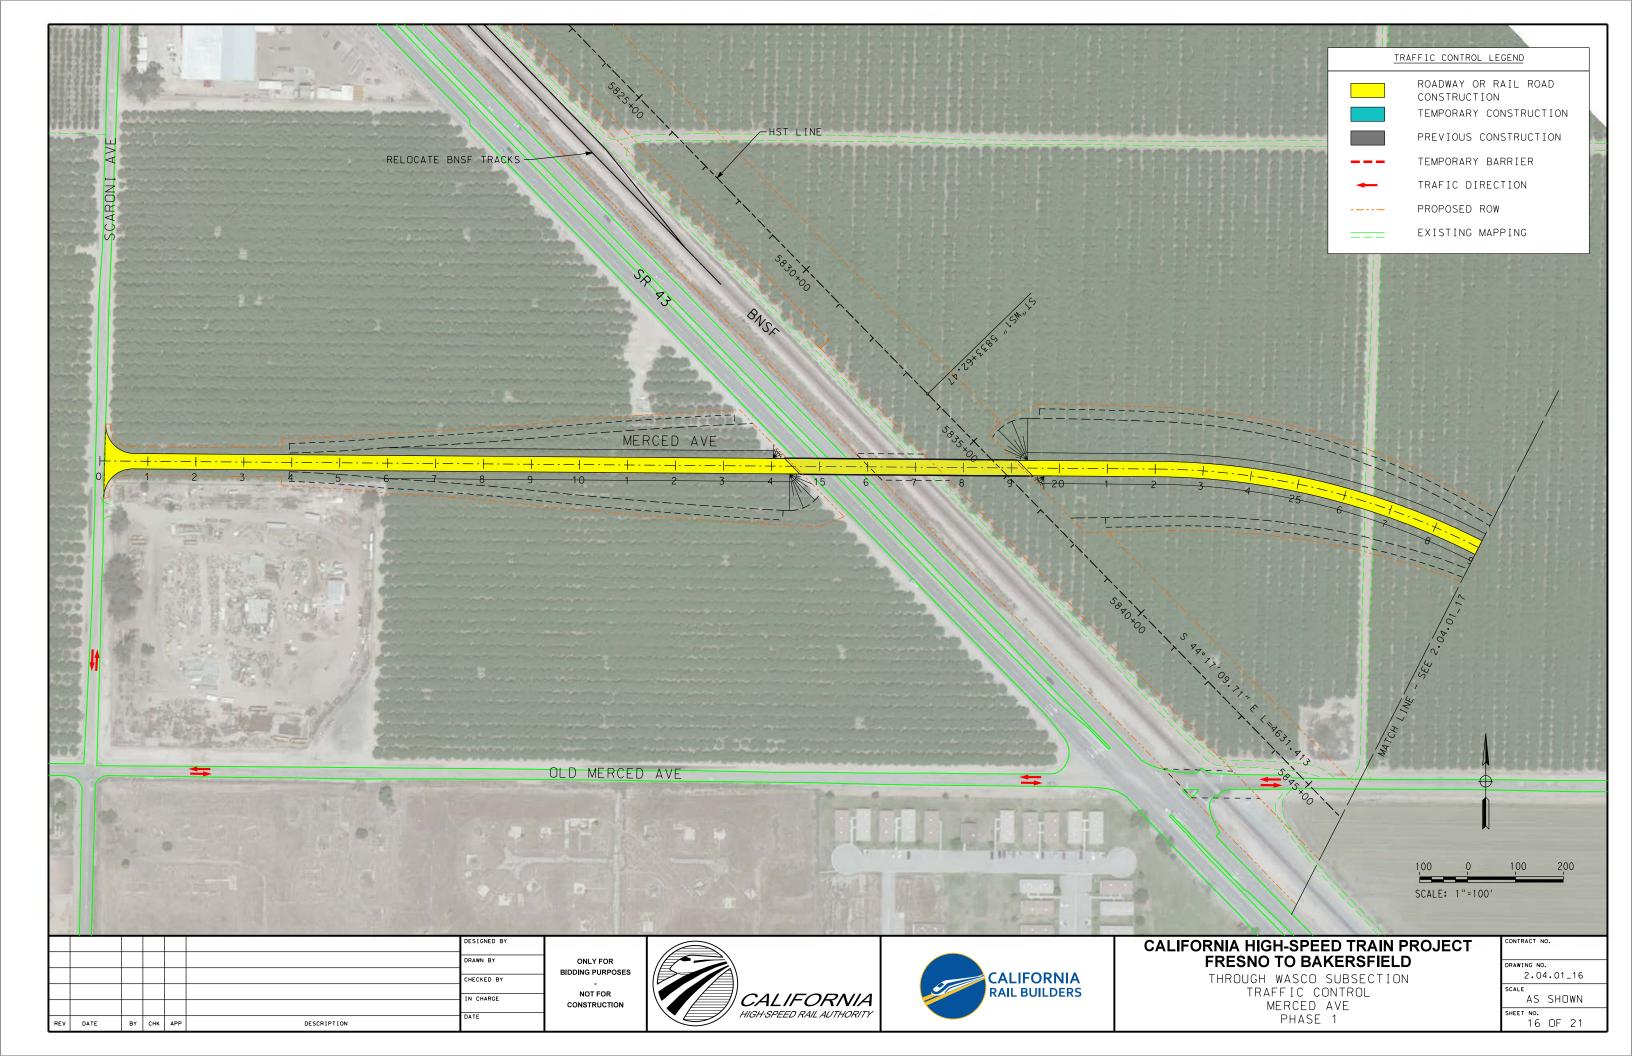


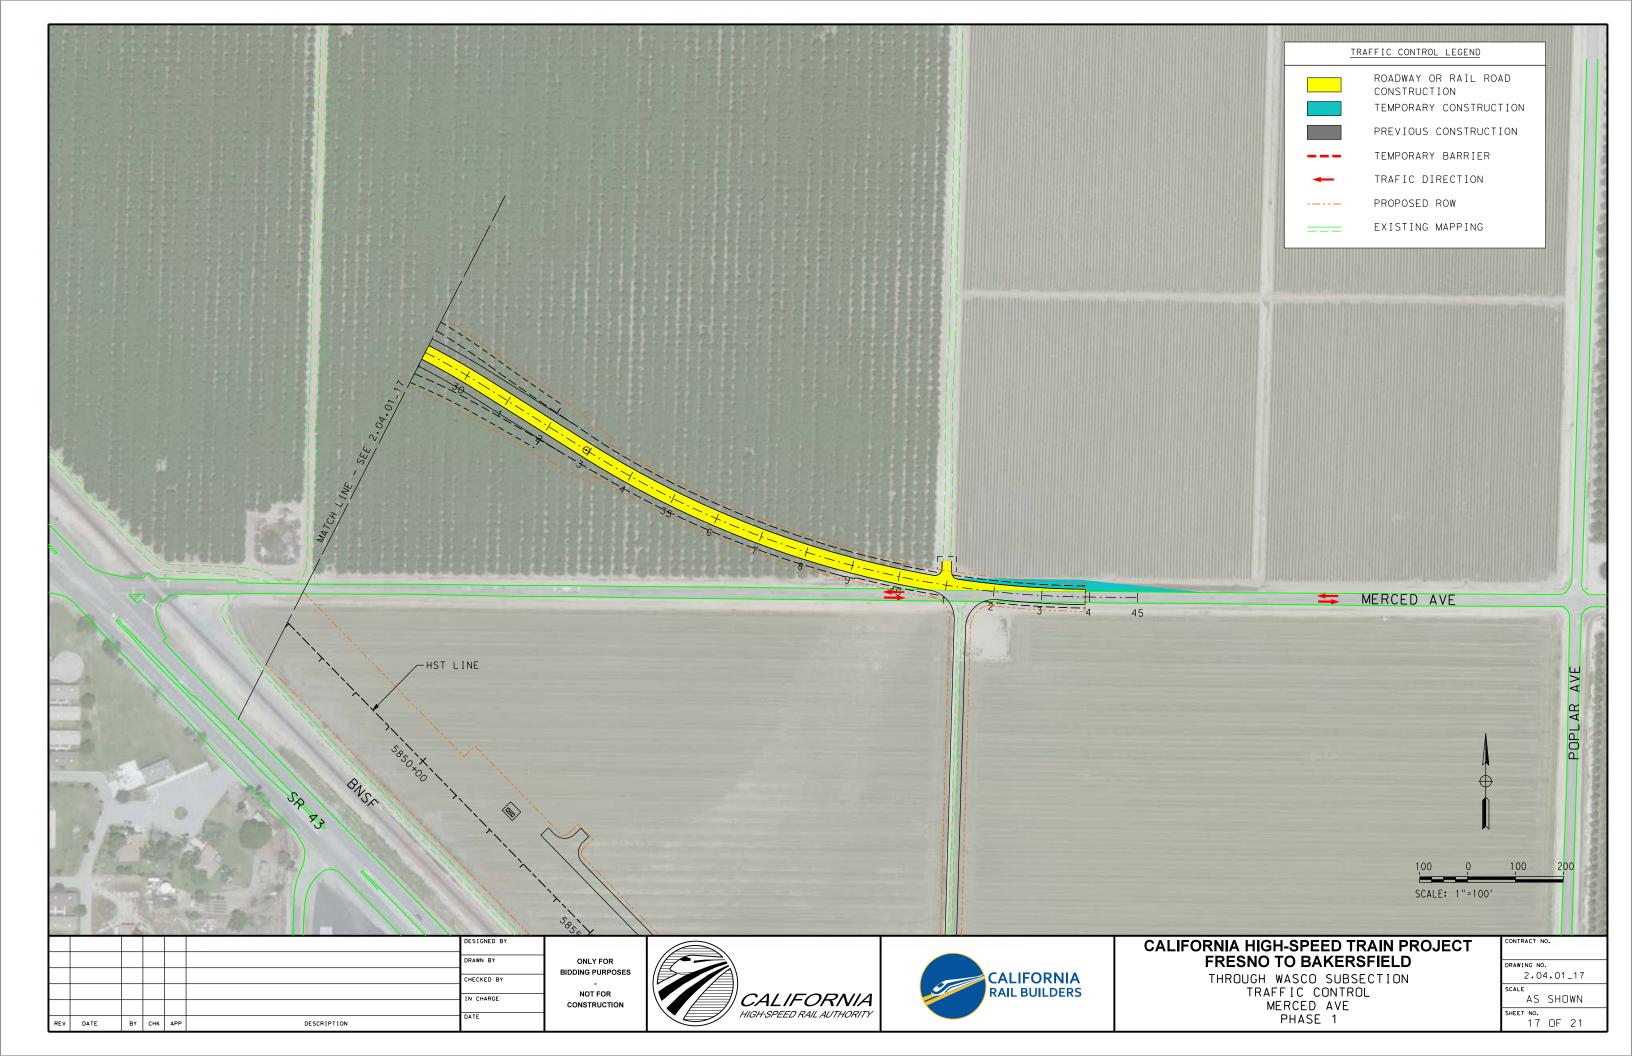

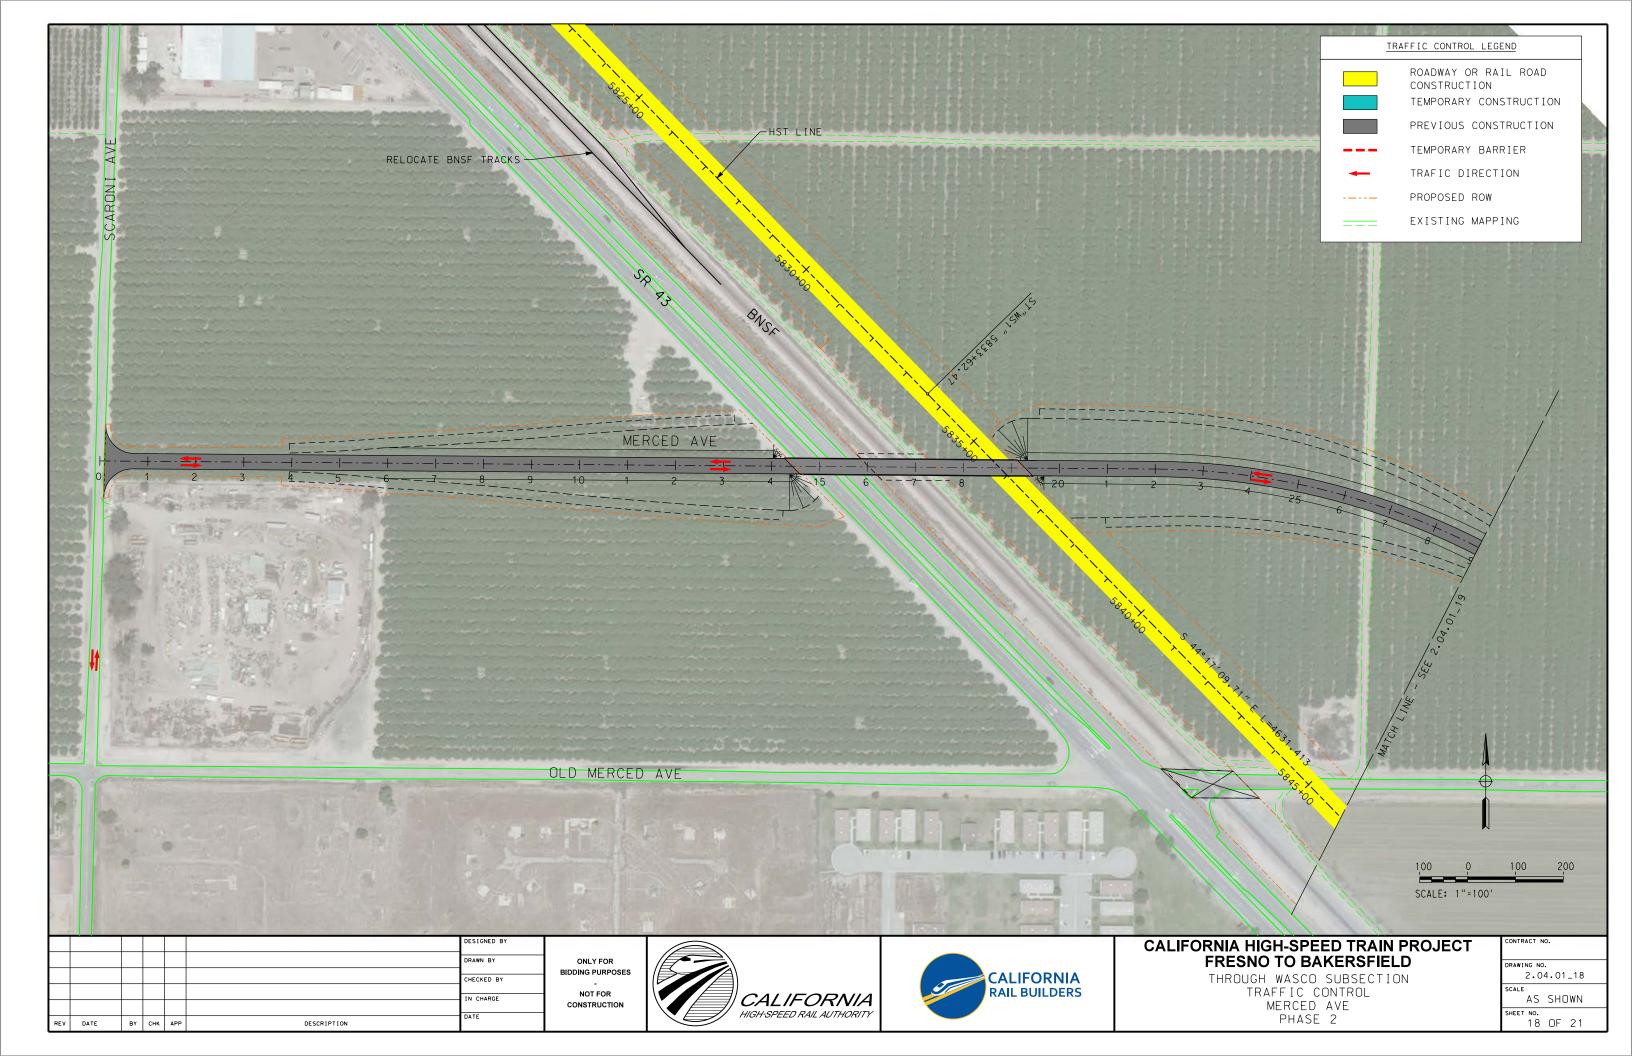

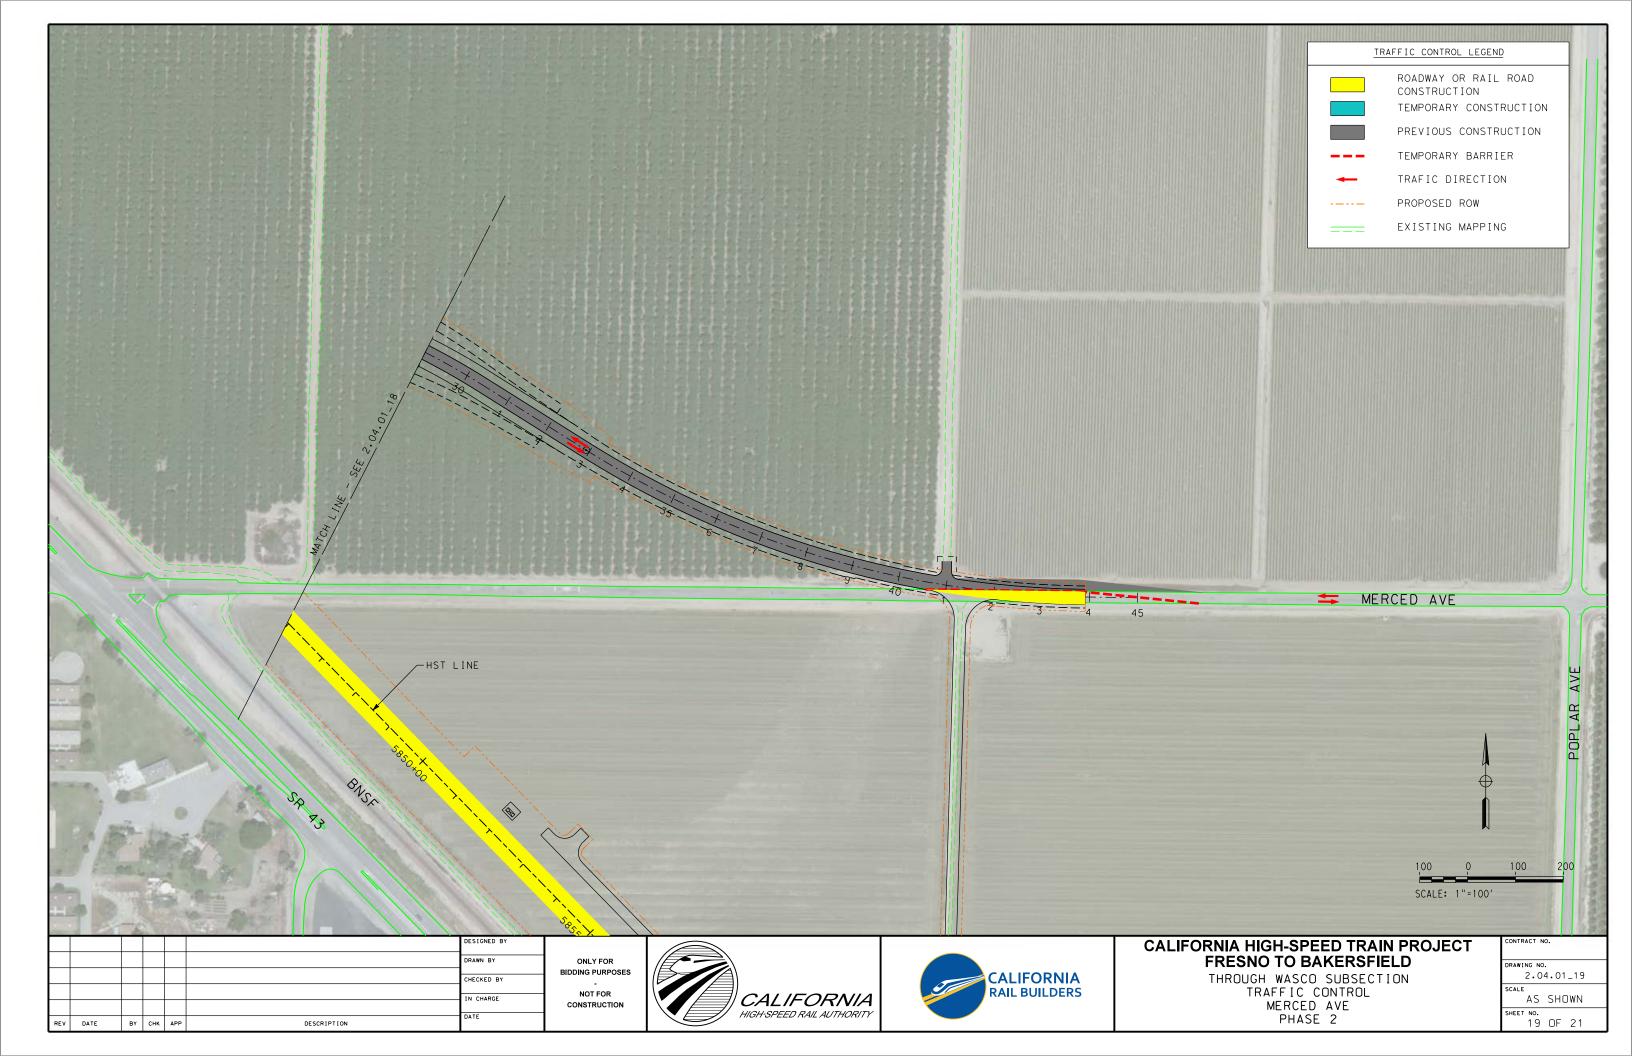


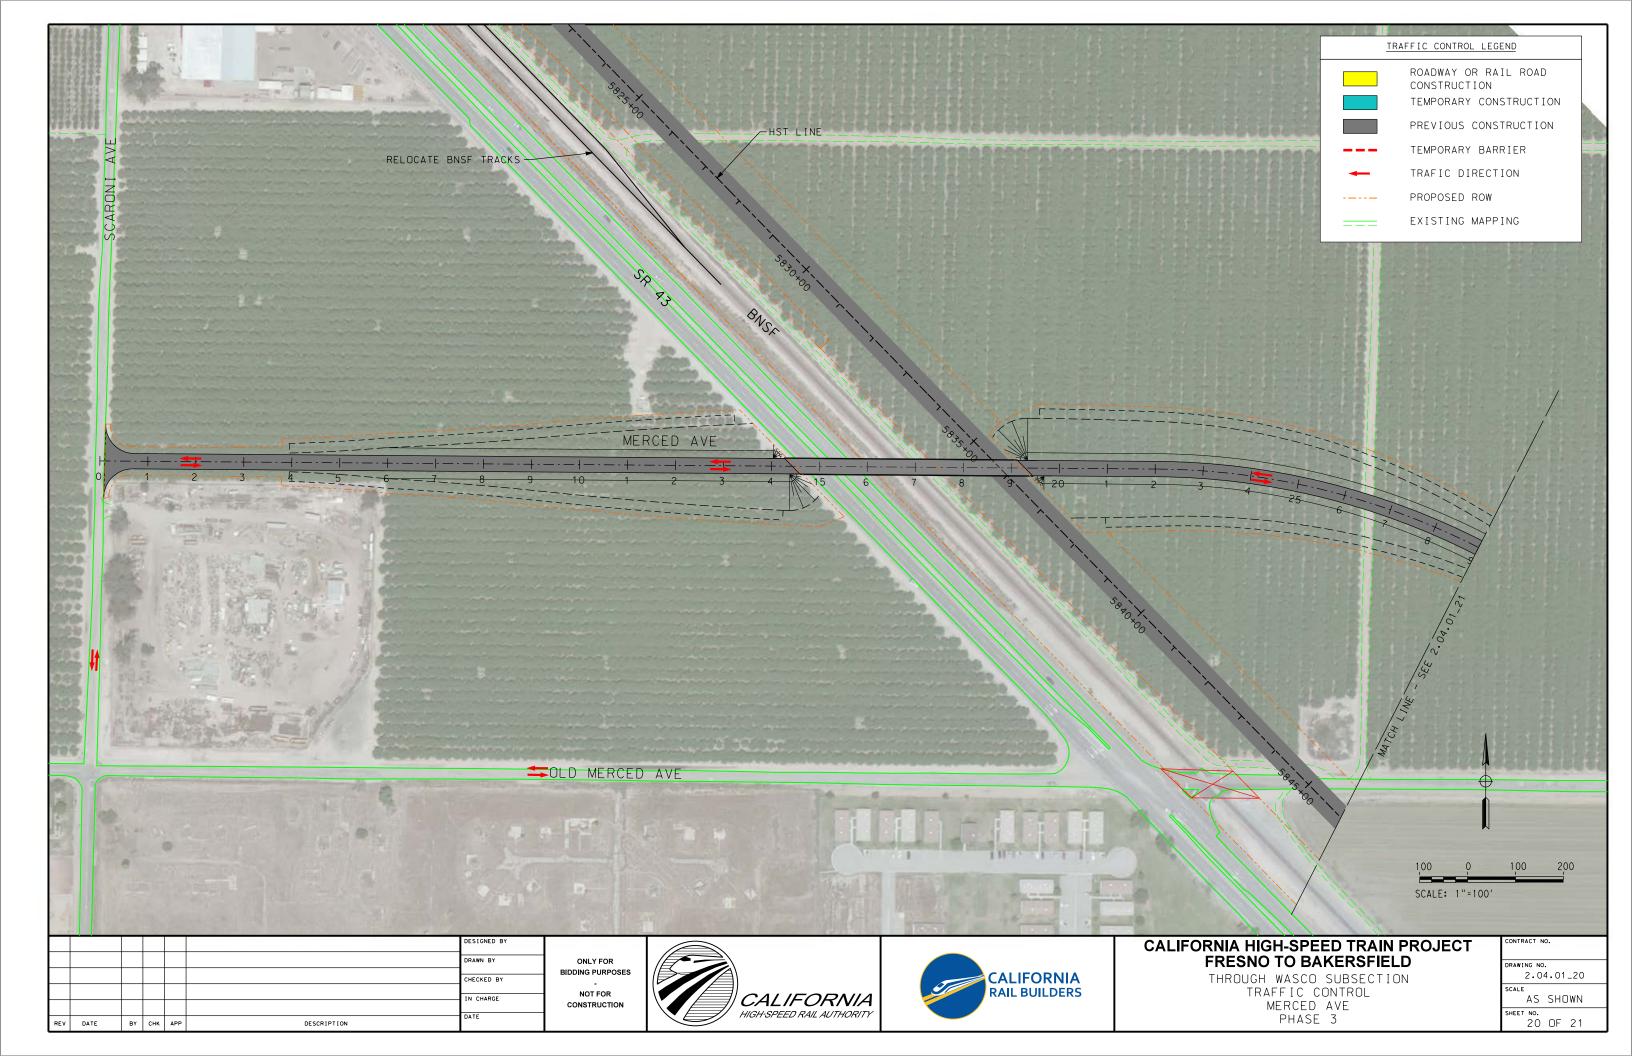

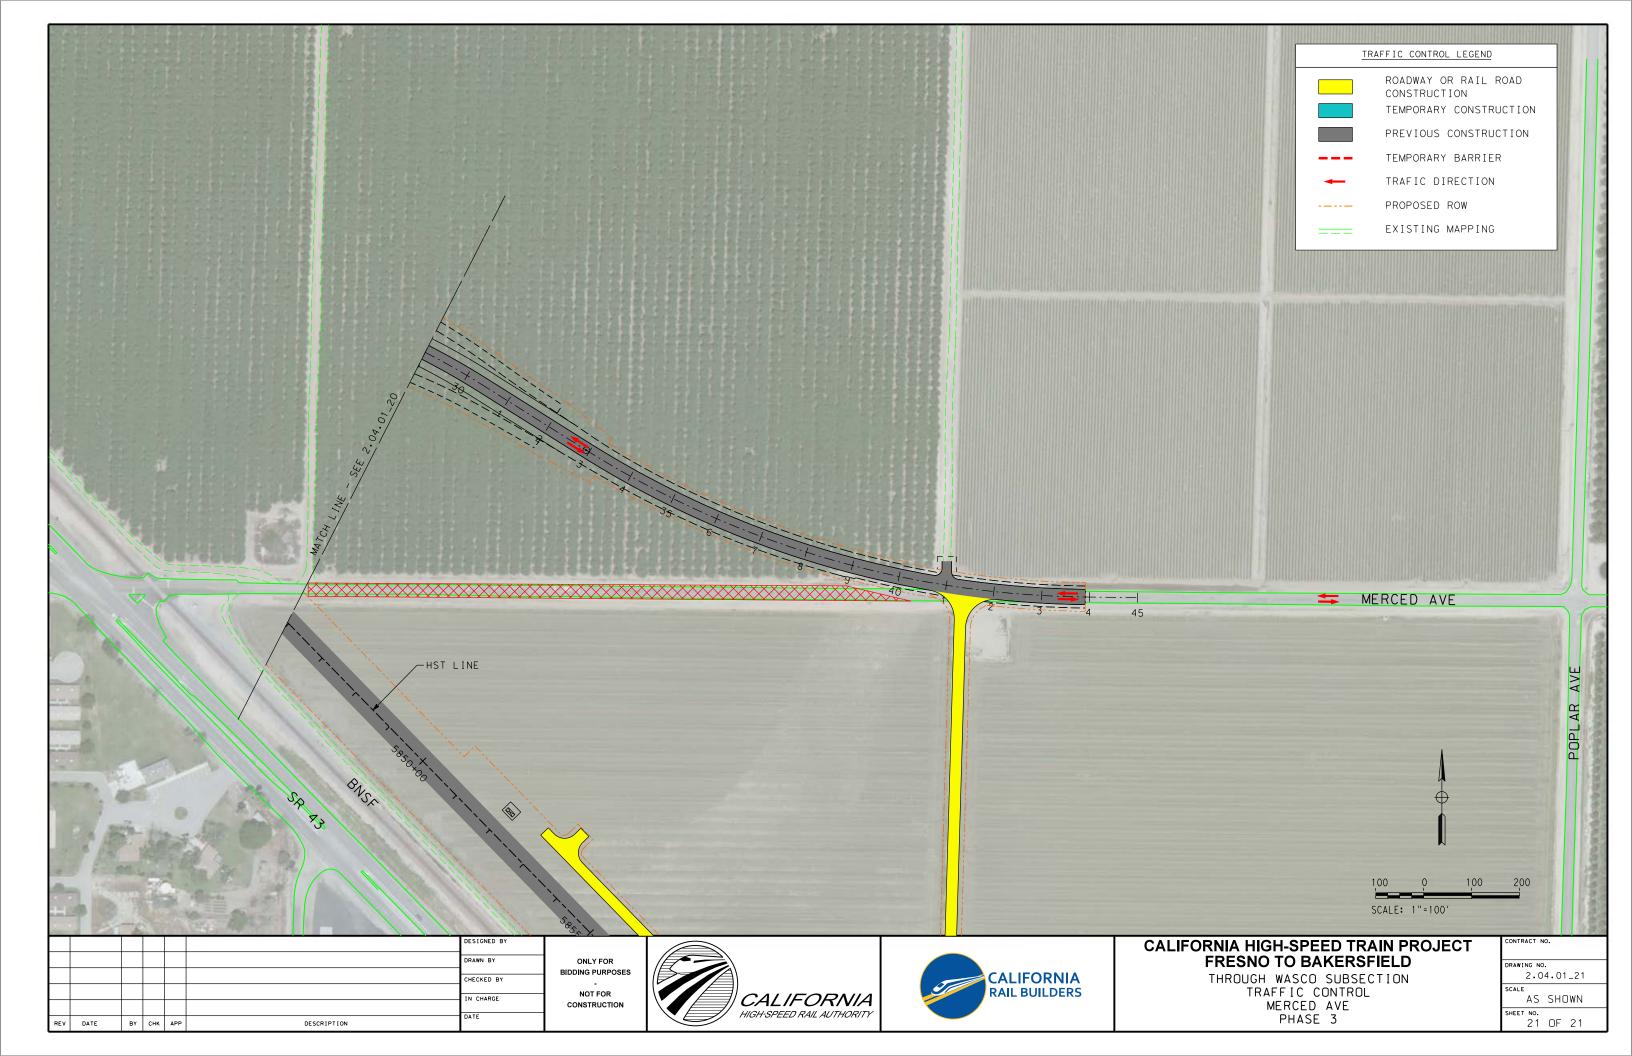

# CONCEPTUAL TEMPORARY RAILROAD SHOOFLY



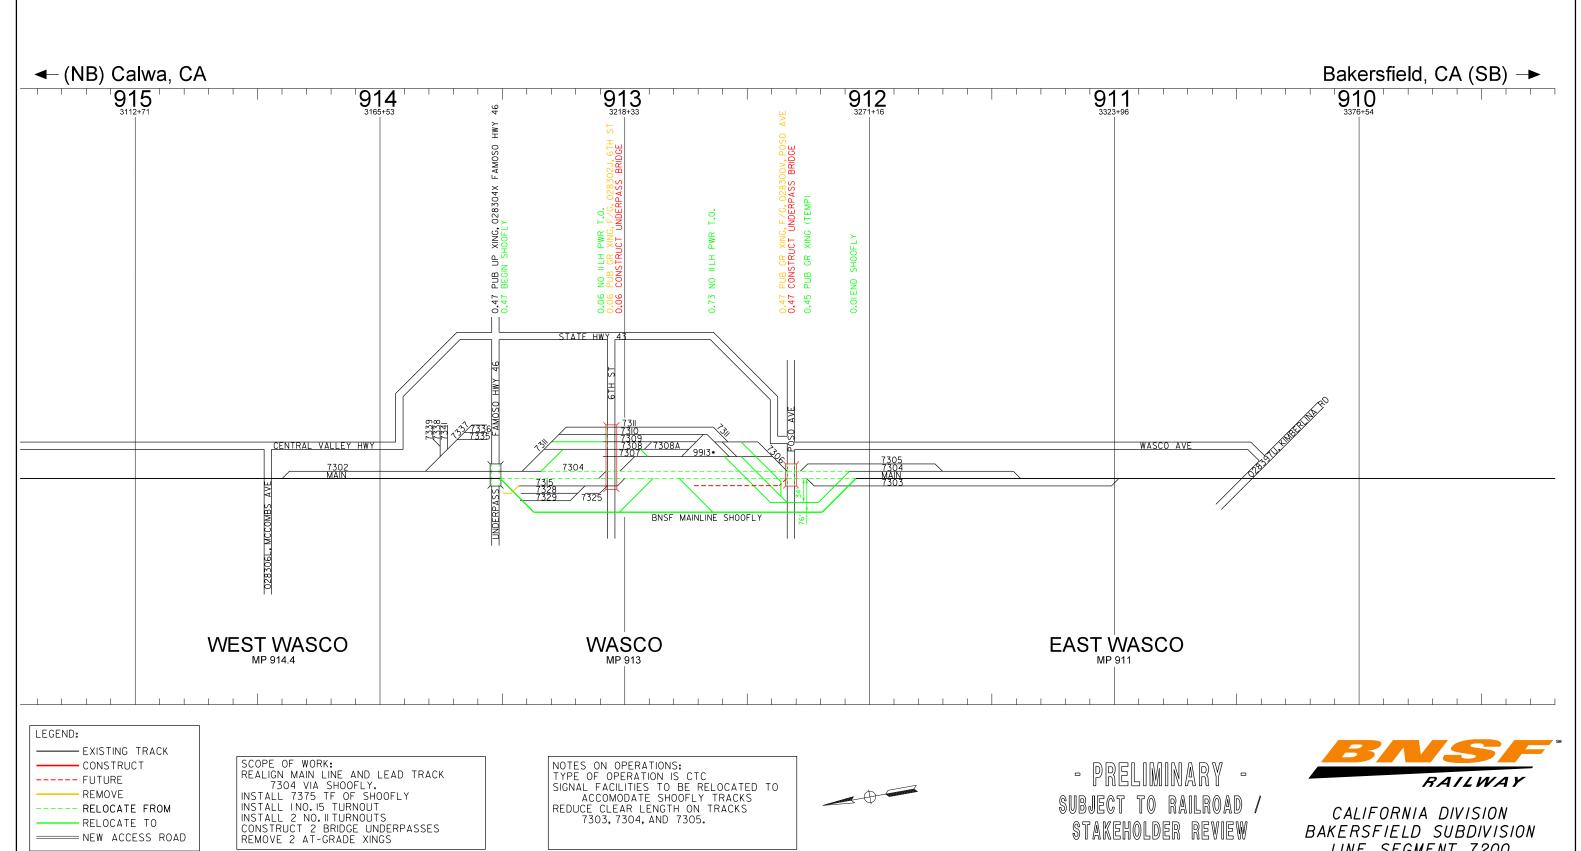

DESIGNED BY 00 10/29/15 CONCEPTUAL DESIGN - BID SUBMITTAL 01 11/04/15 DESIGN REVISIONS RAWN BY CHECKED BY N CHARGE REV DATE BY CHK APP DESCRIPTION

= NEW ACCESS ROAD

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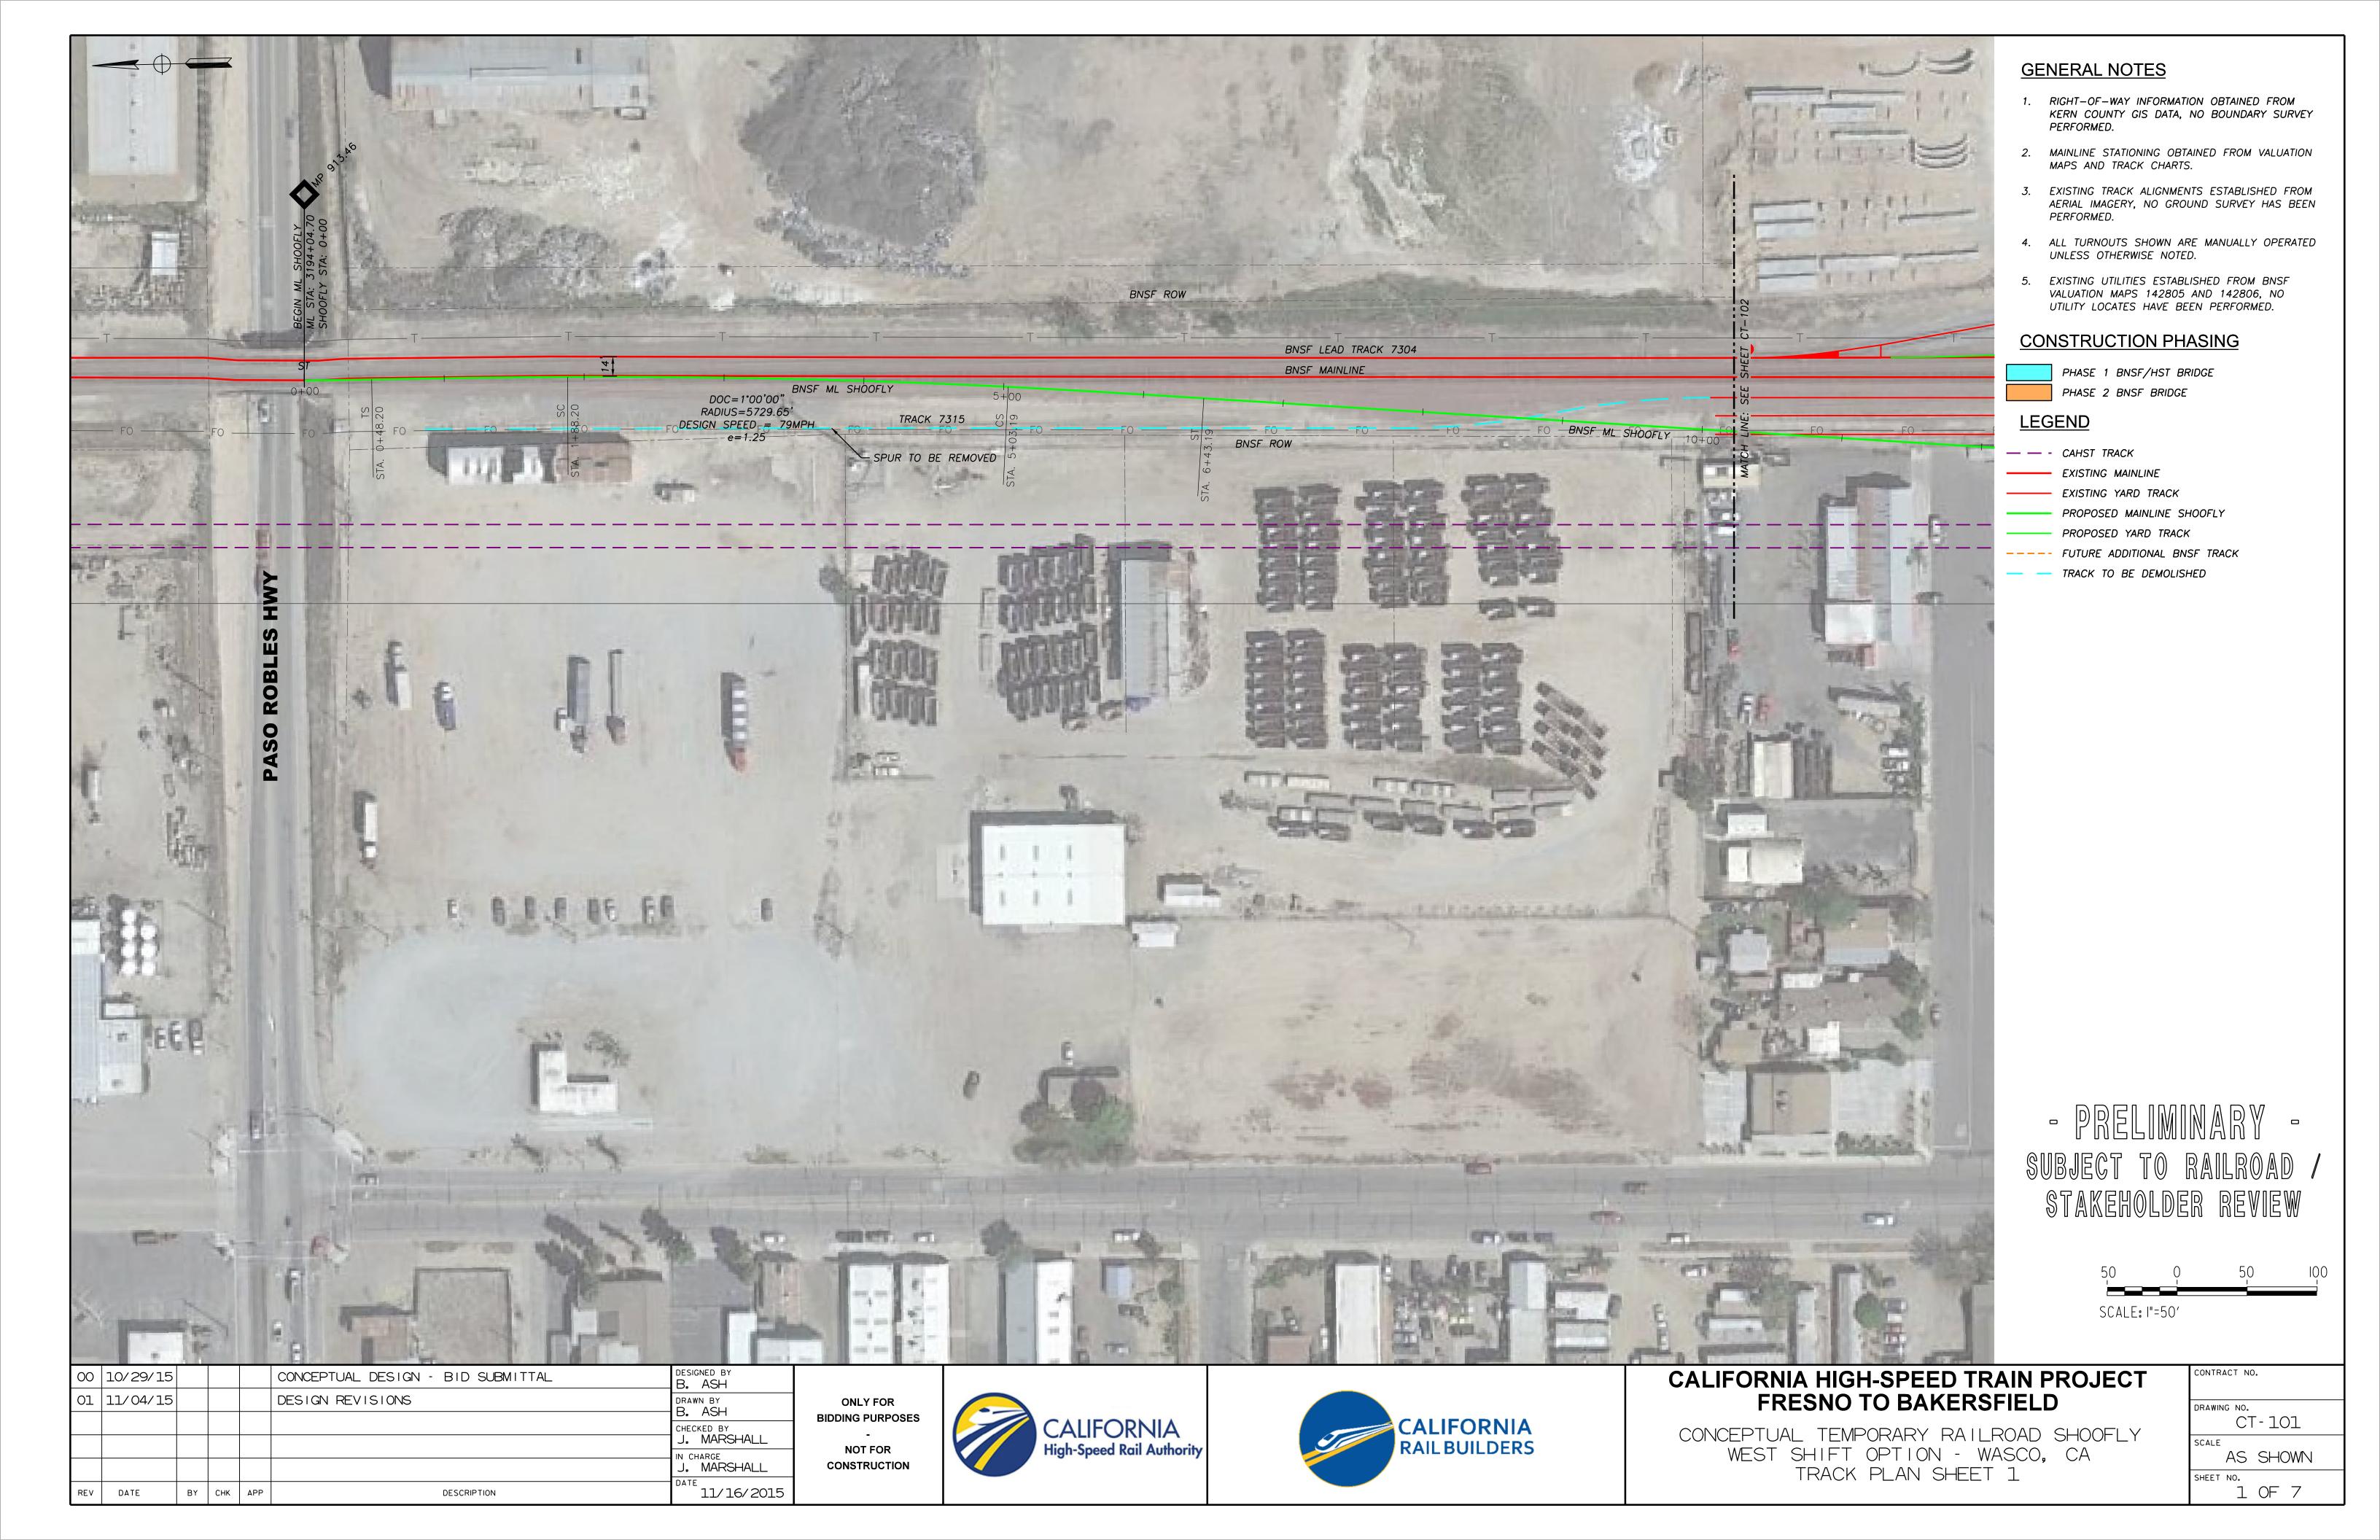
STAKEHOLDER REVIEW


CALIFORNIA DIVISION BAKERSFIELD SUBDIVISION LINE SEGMENT 7200


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FRESNO TO BAKERSFIELD


CONCEPTUAL TEMPORARY RAILROAD SHOOFLY WEST SHIFT OPTION SCHEMATIC - WASCO, CA MP 908.6 TO 910.8


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DRAWING NO.
SCALE
N. T. S.




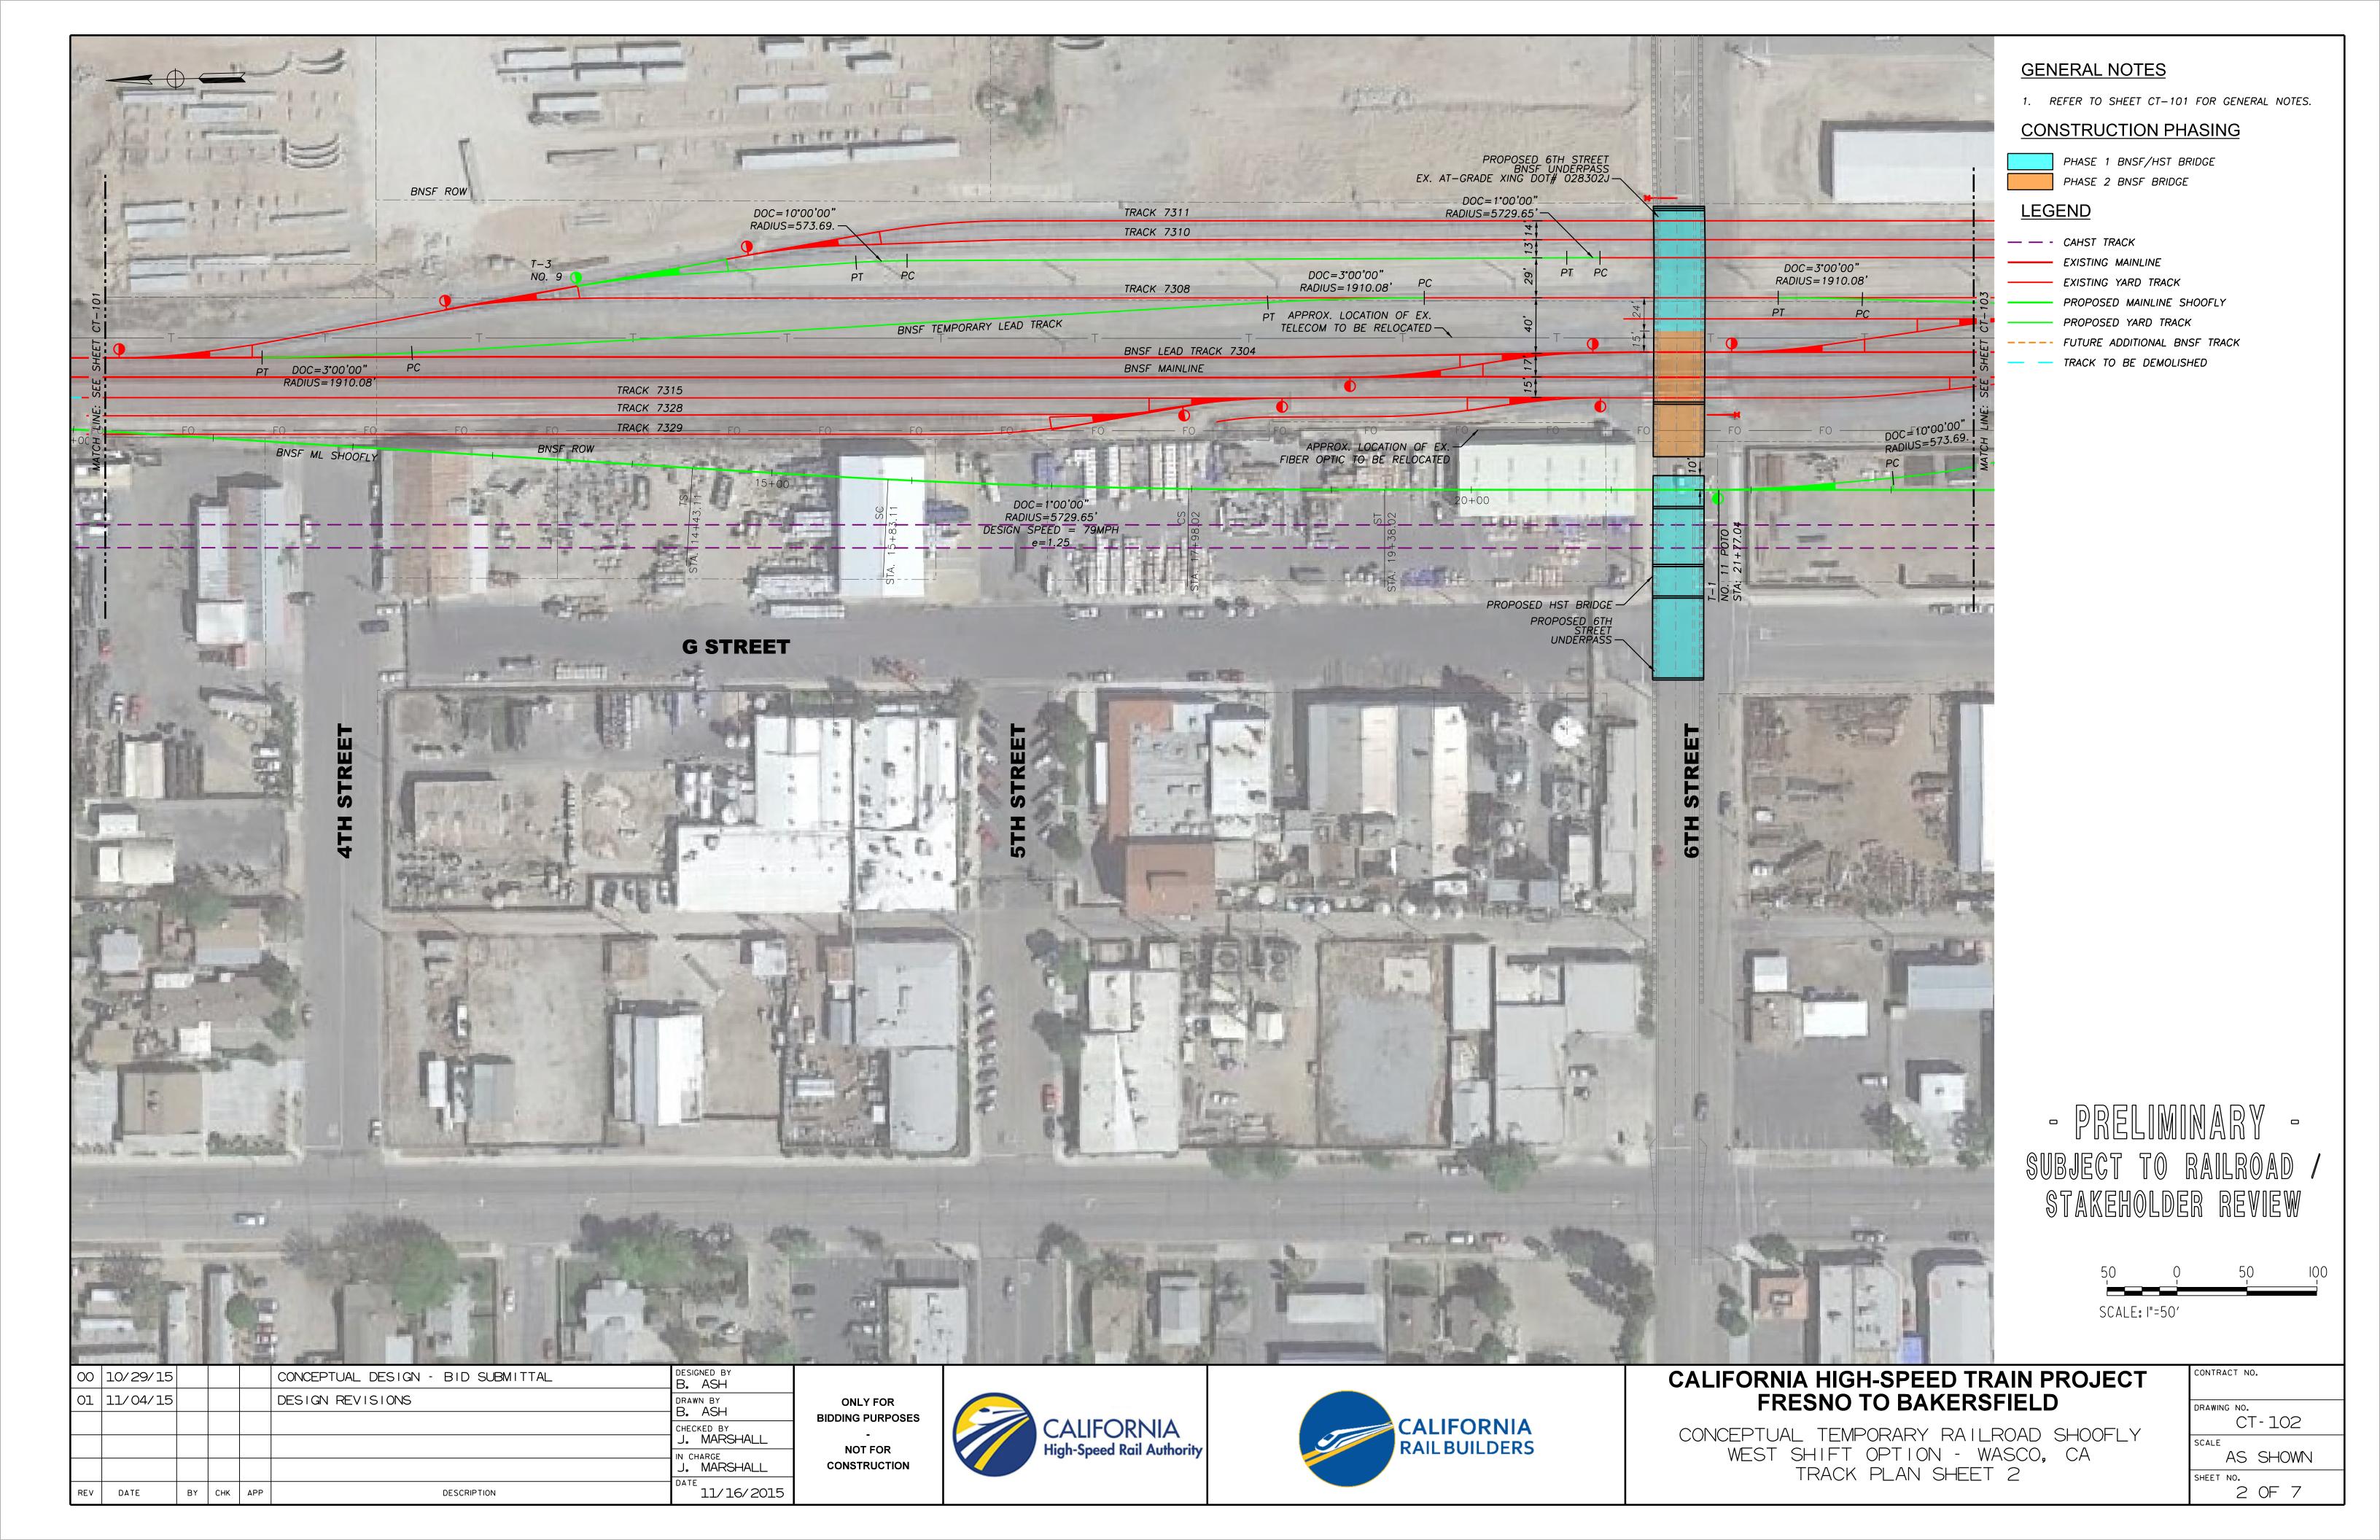

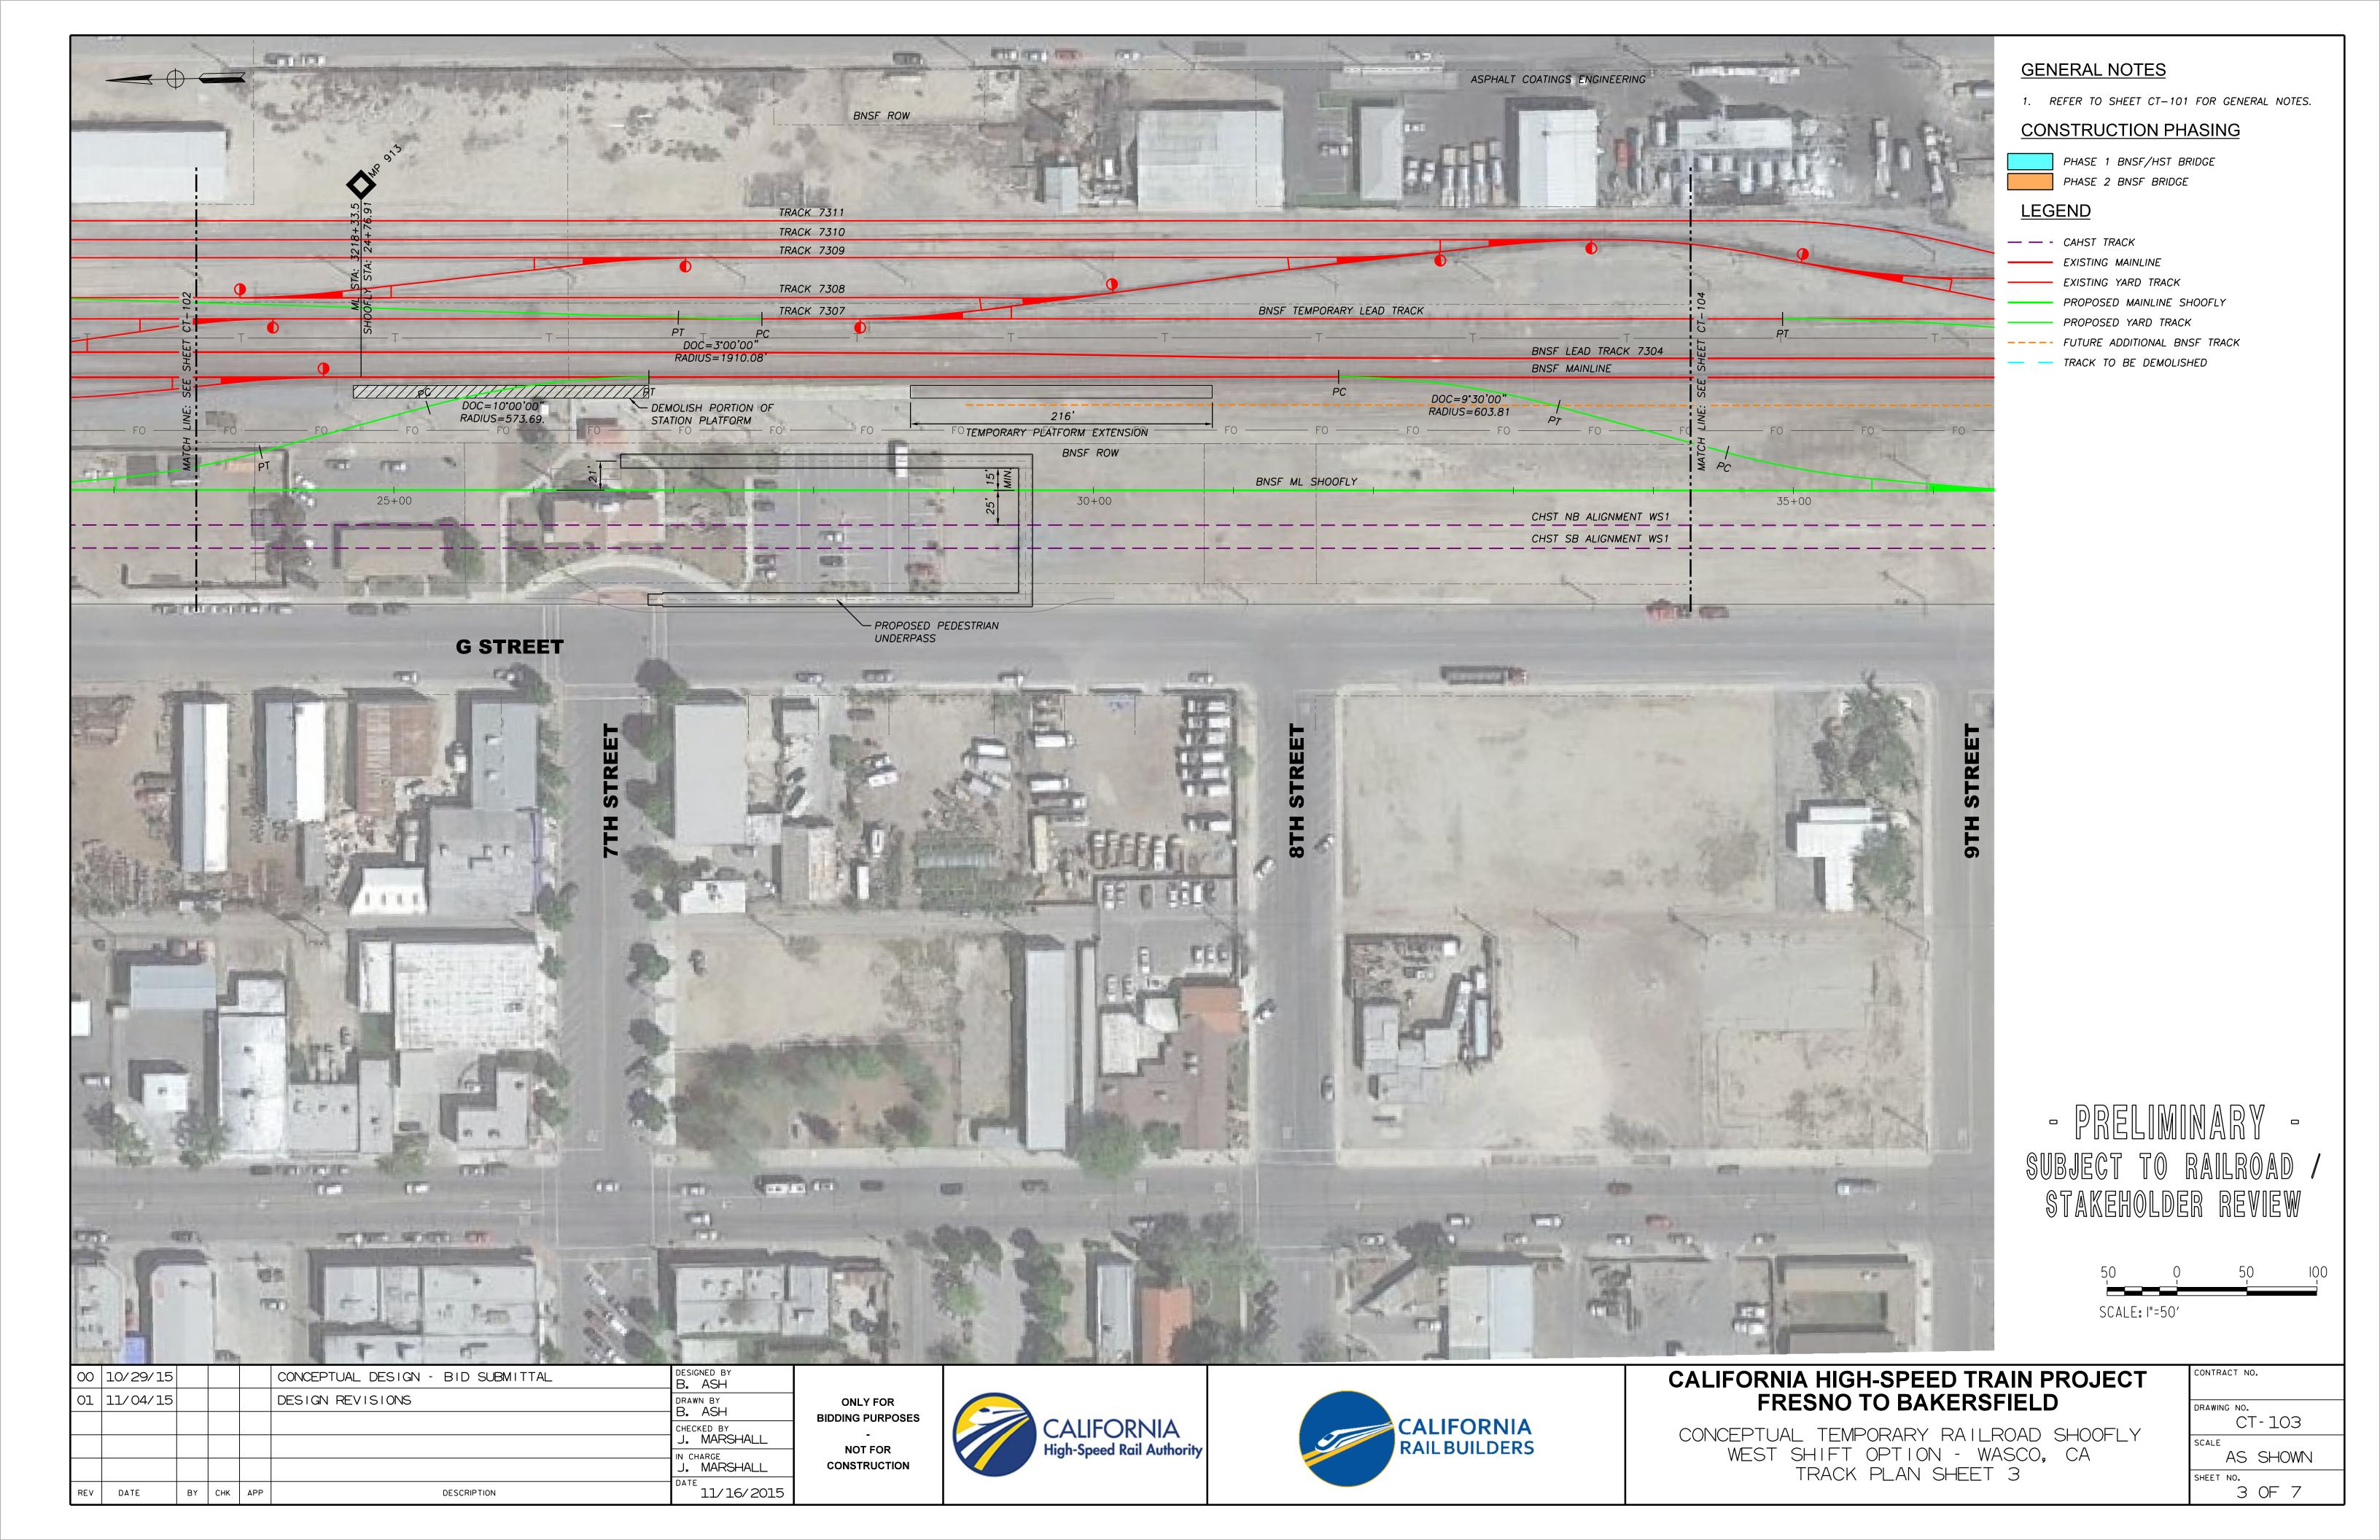

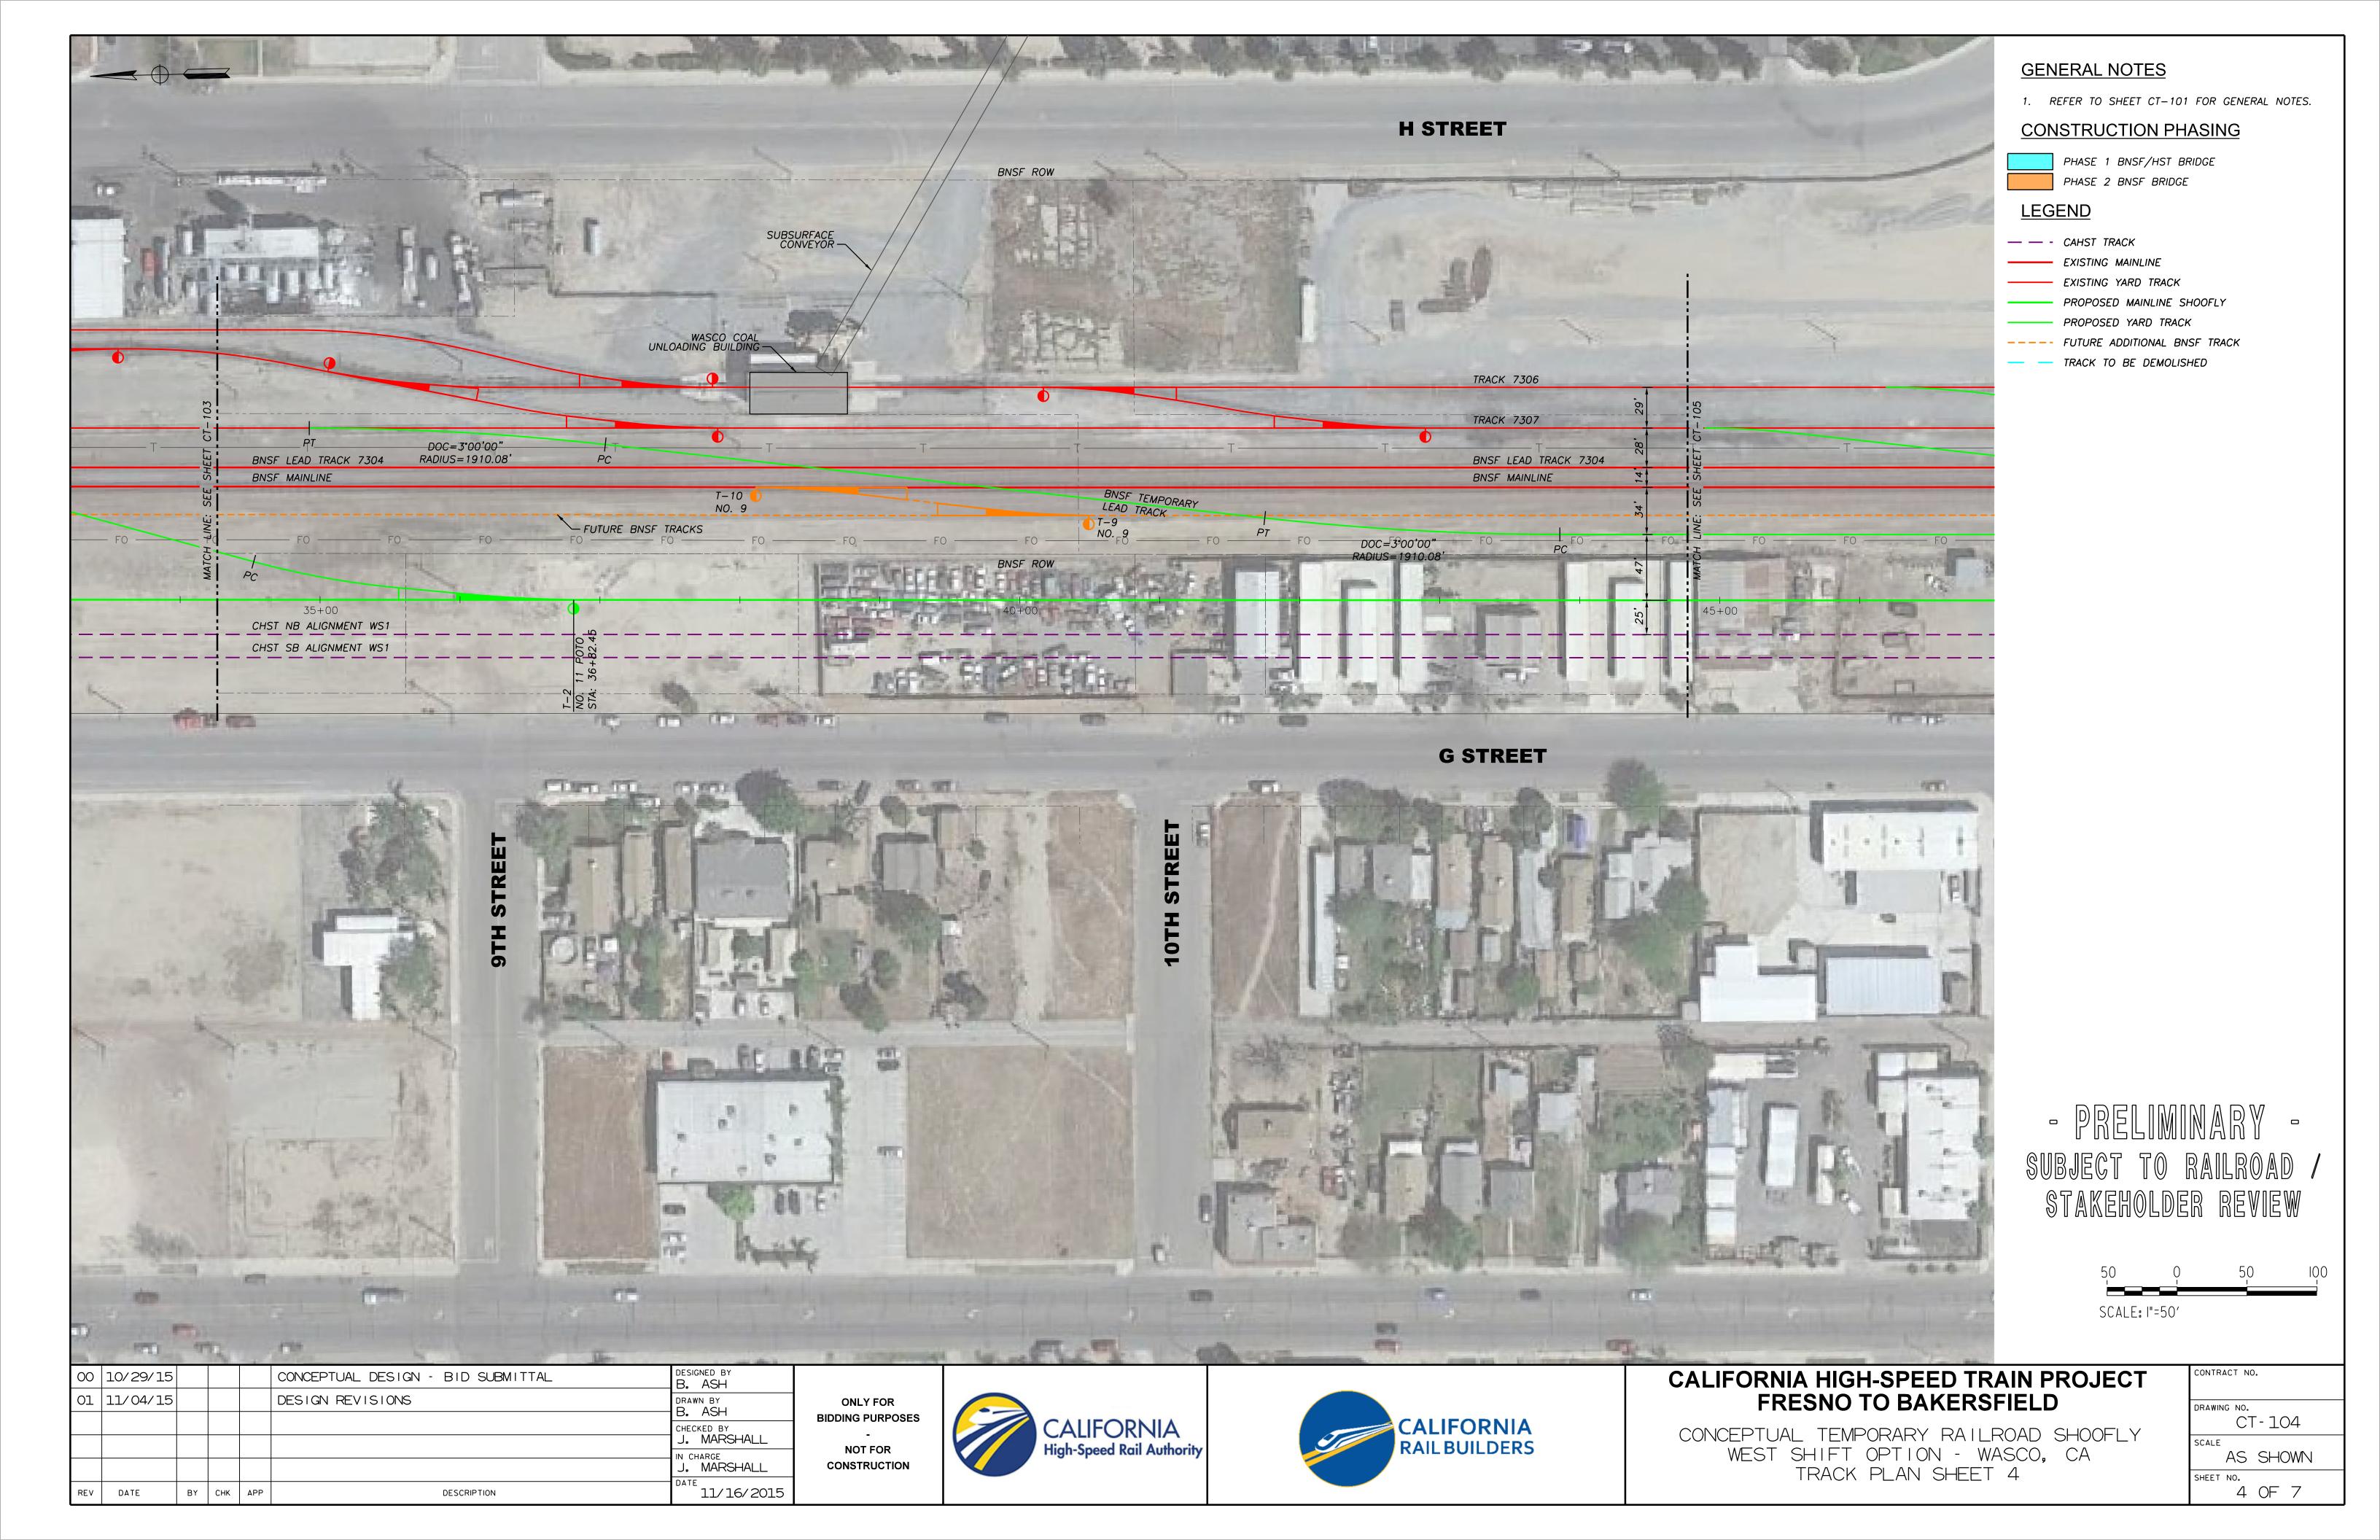

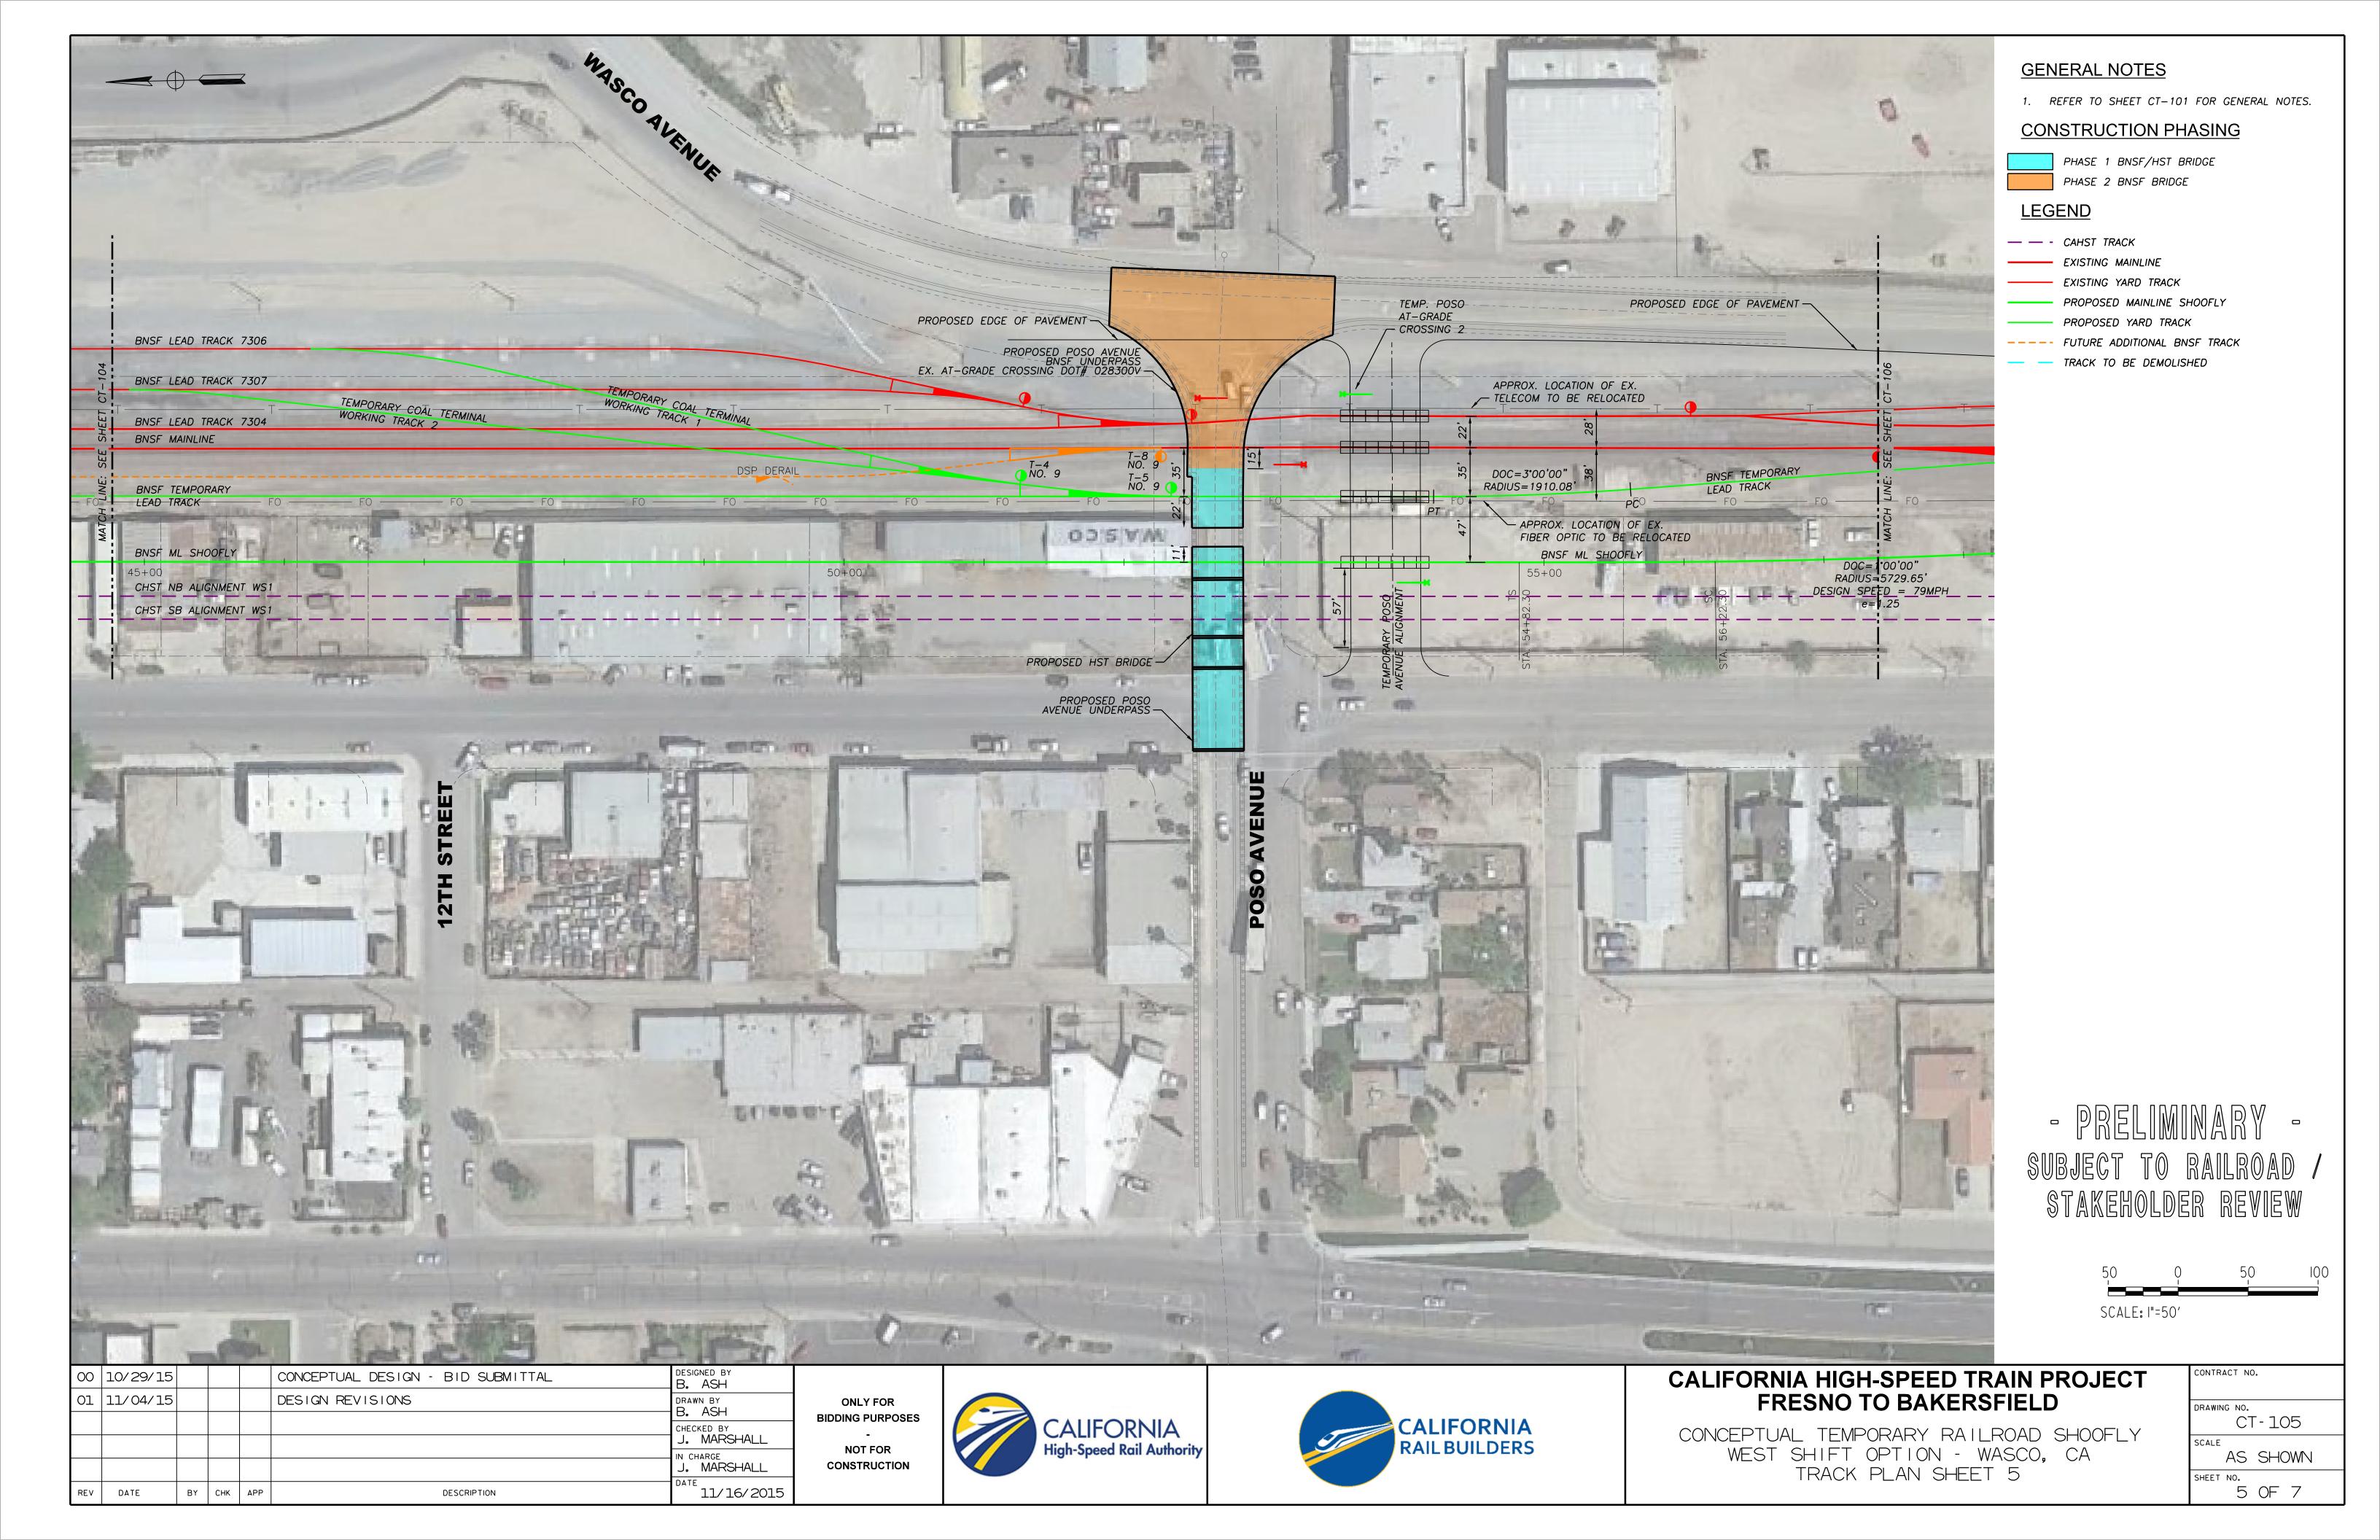

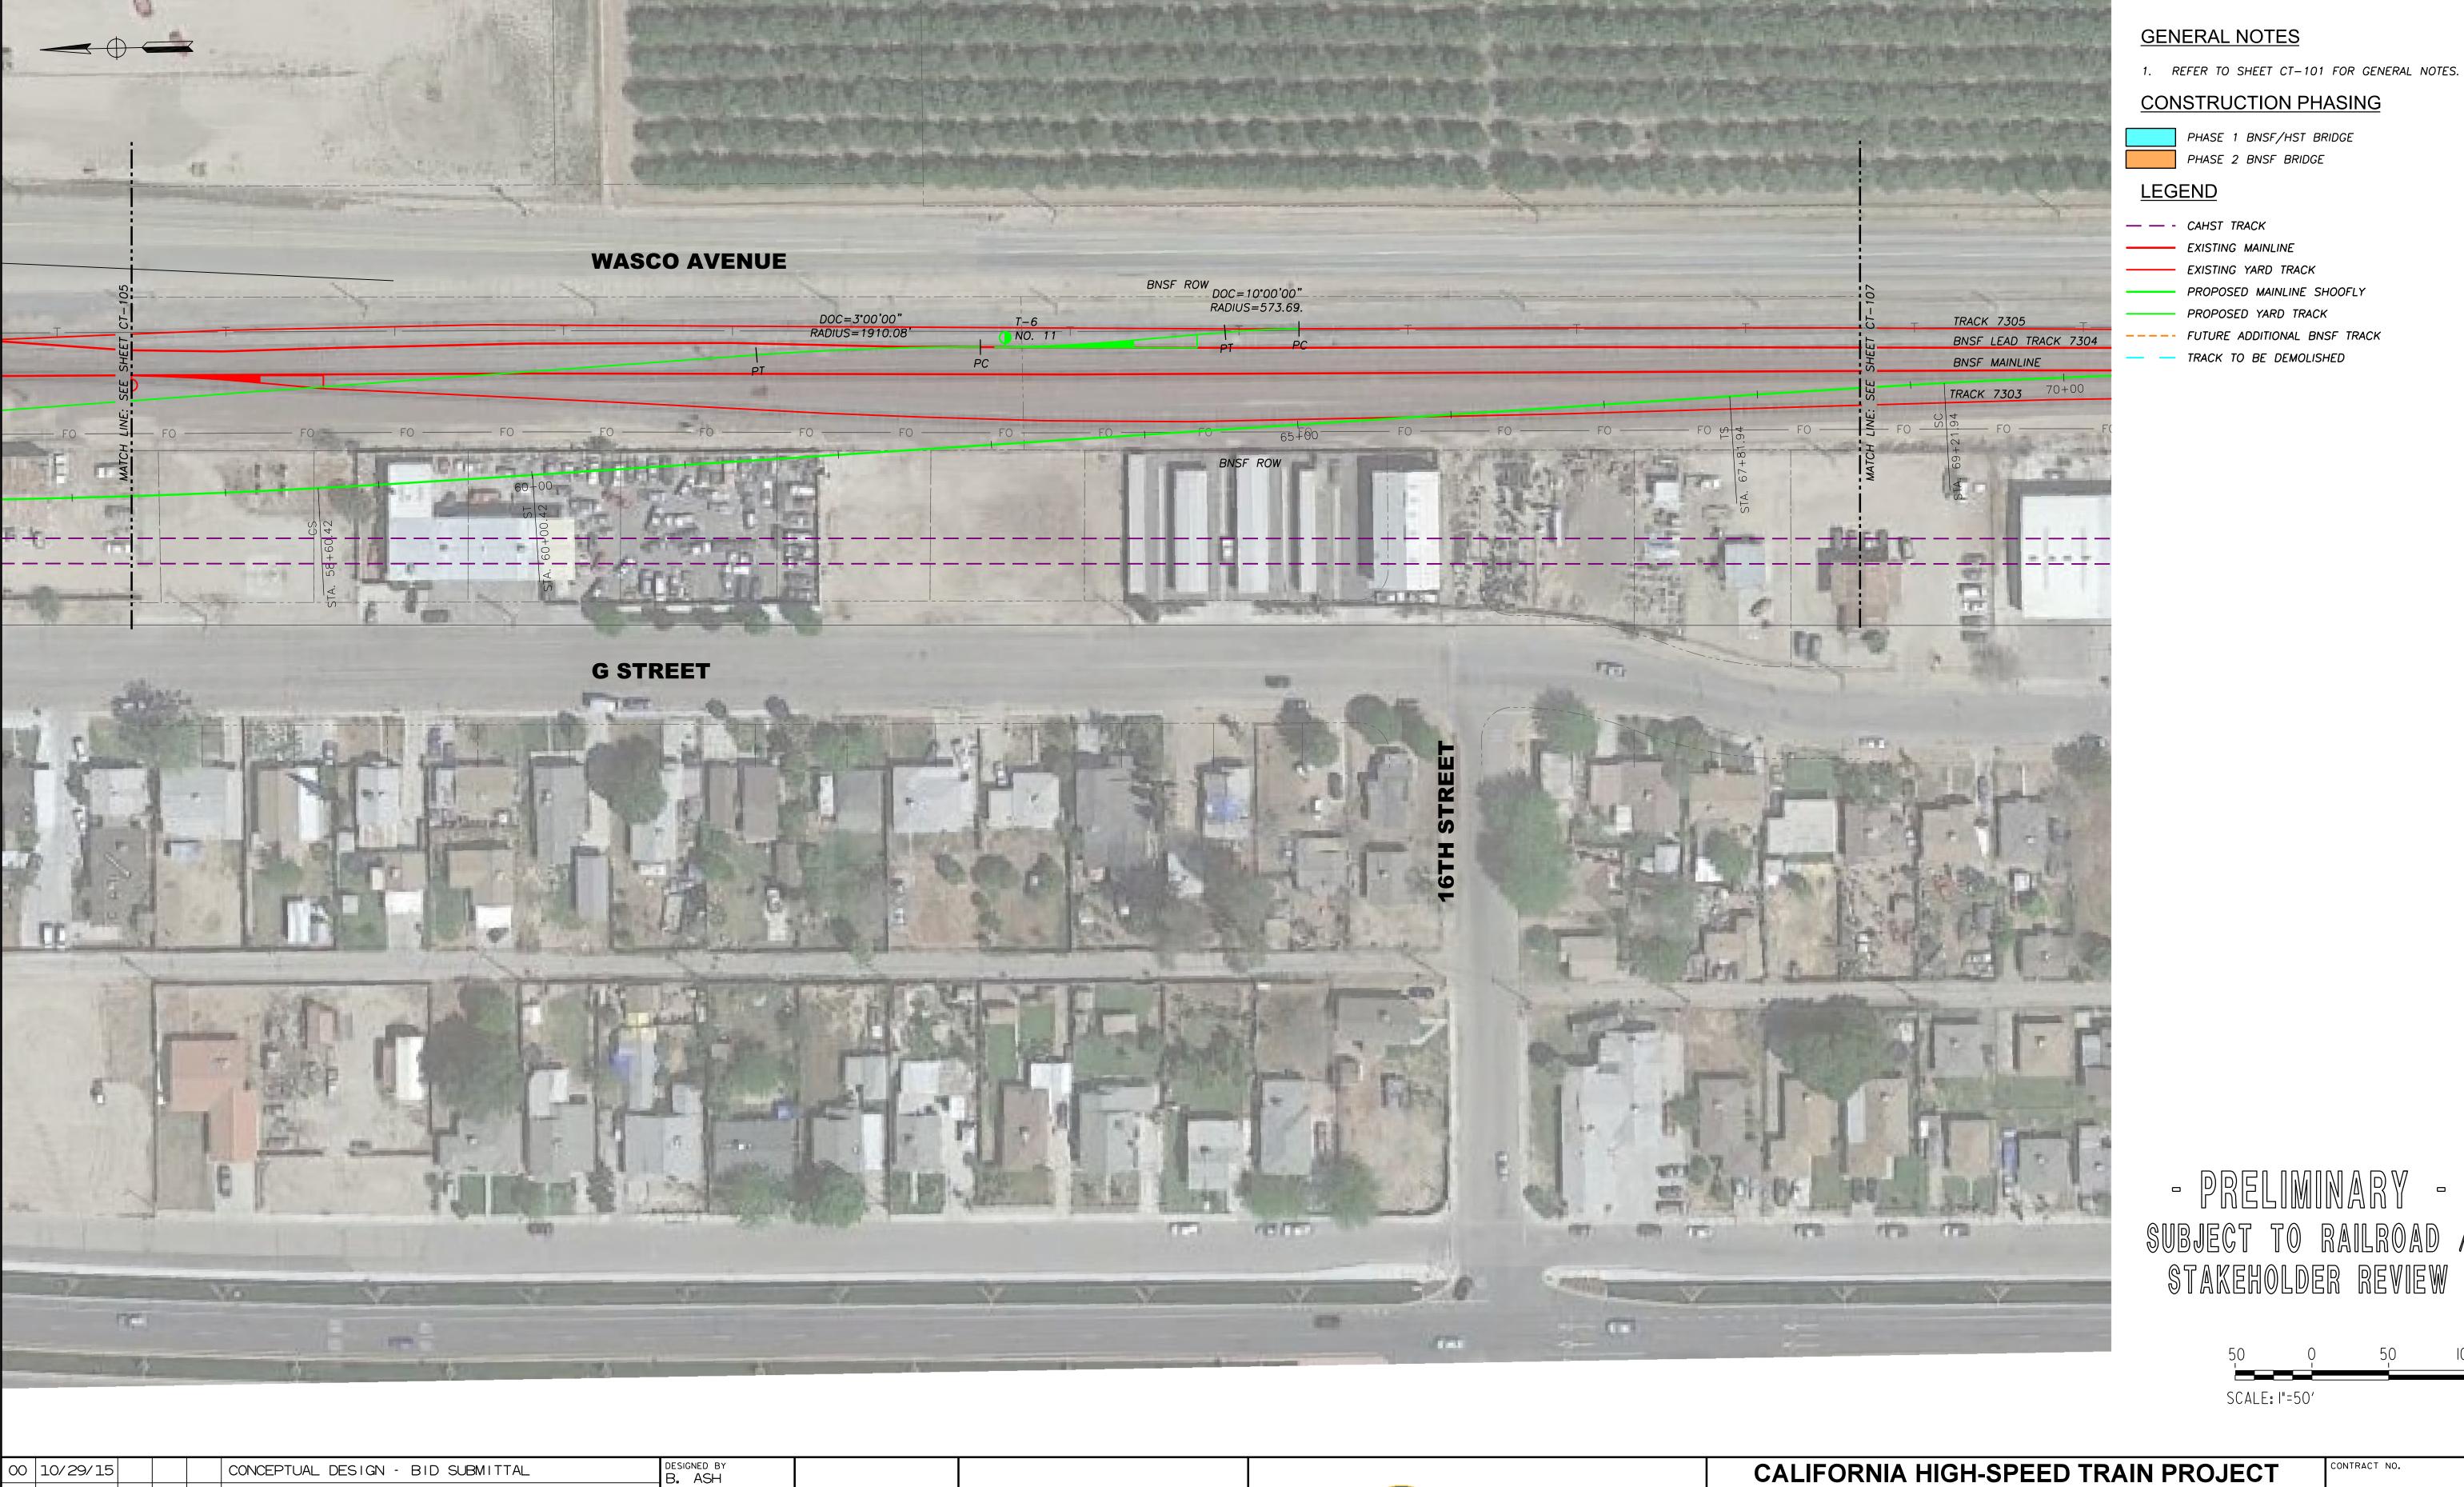

CALIFORNIA
High-Speed Rail Authority

01 | 11/04/15 |

BY CHK APP

DESIGN REVISIONS

DESCRIPTION

DRAWN BY B. ASH

CHECKED BY

J. MARSHALL

IN CHARGE
J. MARSHALL

11/16/2015

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NOT FOR

CONSTRUCTION

CALIFORNIA HIGH-SPEED TRAIN PROJEC
FRESNO TO BAKERSFIELD

CALIFORNIA RAIL BUILDERS

CONCEPTUAL TEMPORARY RAILROAD SHOOFLY WEST SHIFT OPTION - WASCO, CA TRACK PLAN SHEET 6

CONTRACT NO.						
DRAWING NO. CT-106						
scale AS SHOWN						
SHEET NO. 6 OF 7						



1. REFER TO SHEET CT-101 FOR GENERAL NOTES.

## **CONSTRUCTION PHASING**

PHASE 1 BNSF/HST BRIDGE PHASE 2 BNSF BRIDGE

**LEGEND** 

— — - CAHST TRACK

EXISTING MAINLINE


- EXISTING YARD TRACK

- PROPOSED MAINLINE SHOOFLY

--- PROPOSED YARD TRACK

- TRACK TO BE DEMOLISHED

SUBJECT TO RAILROAD / STAKEHOLDER REVIEW

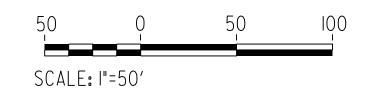

00	10/29/15				CONCEPTUAL DESIGN - BID SUBMITTAL	DESIGNED BY B. ASH
01	11/04/15				DESIGN REVISIONS	DRAWN BY B. ASH
						CHECKED BY J. MARSHALL
						IN CHARGE J. MARSHALL
REV	DATE	BY	СНК	APP	DESCRIPTION	DATE 11/16/2015

**ONLY FOR BIDDING PURPOSES** NOT FOR CONSTRUCTION





## CALIFORNIA HIGH-SPEED TRAIN PROJECT FRESNO TO BAKERSFIELD


CONCEPTUAL TEMPORARY RAILROAD SHOOFLY WEST SHIFT OPTION - WASCO, CA TRACK PLAN SHEET 7


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SHEET NO.				
7 OF 7				
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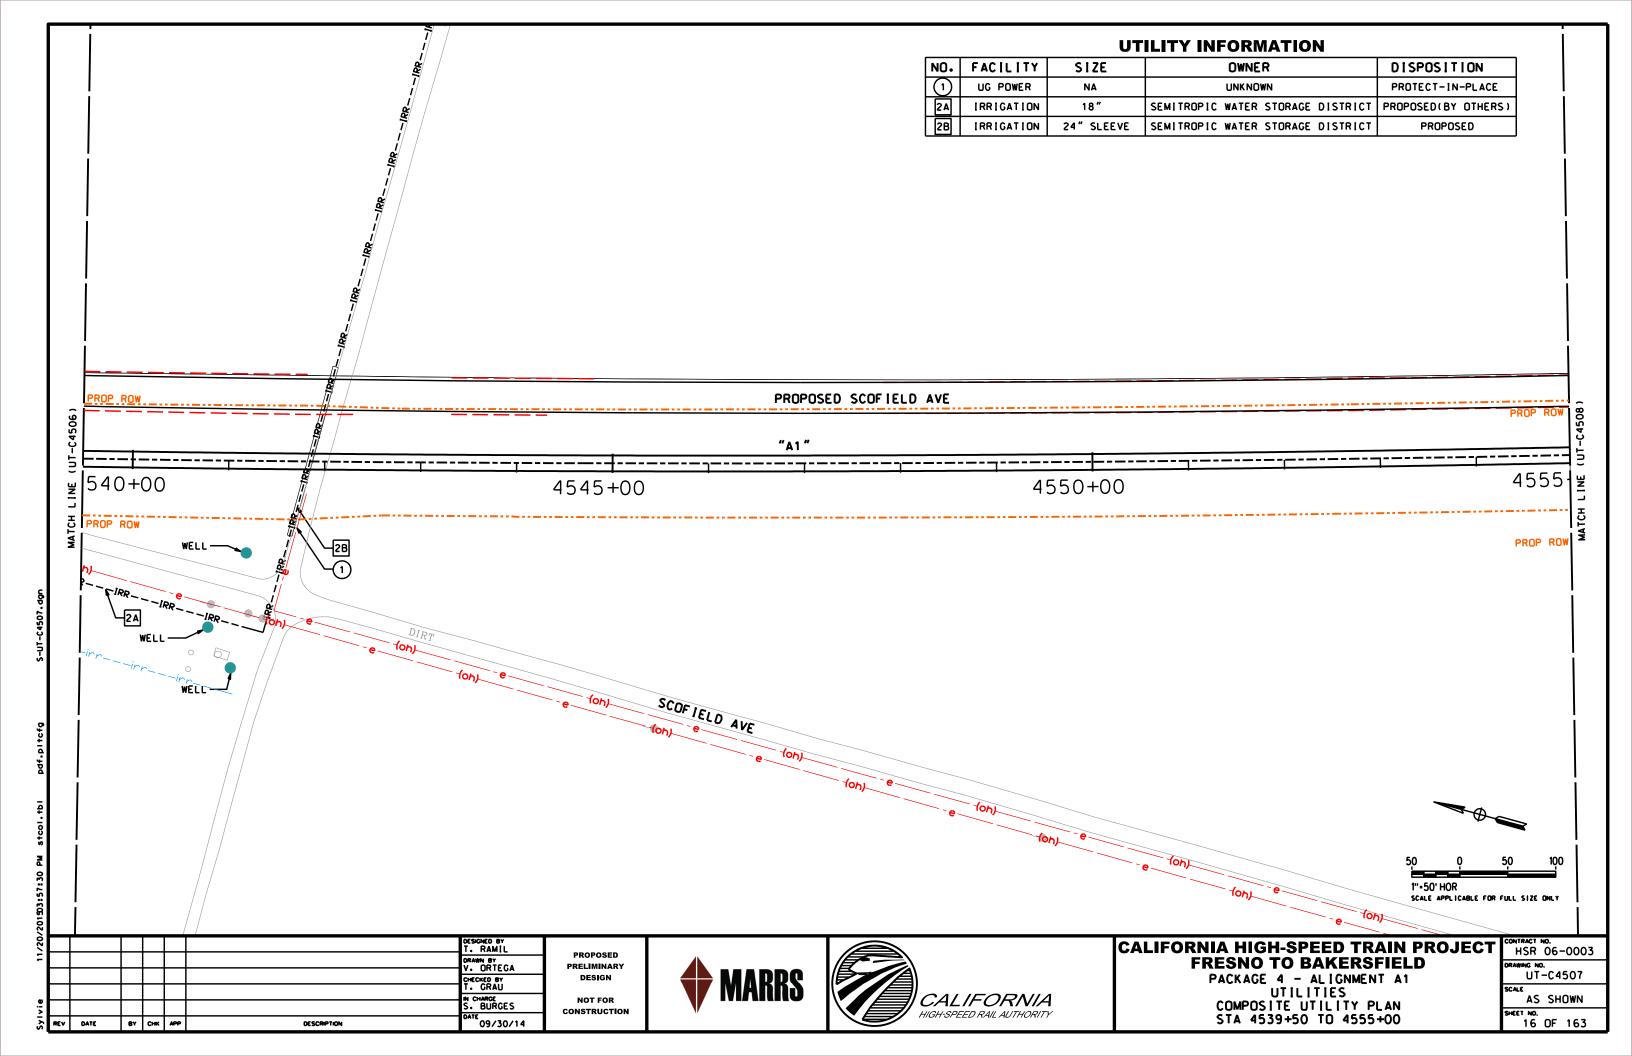
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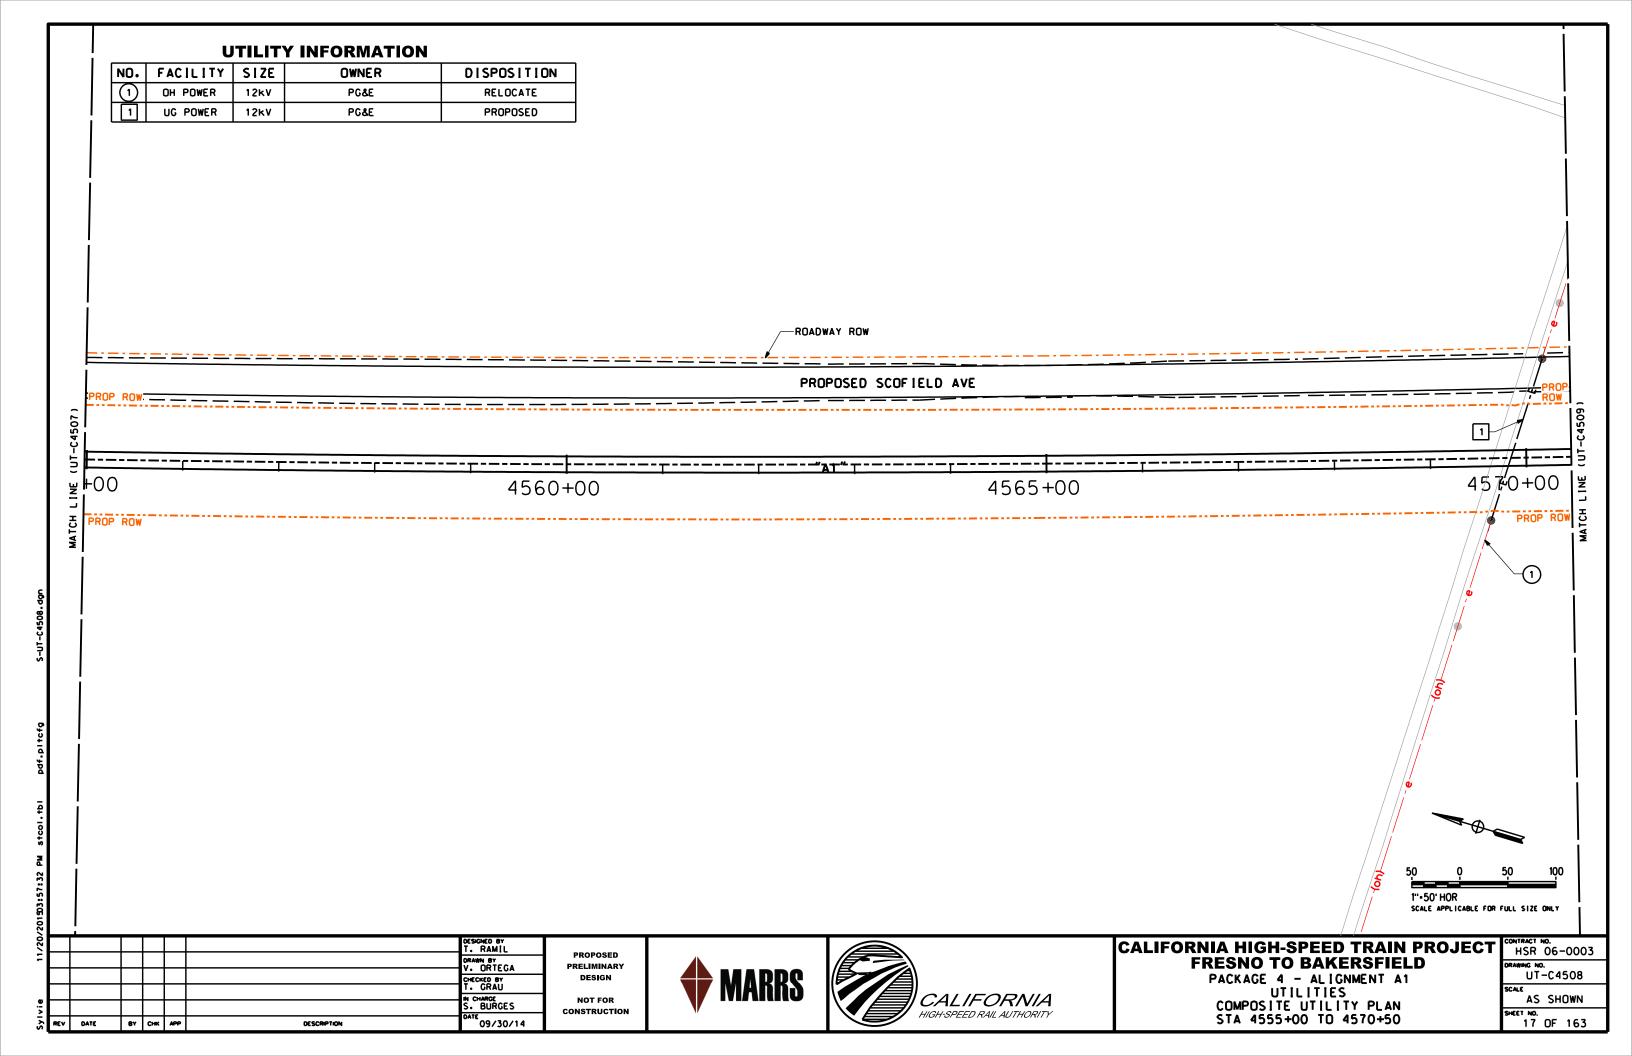



CALIFORNIA Proposals | RFP Number: HSR 14-32







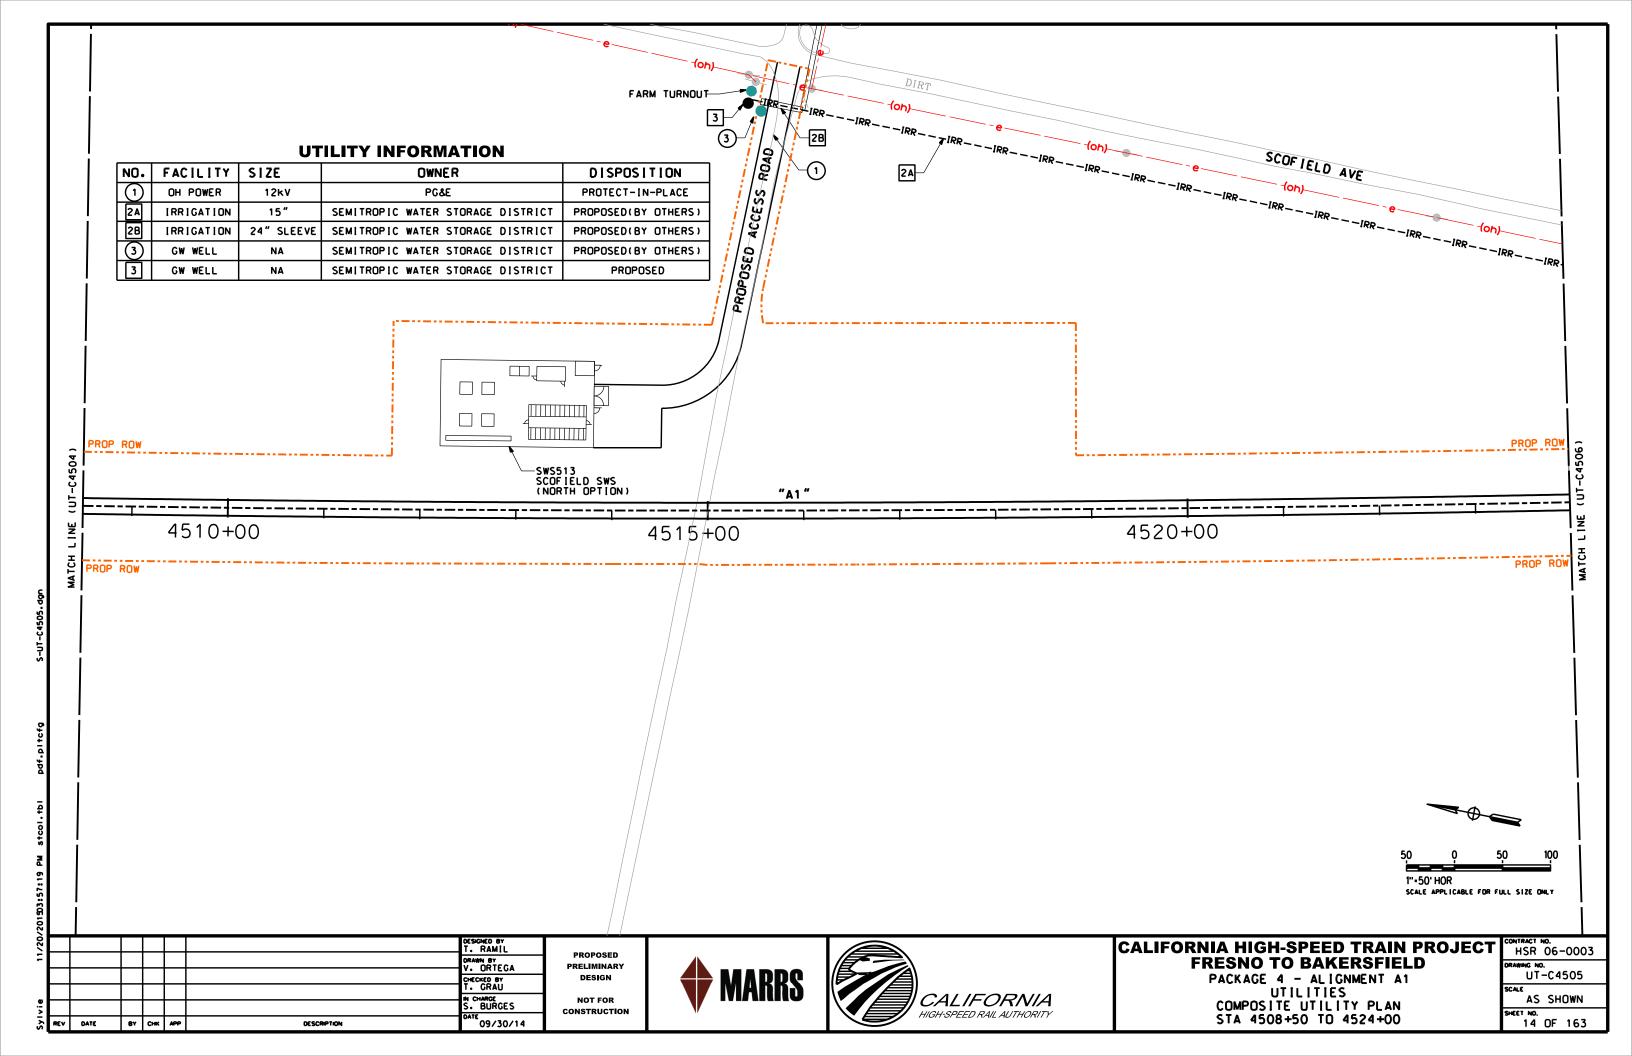


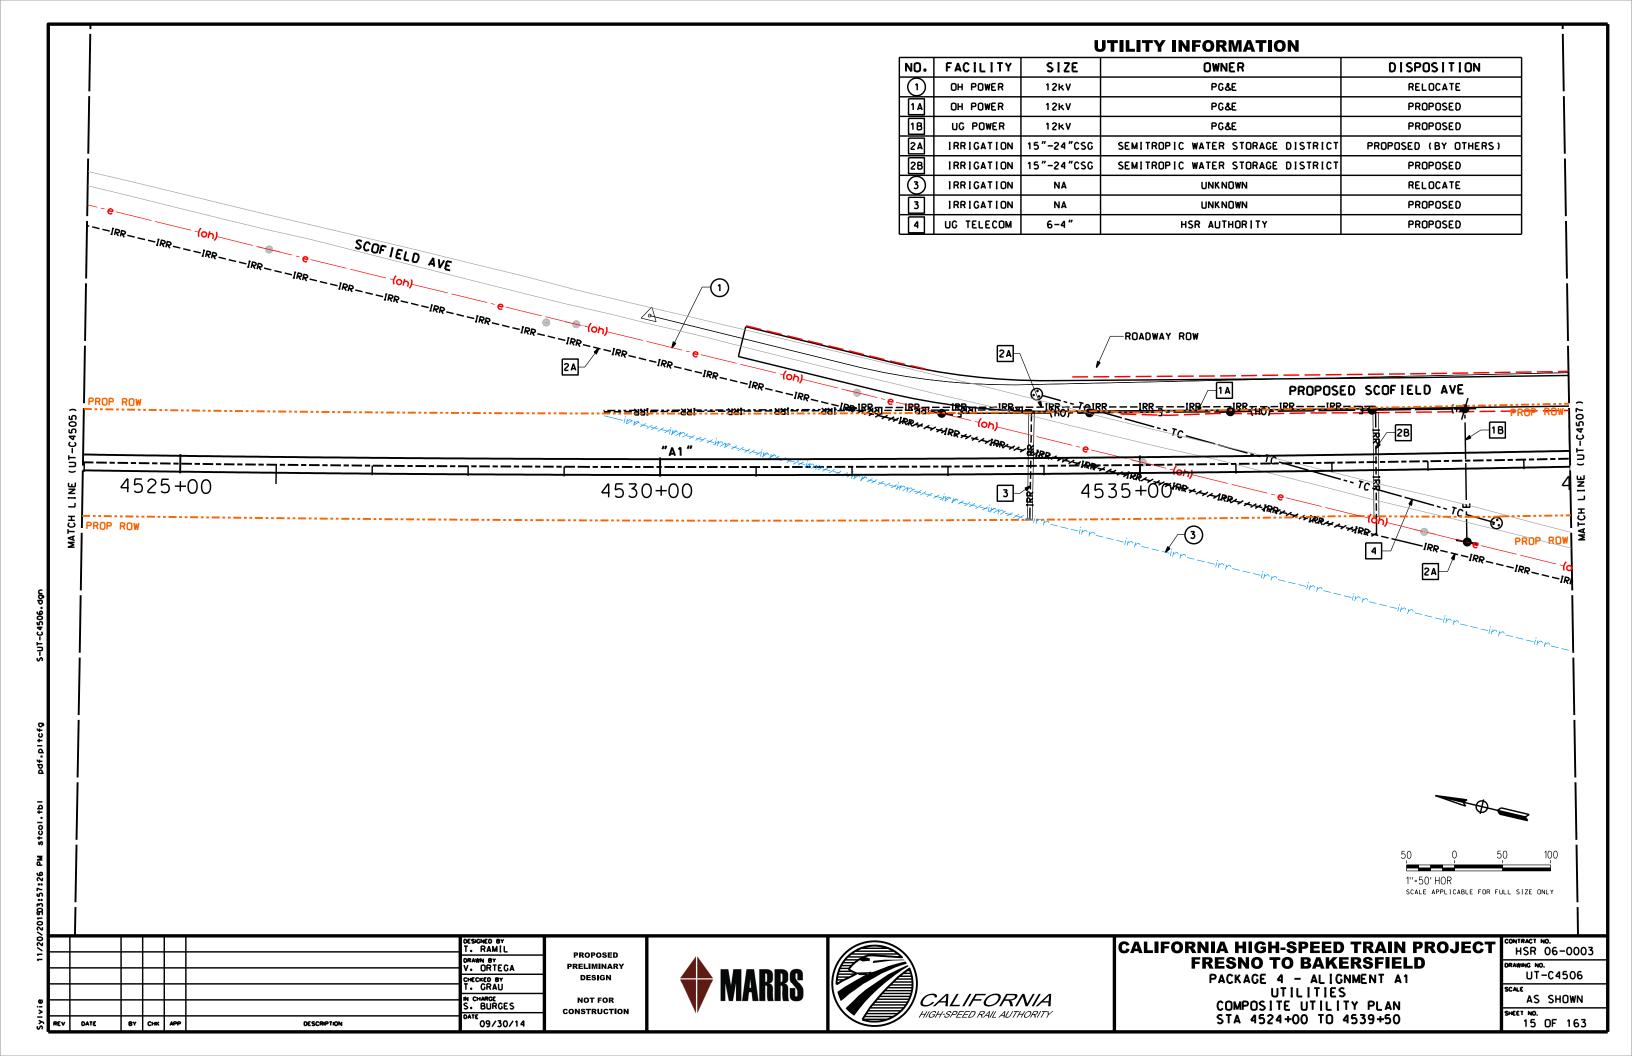


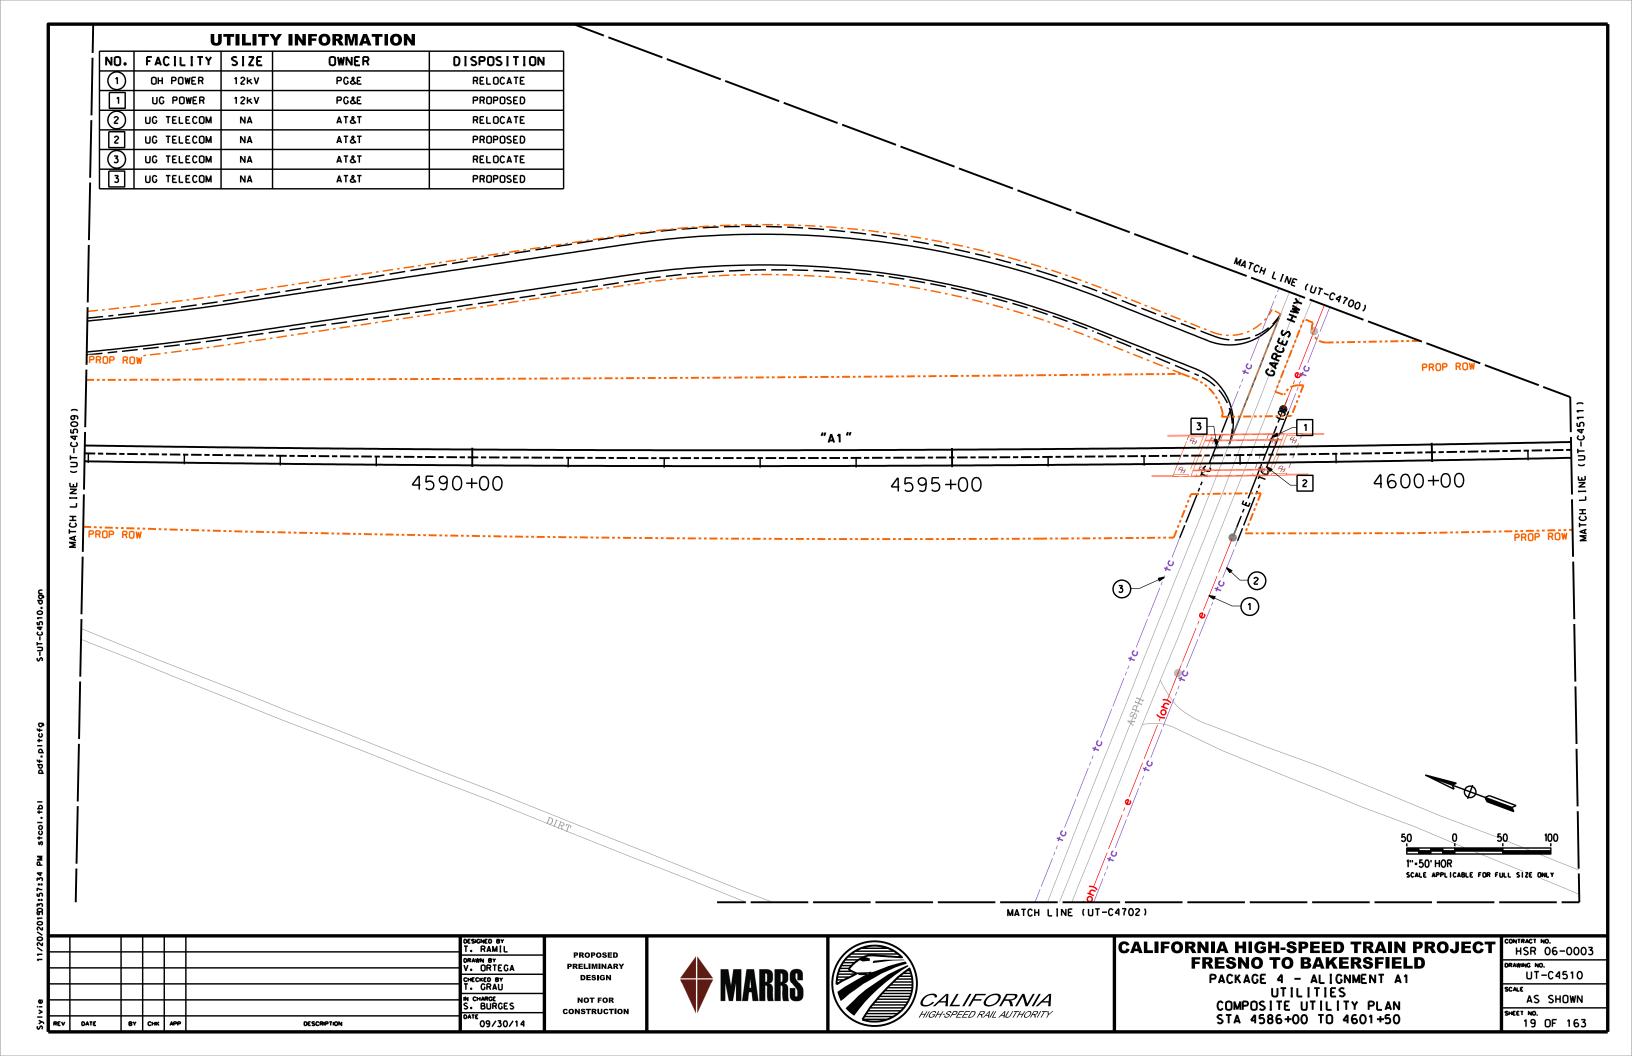


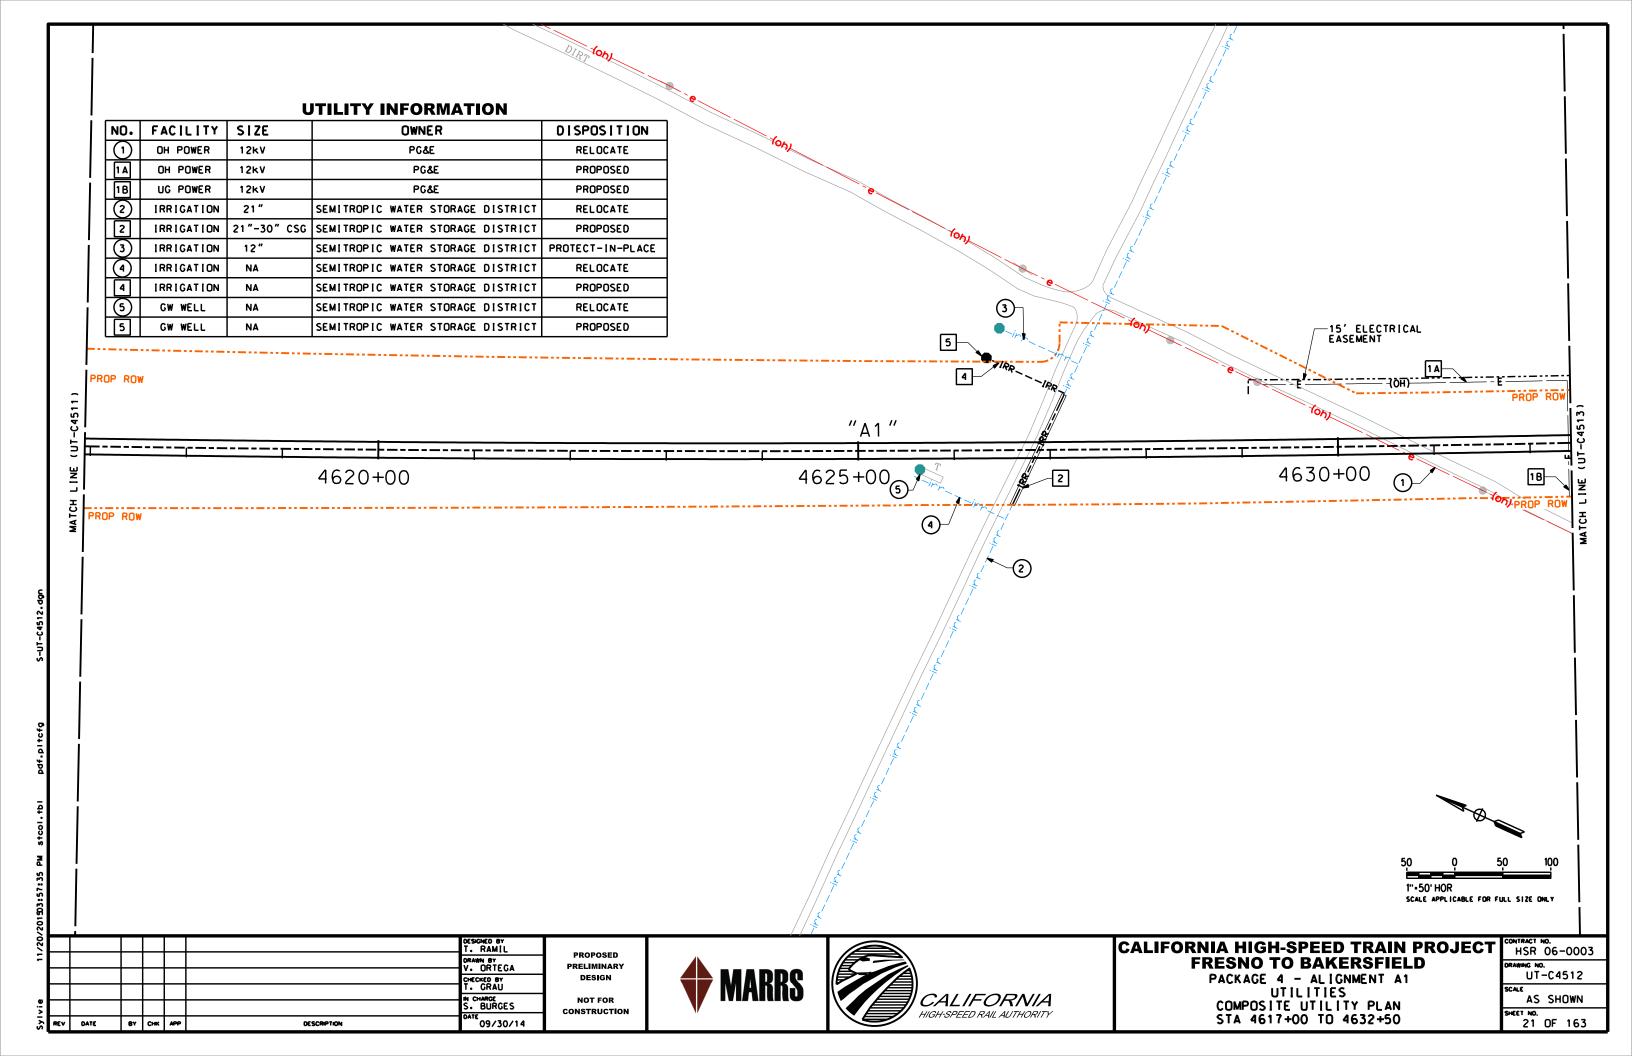


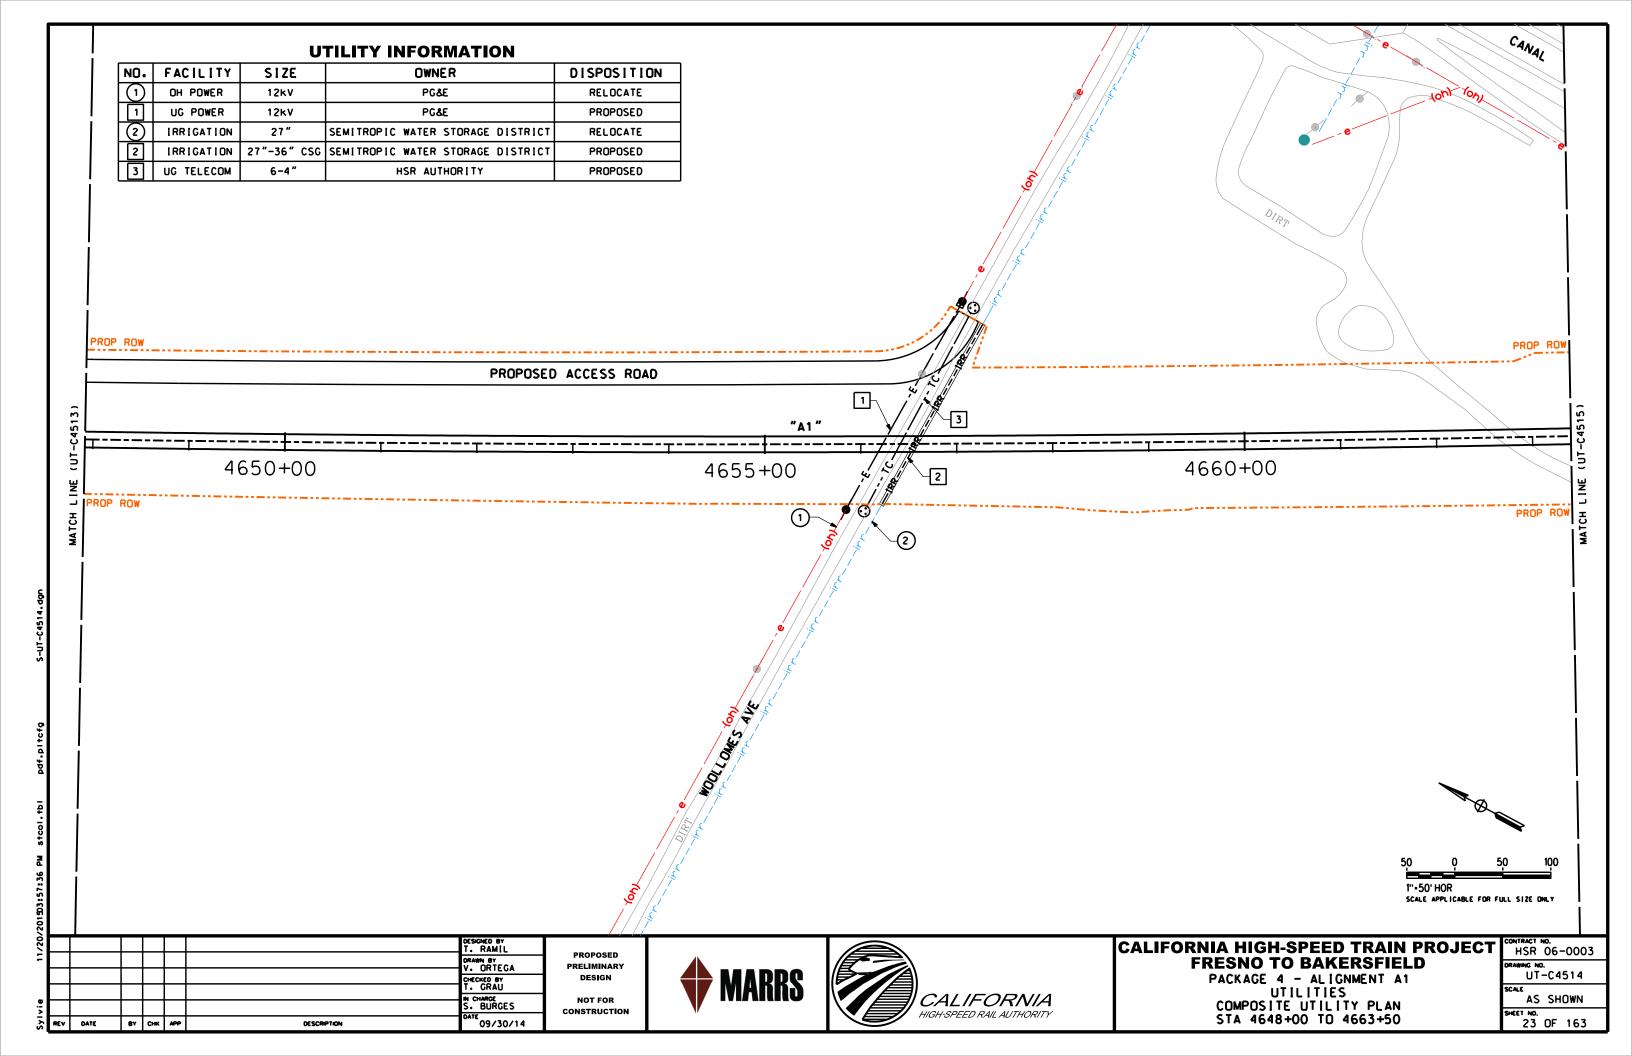


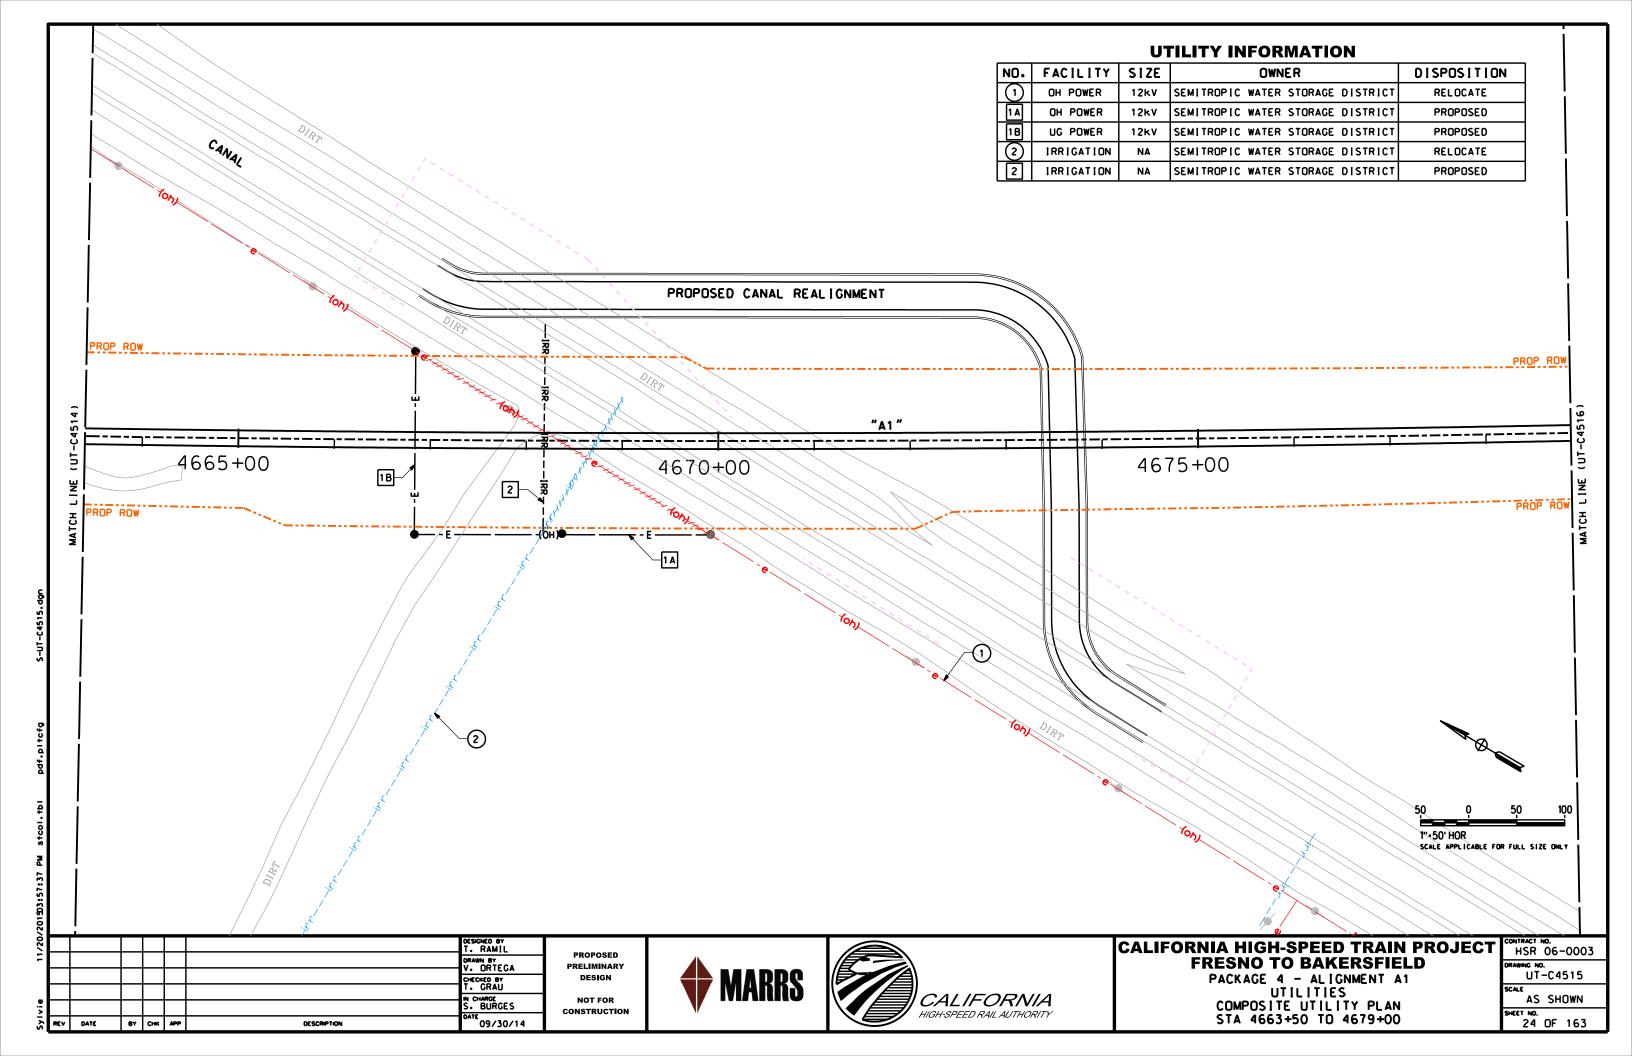


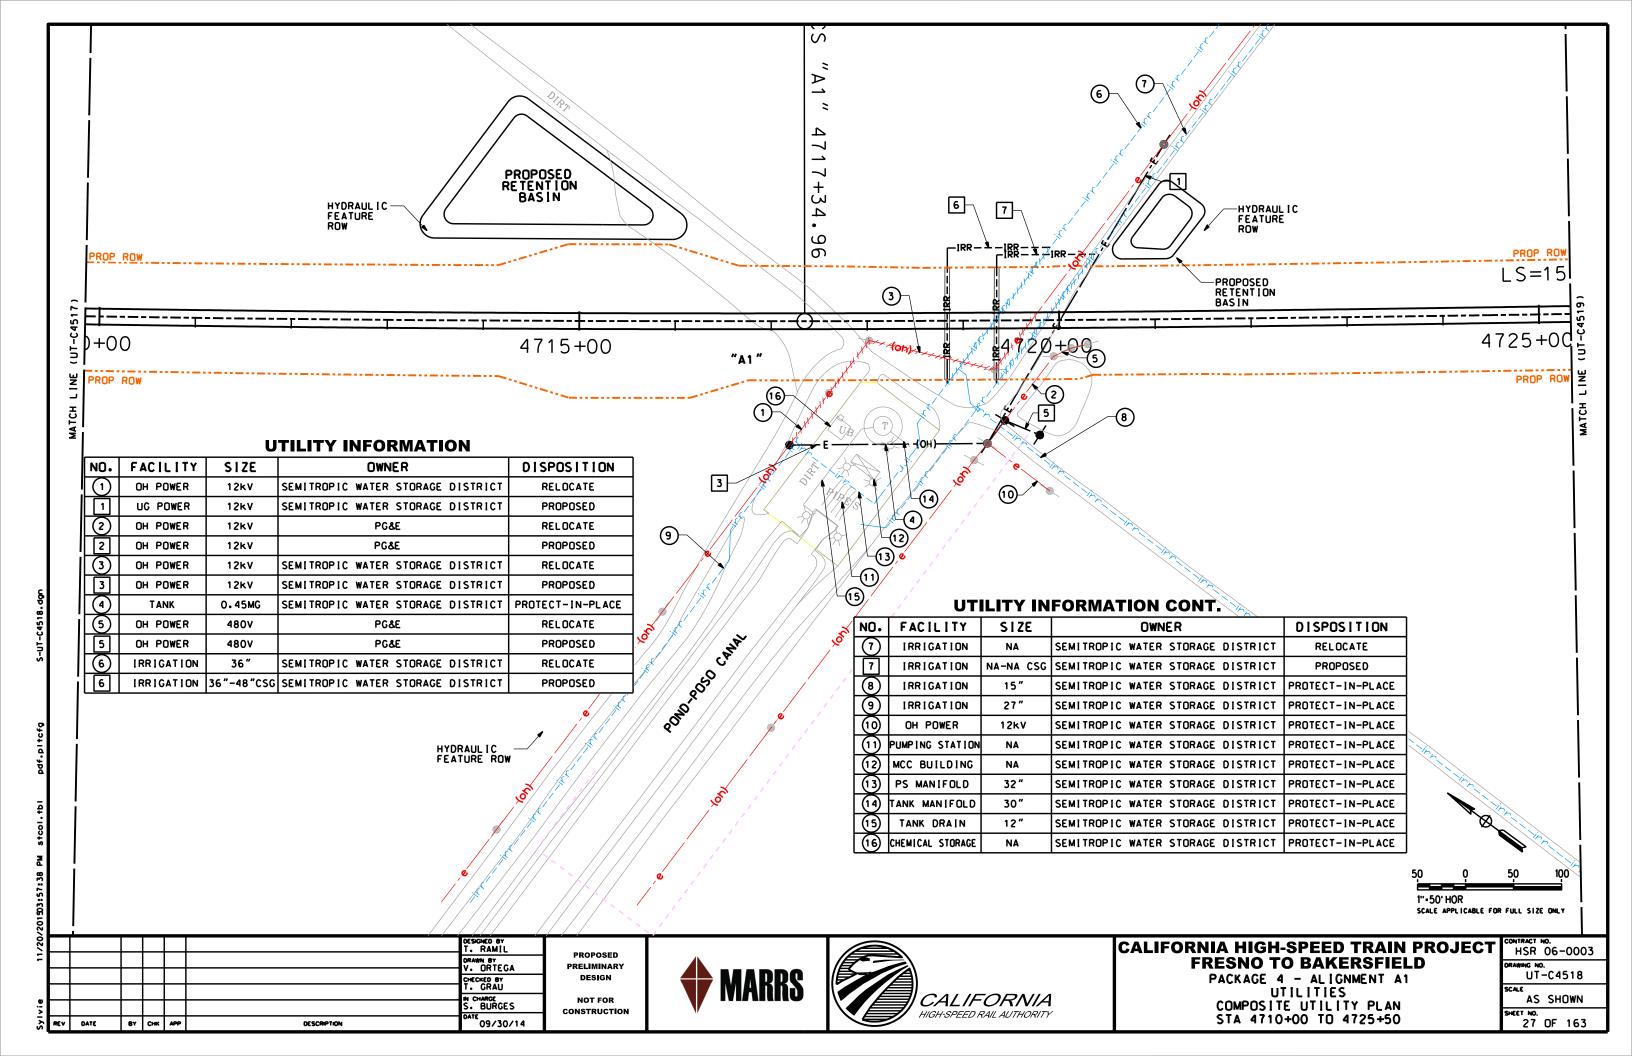


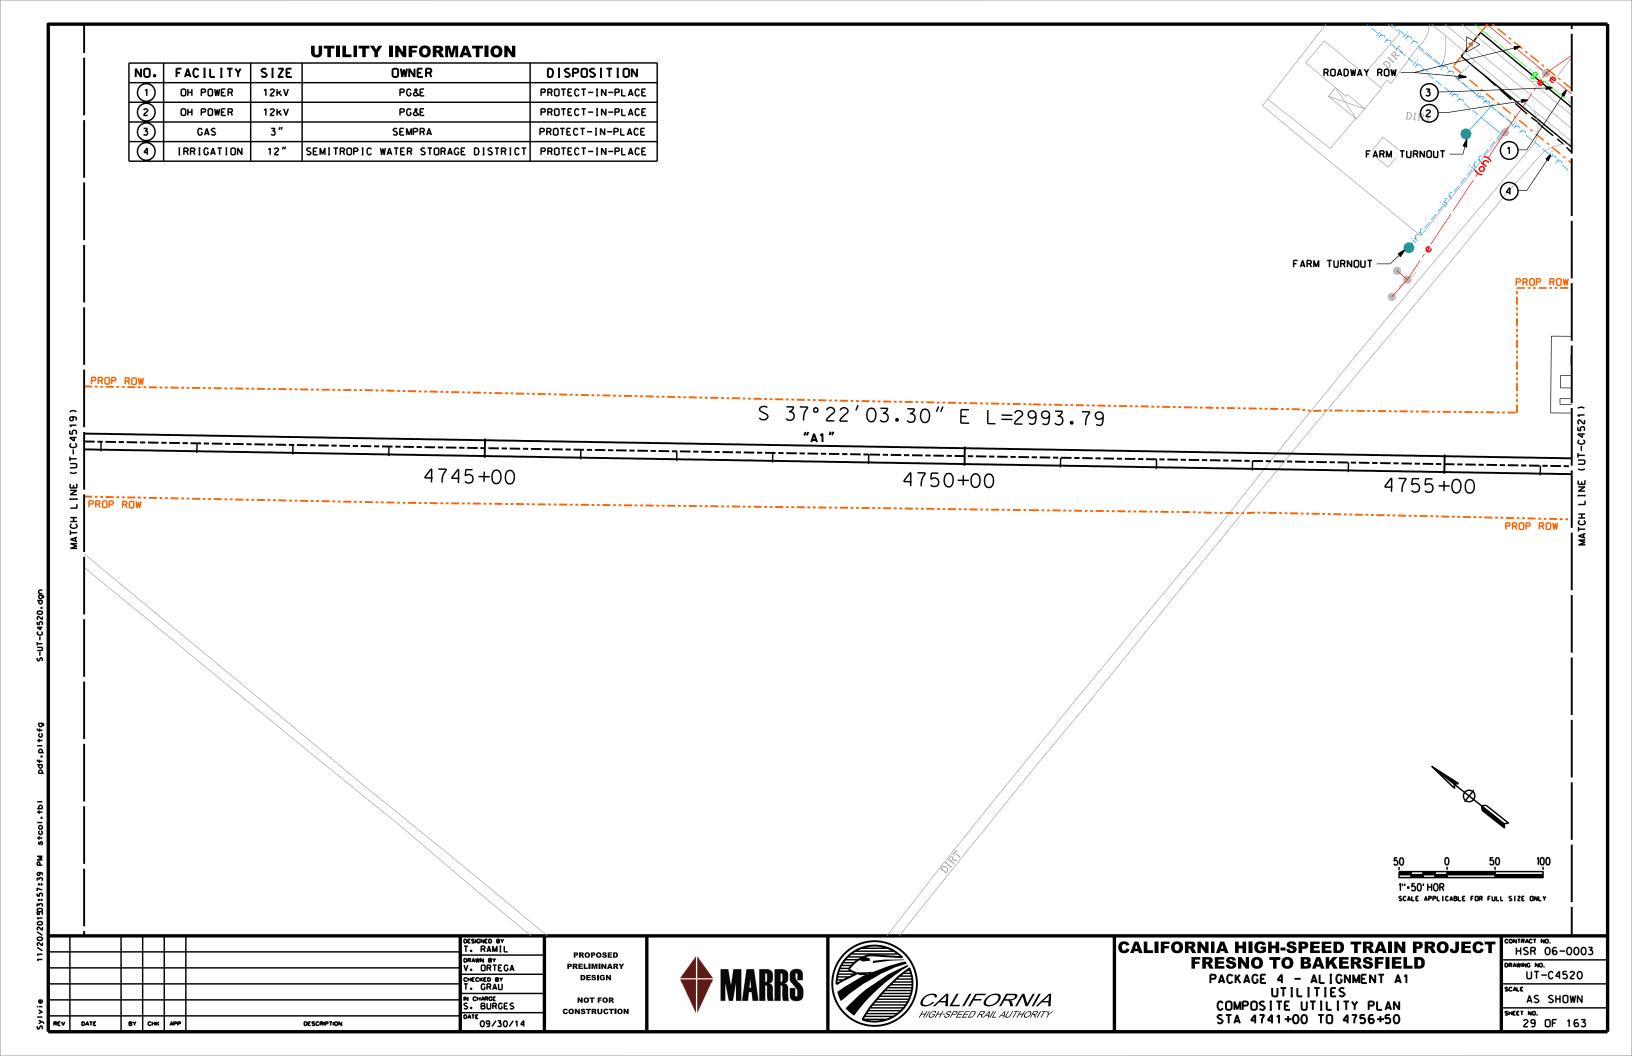


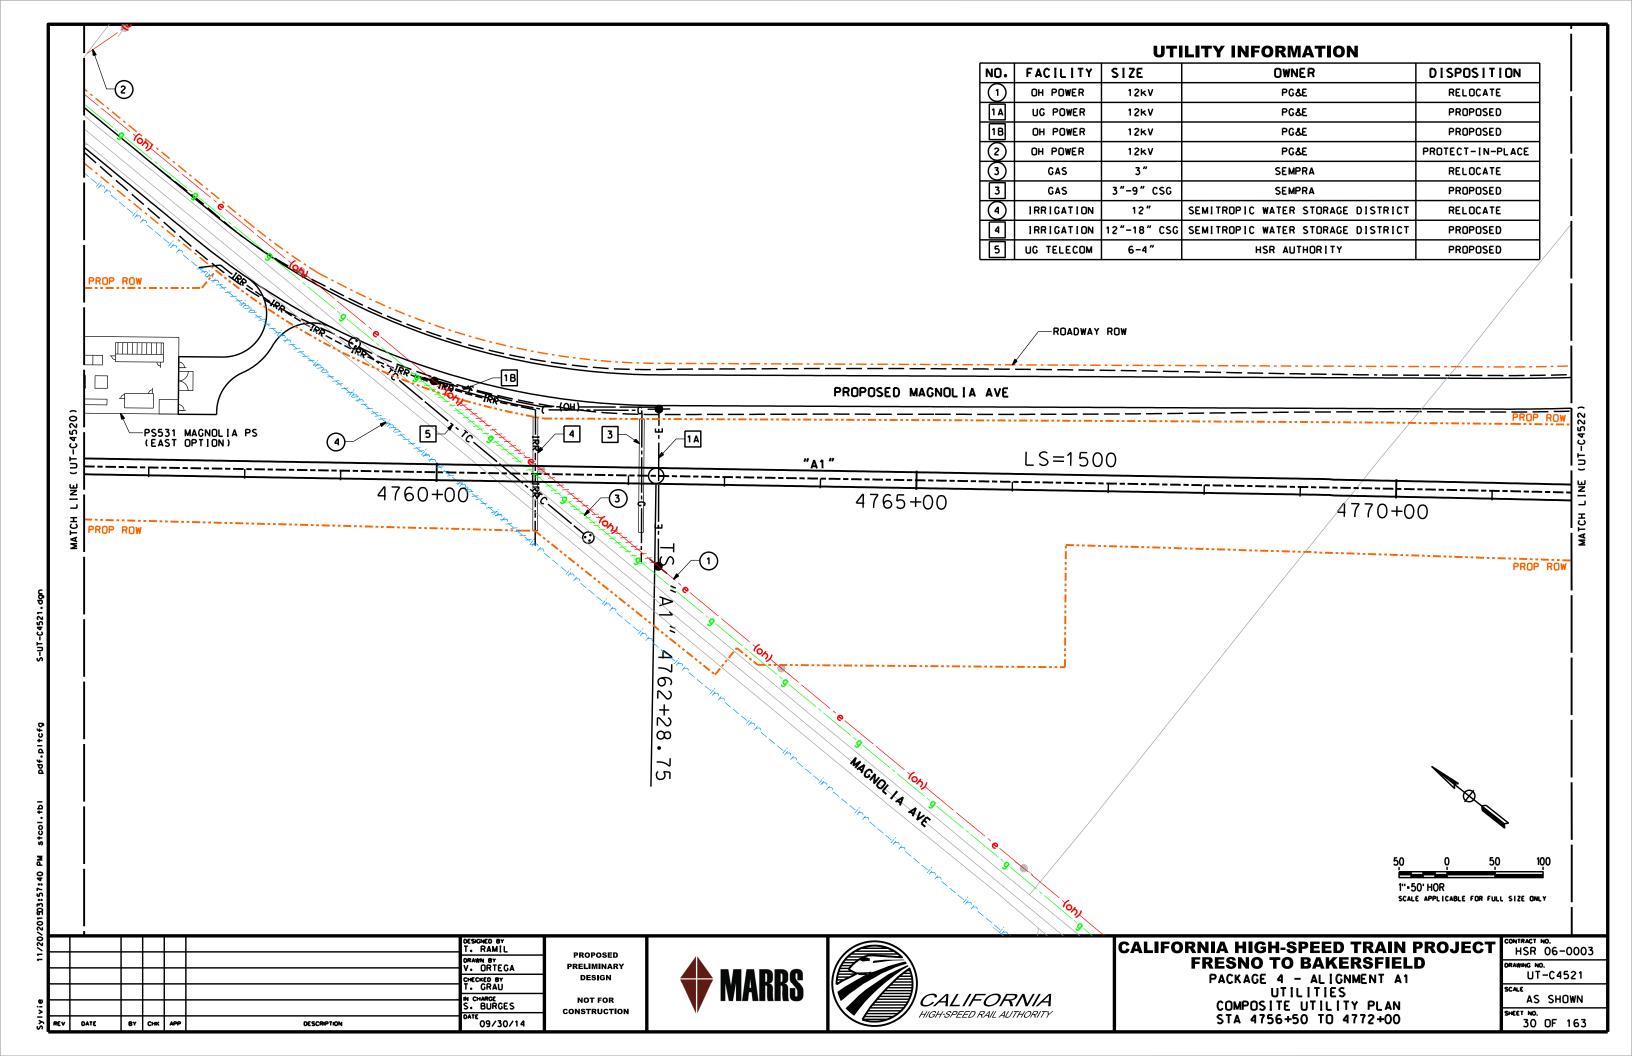


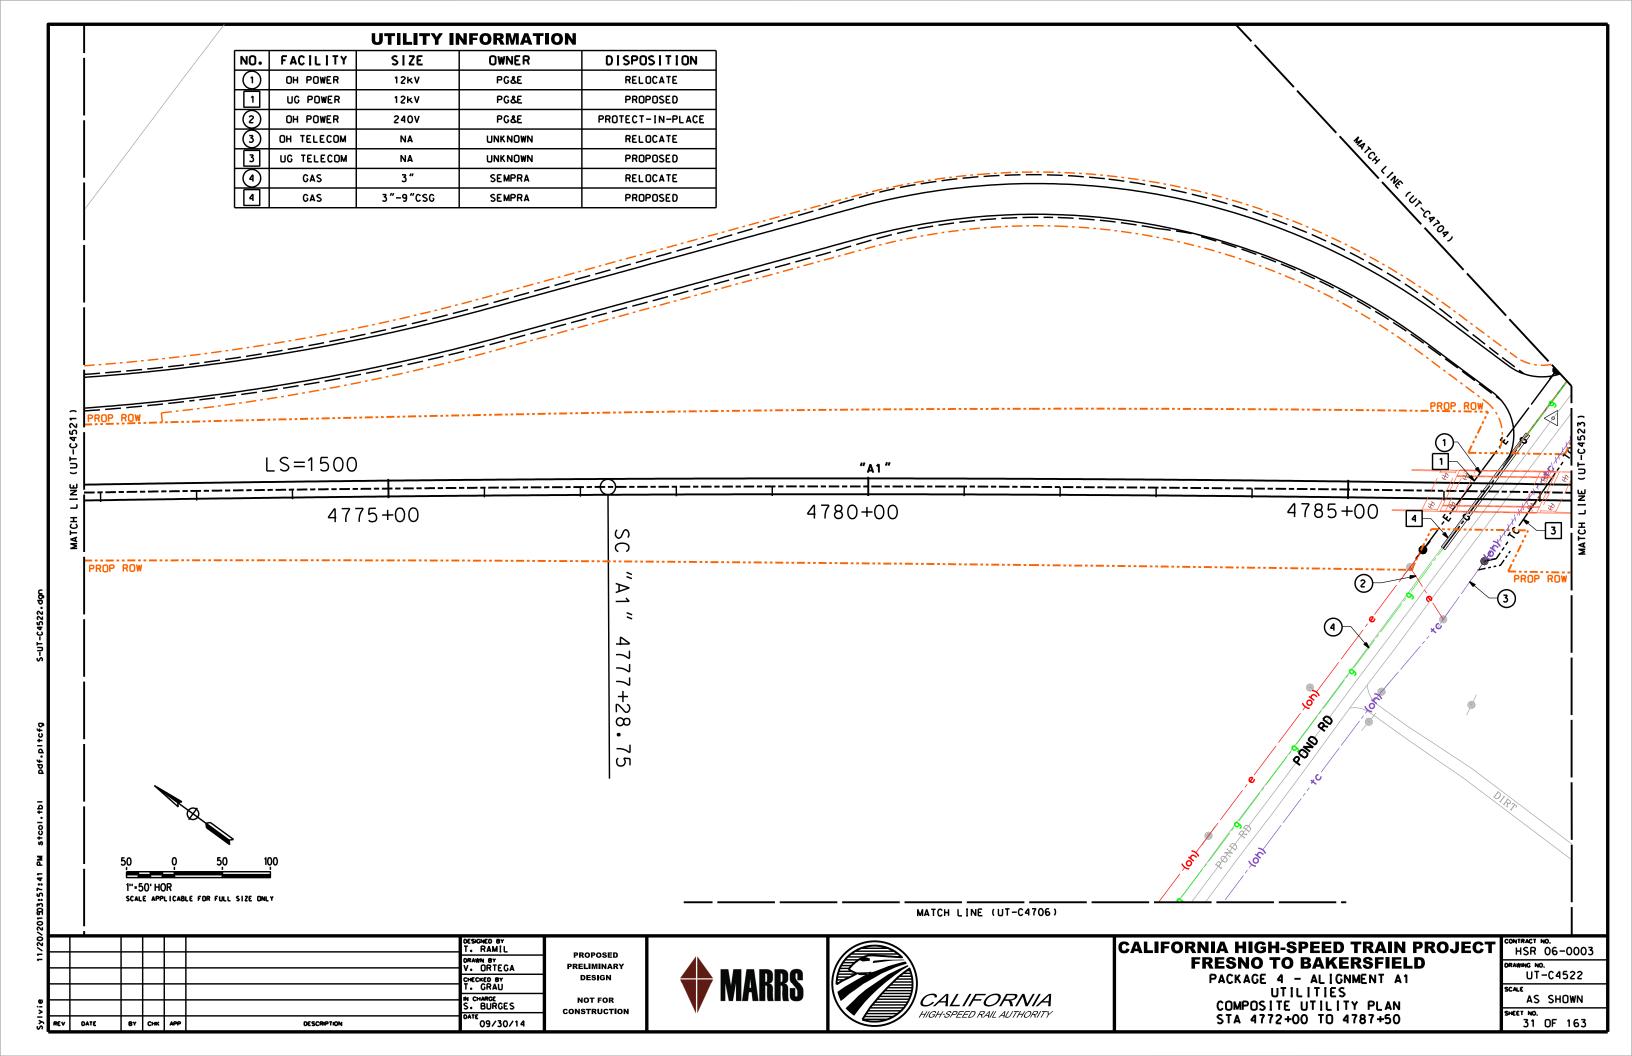


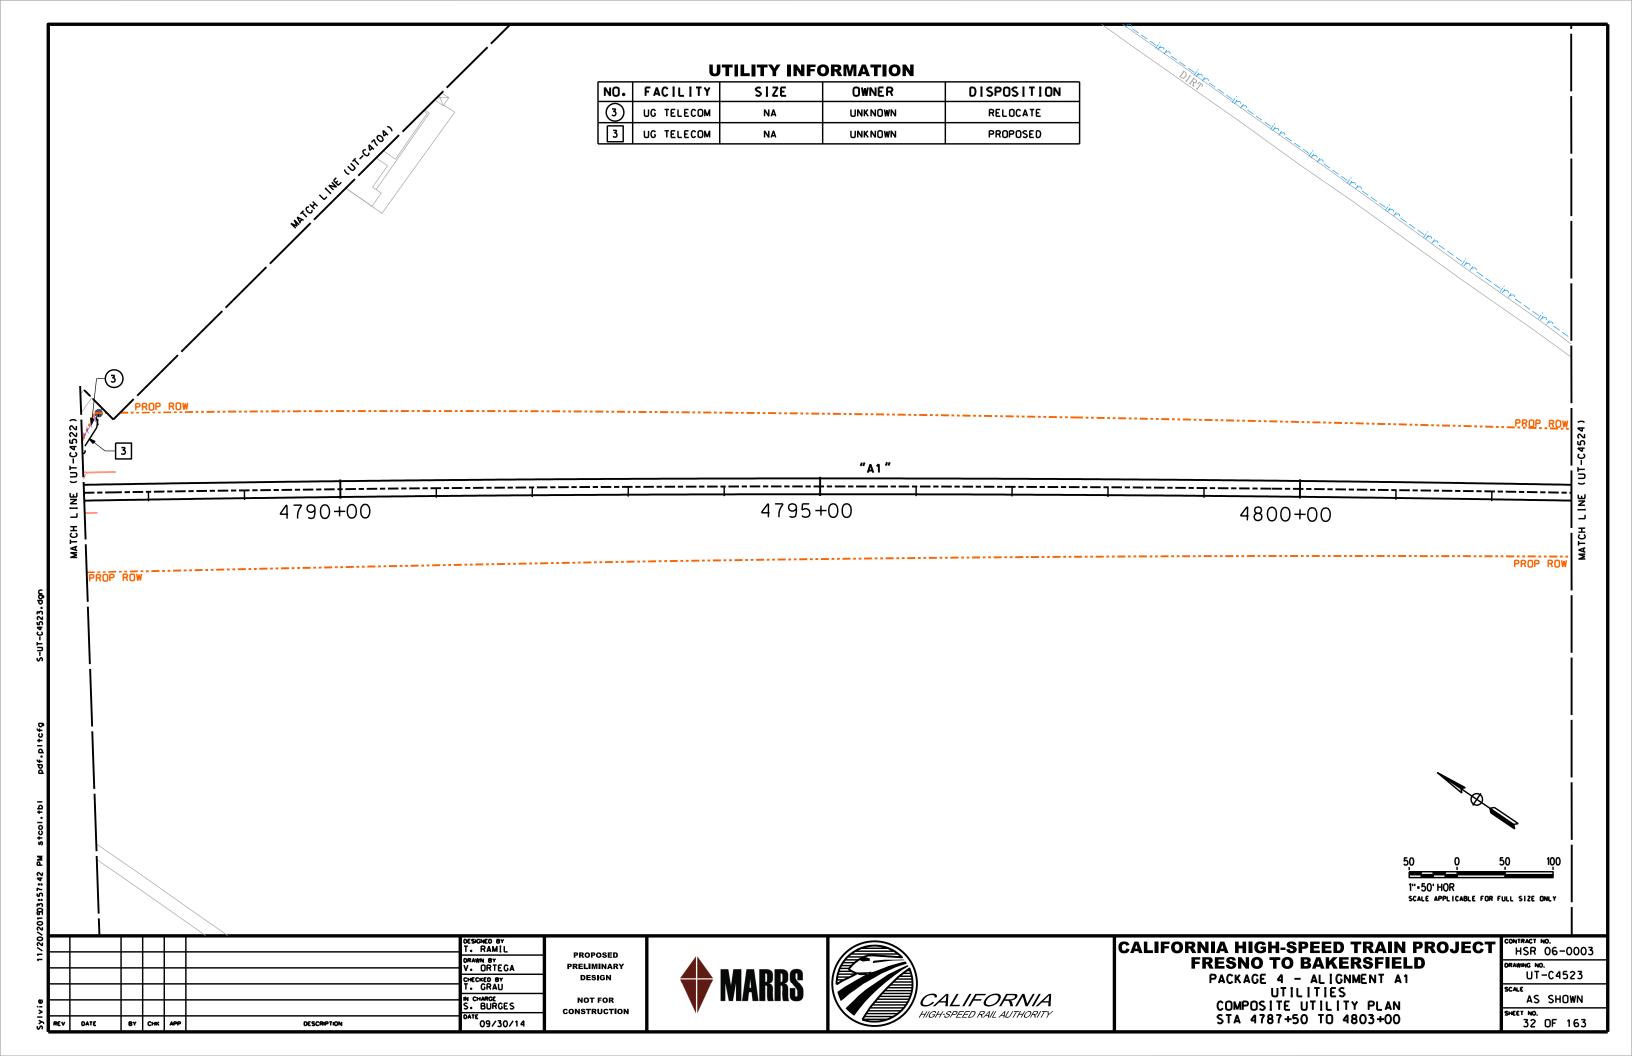


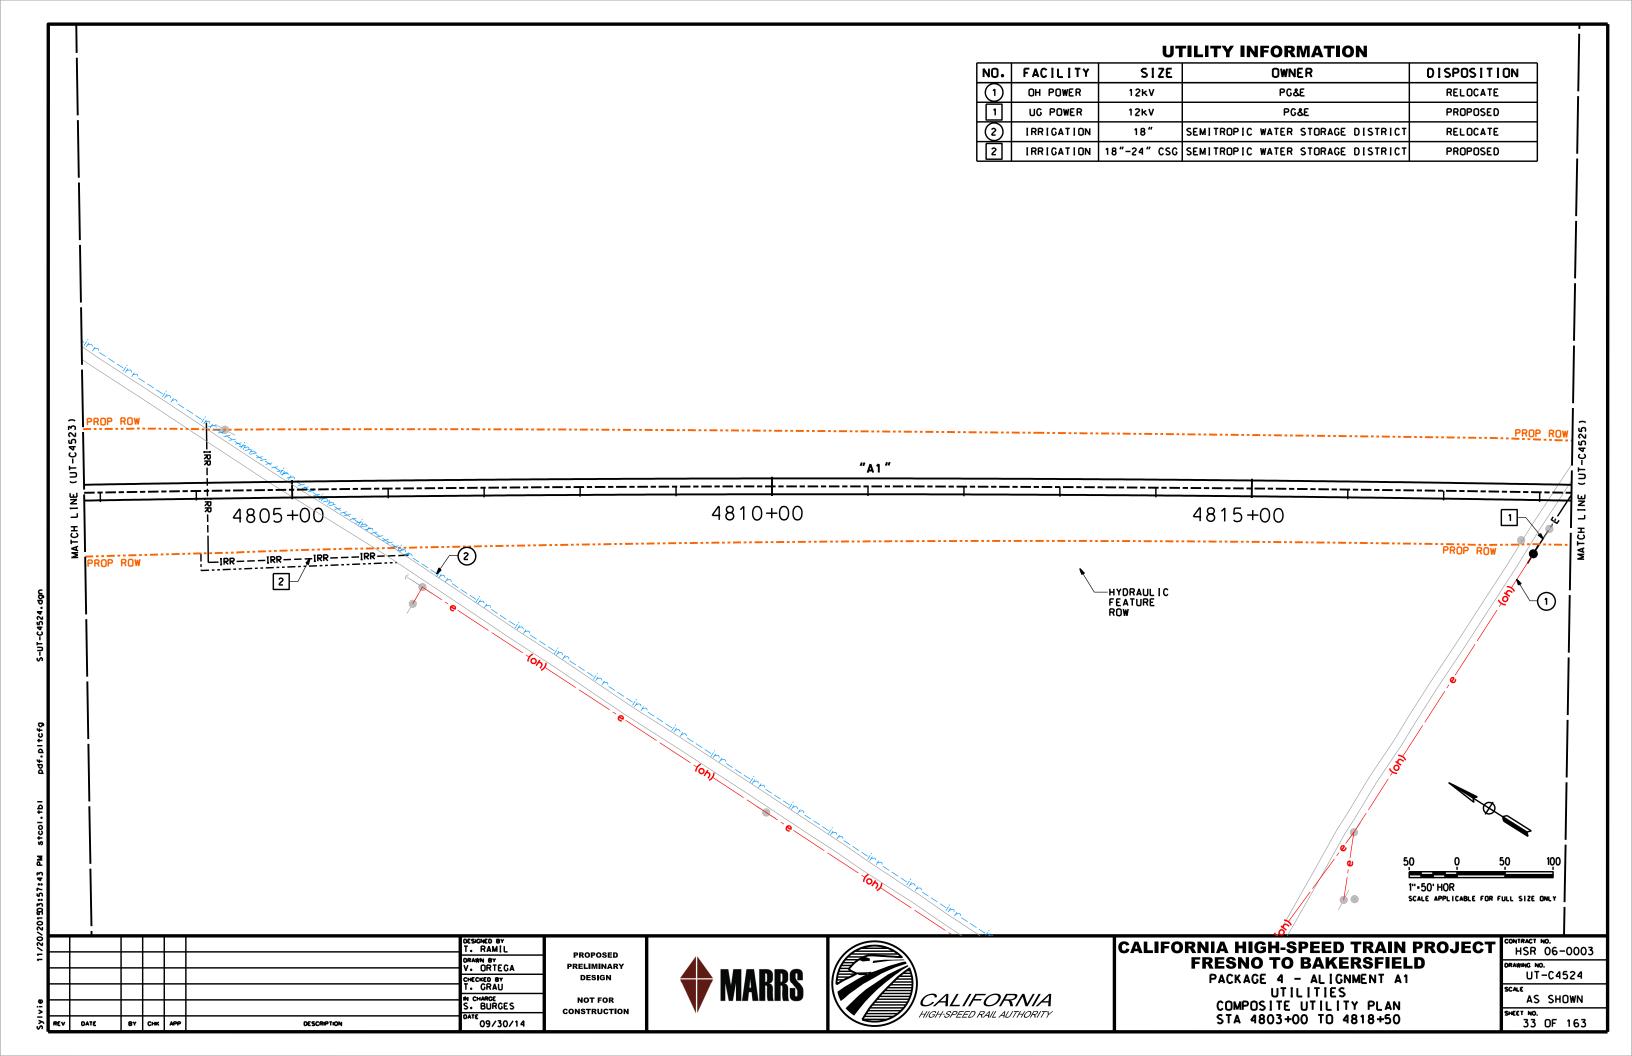


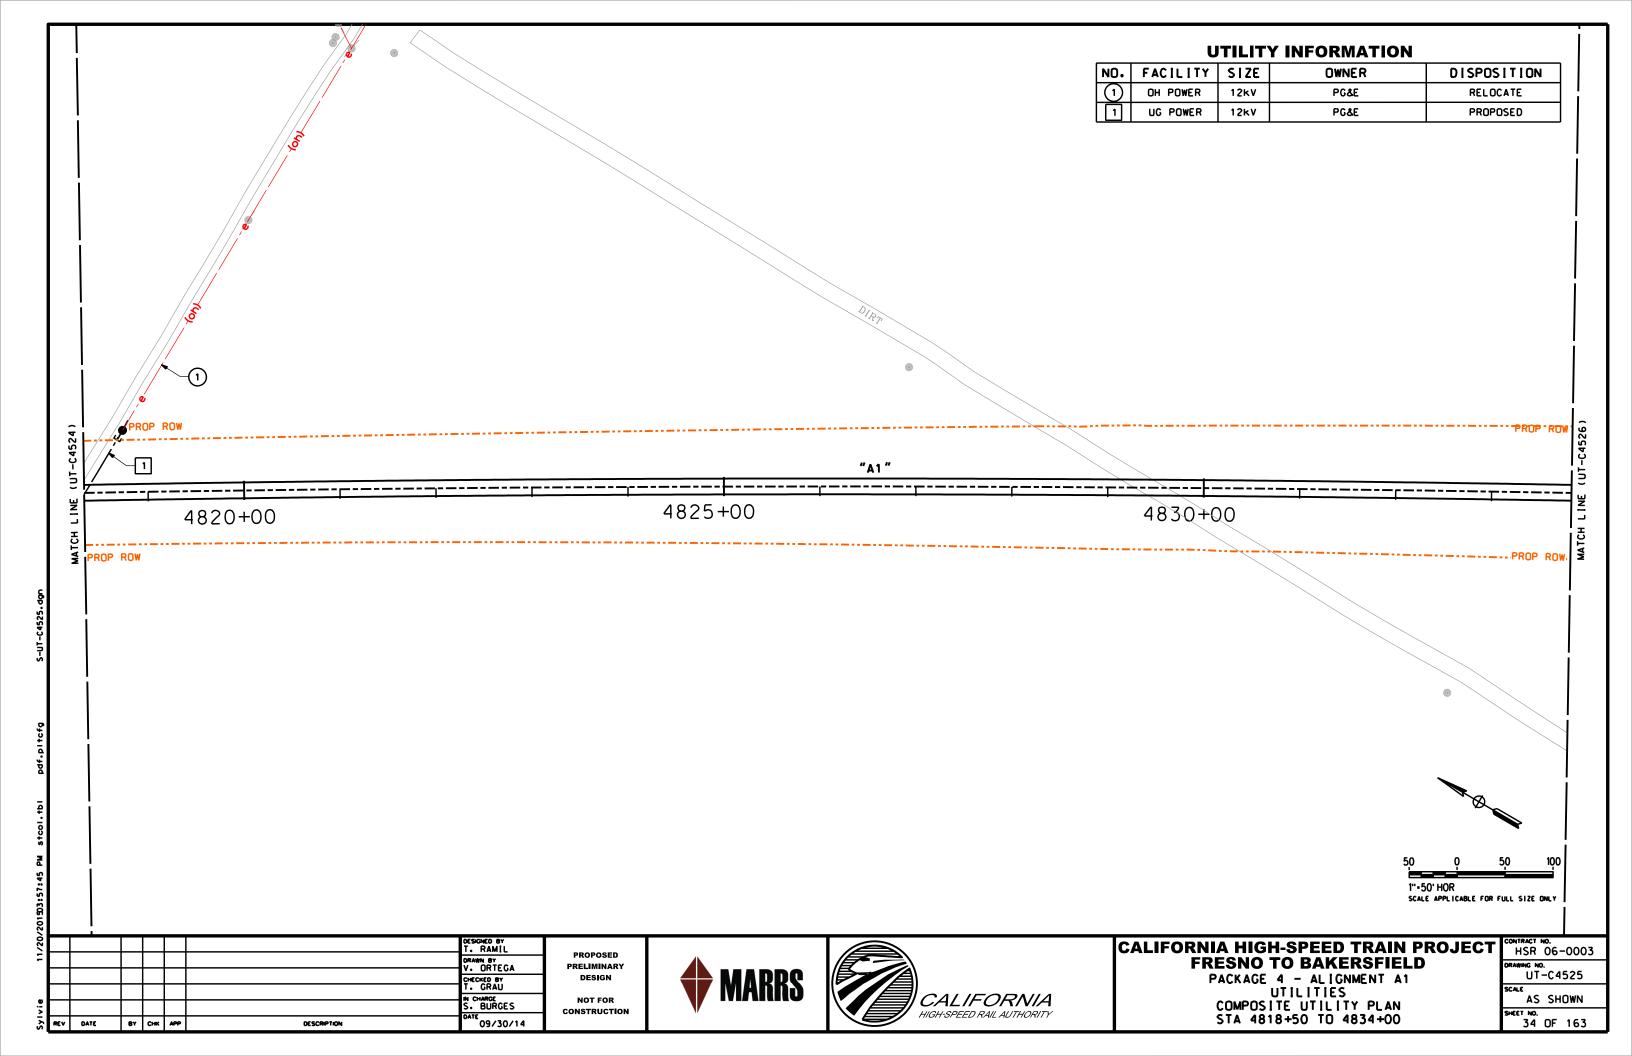


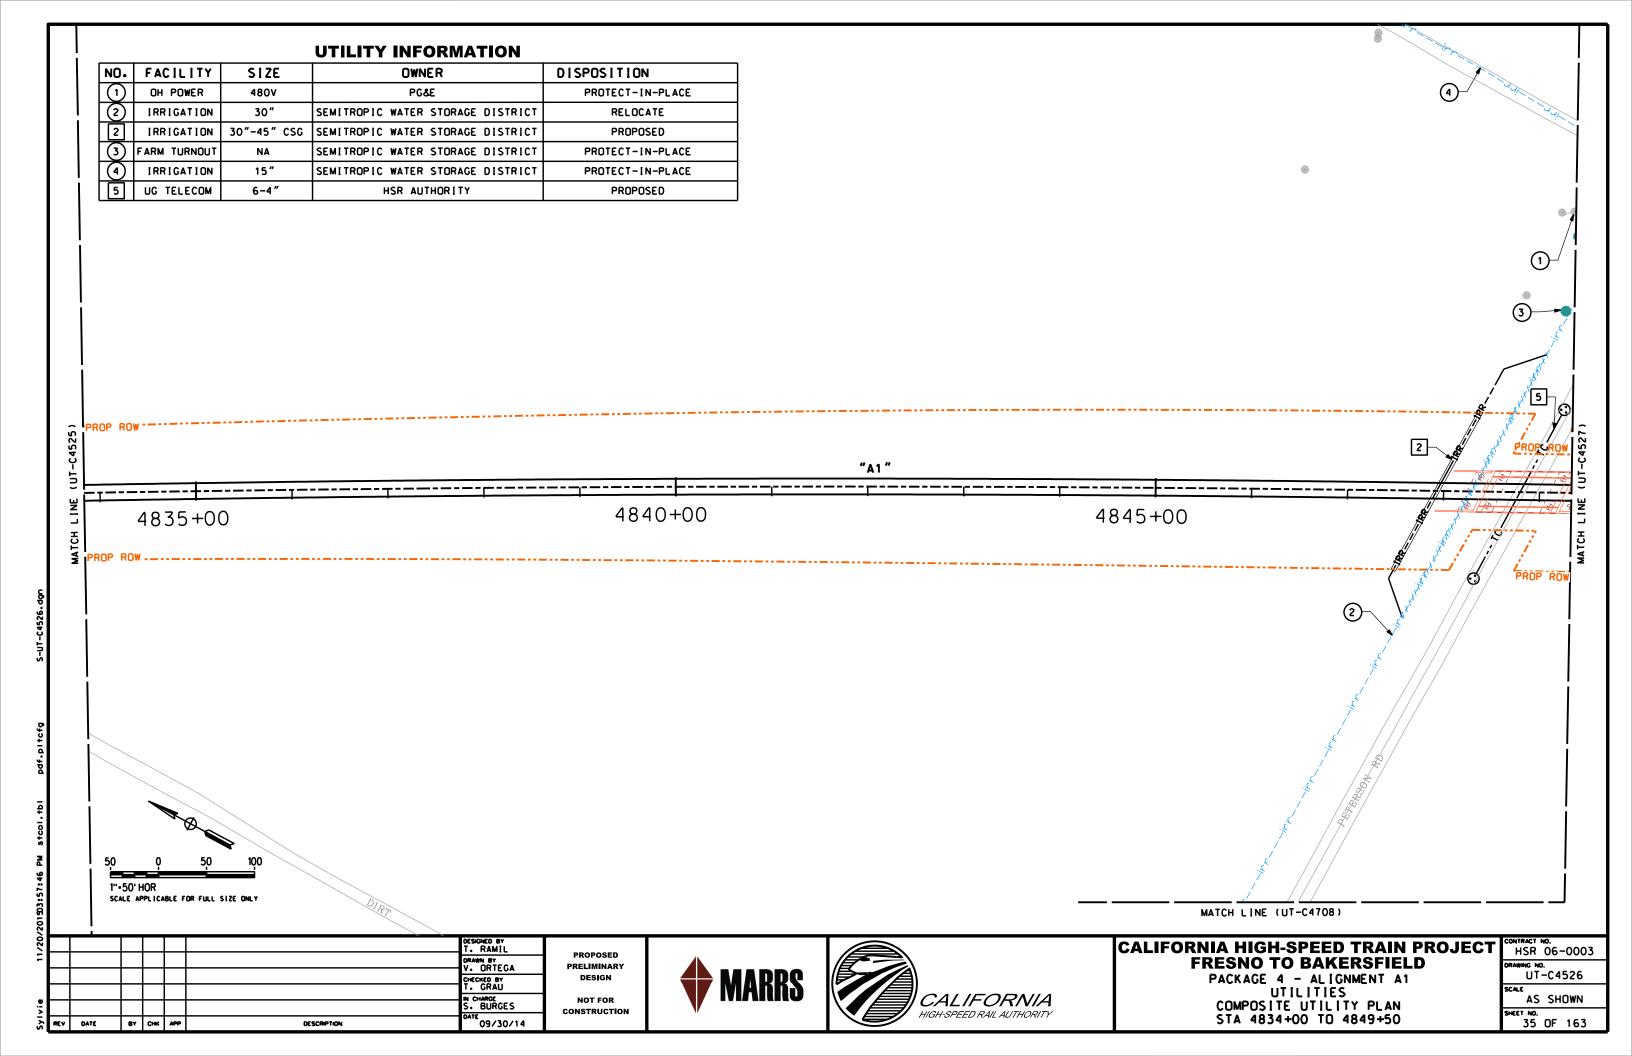


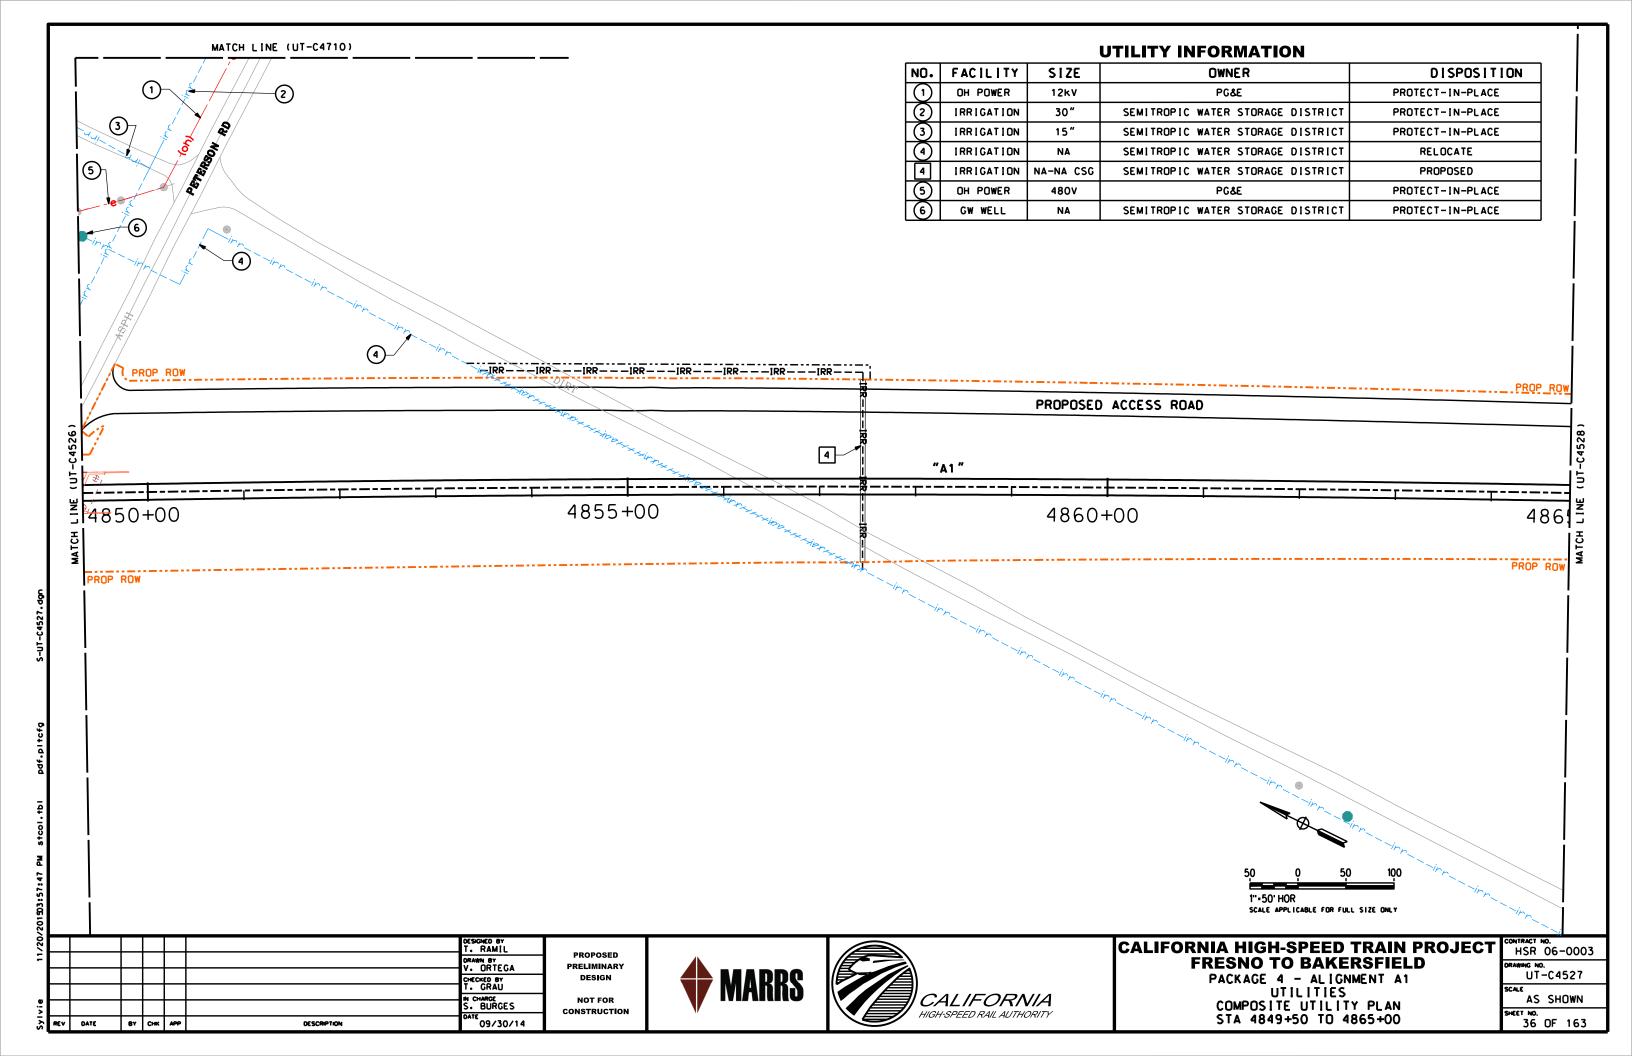


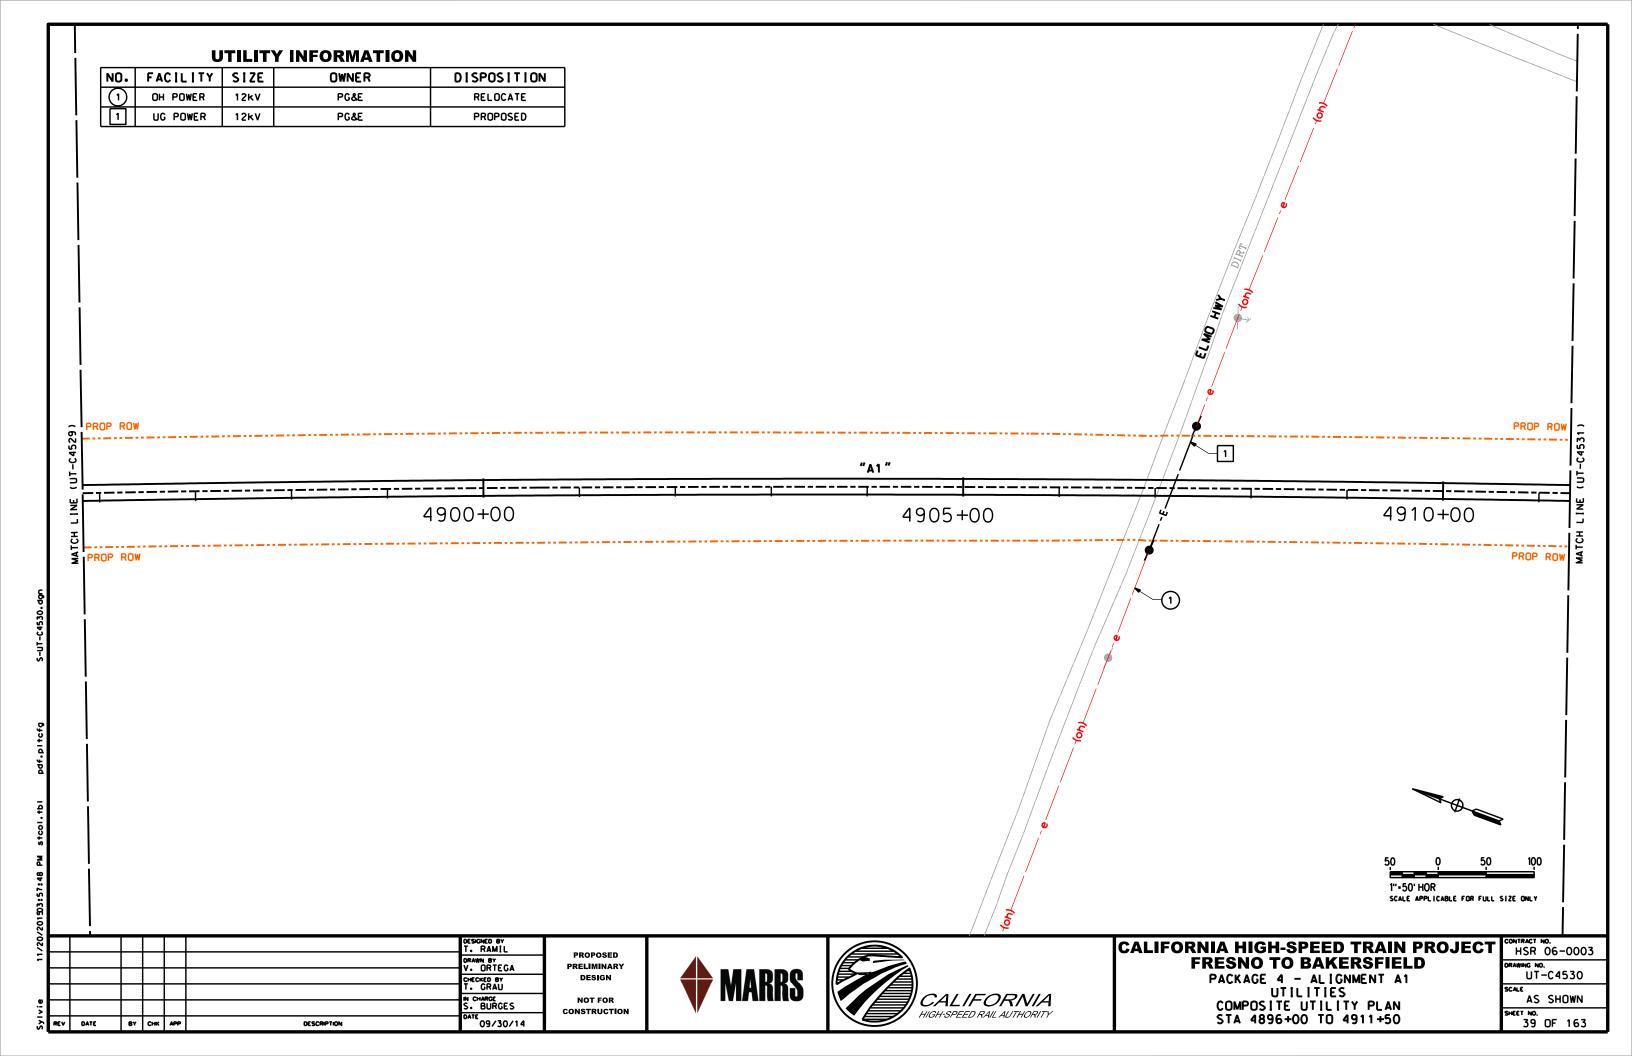


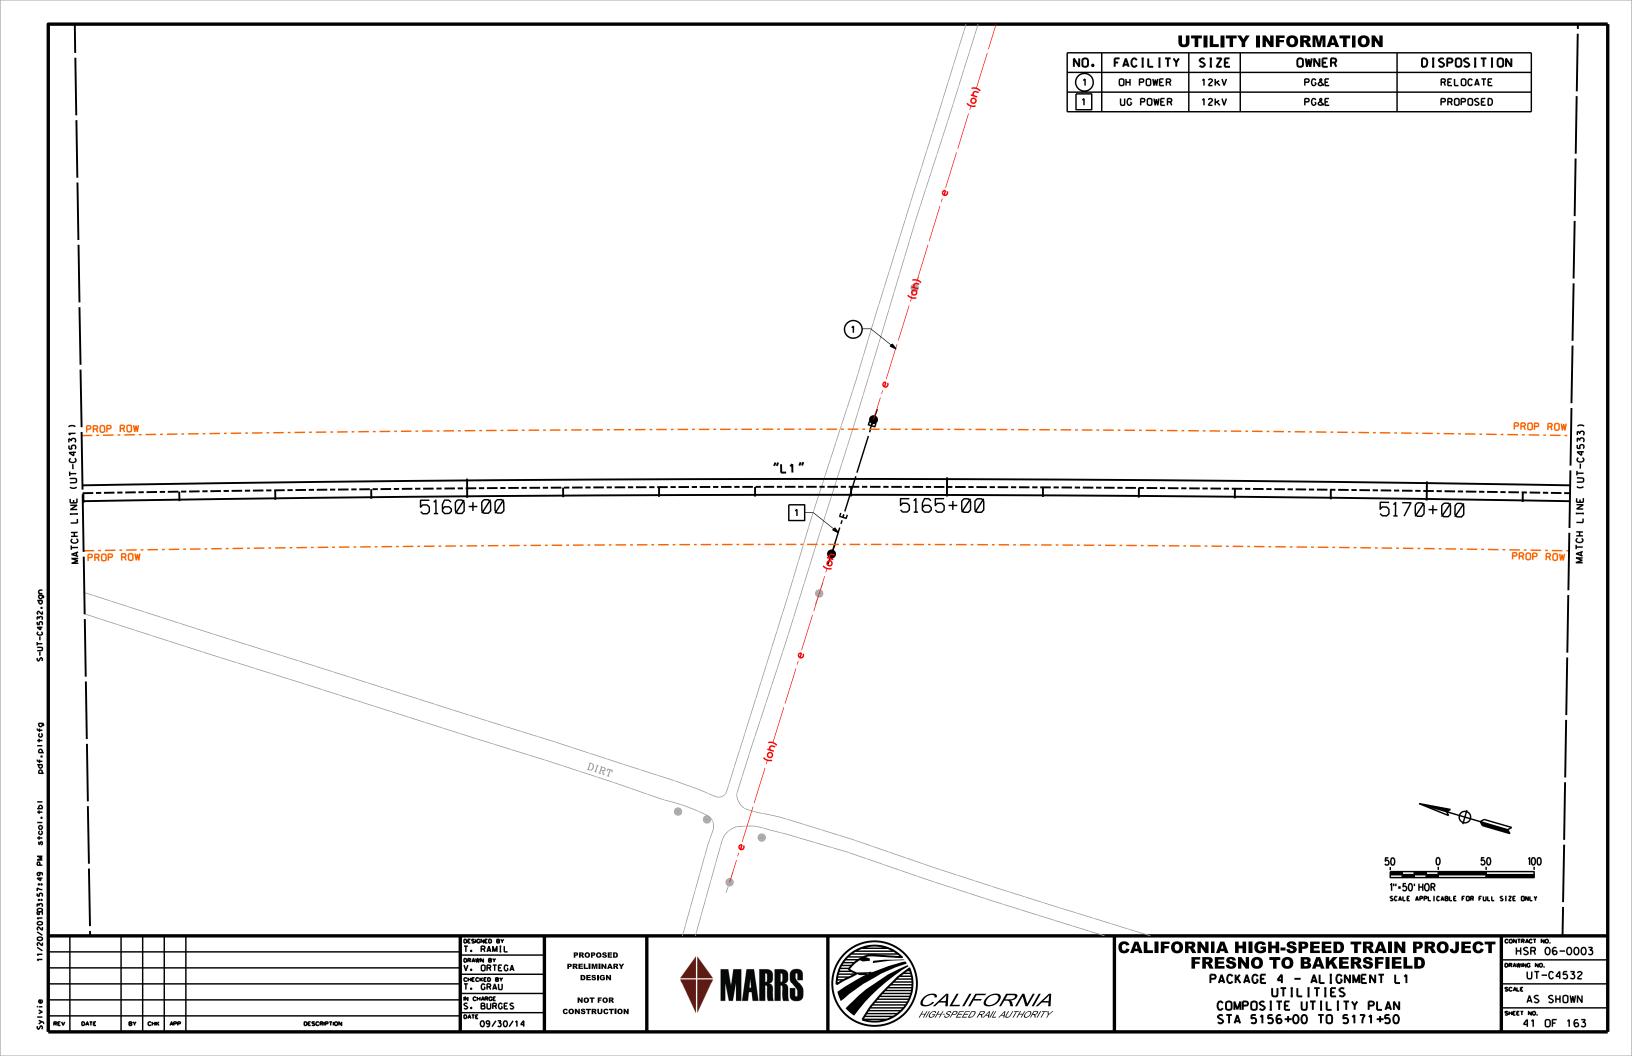


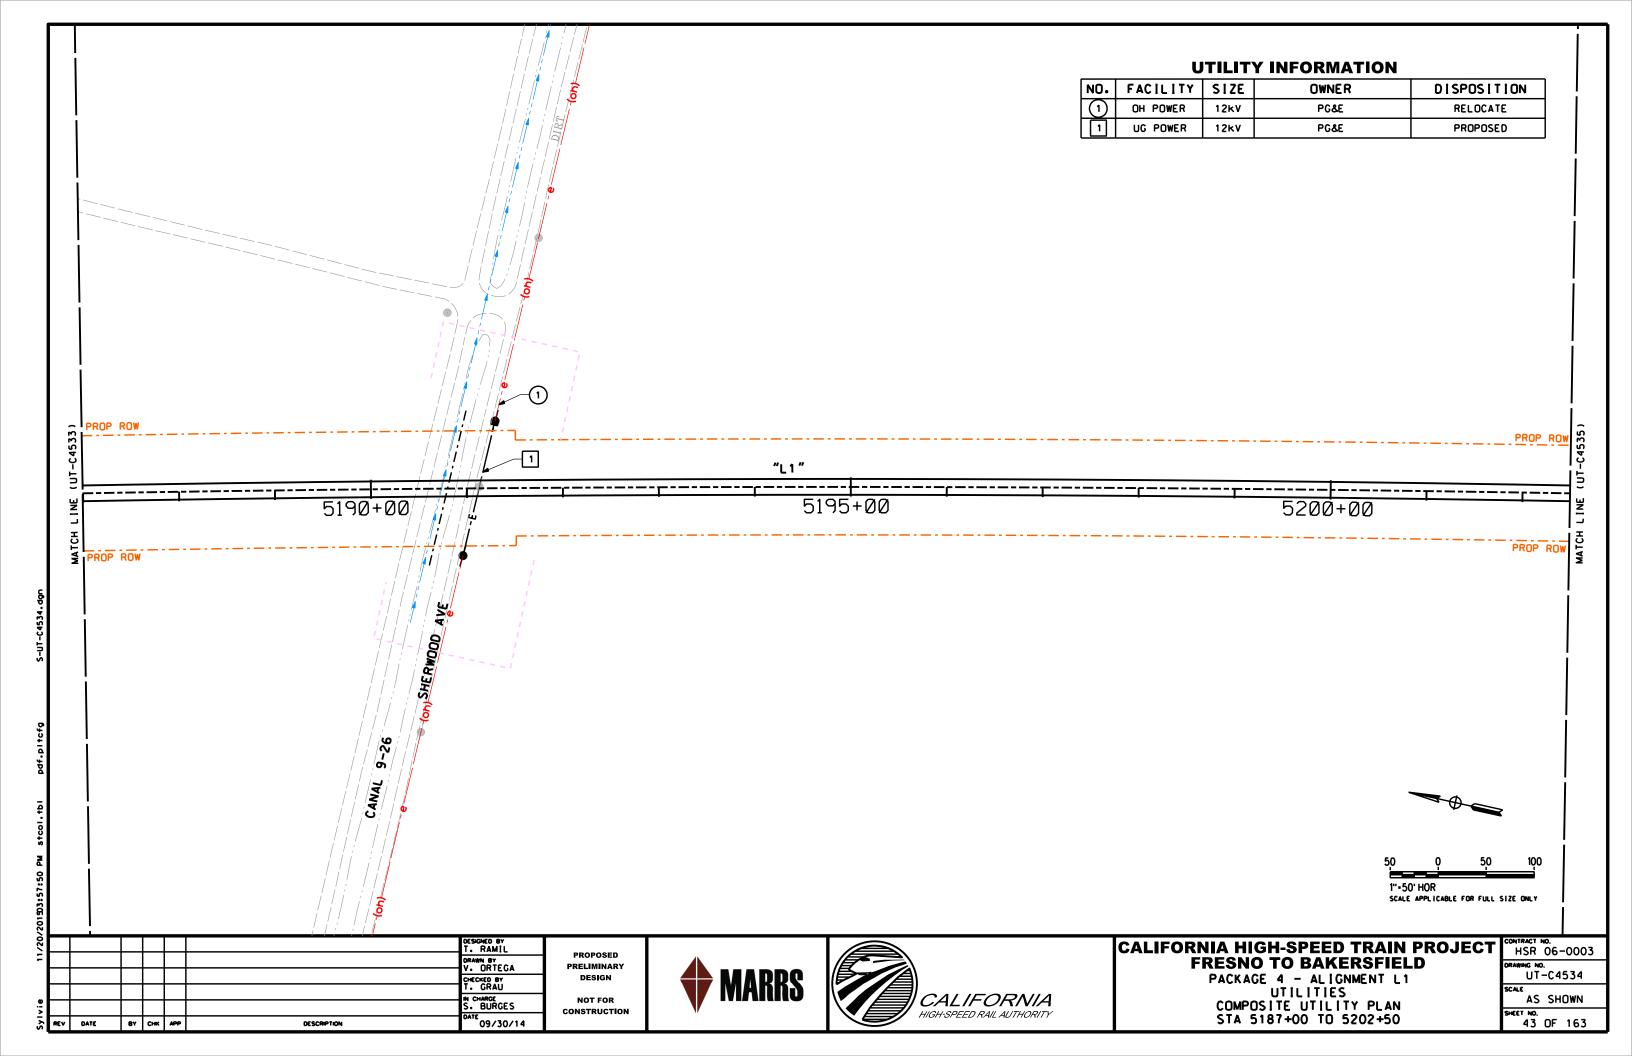


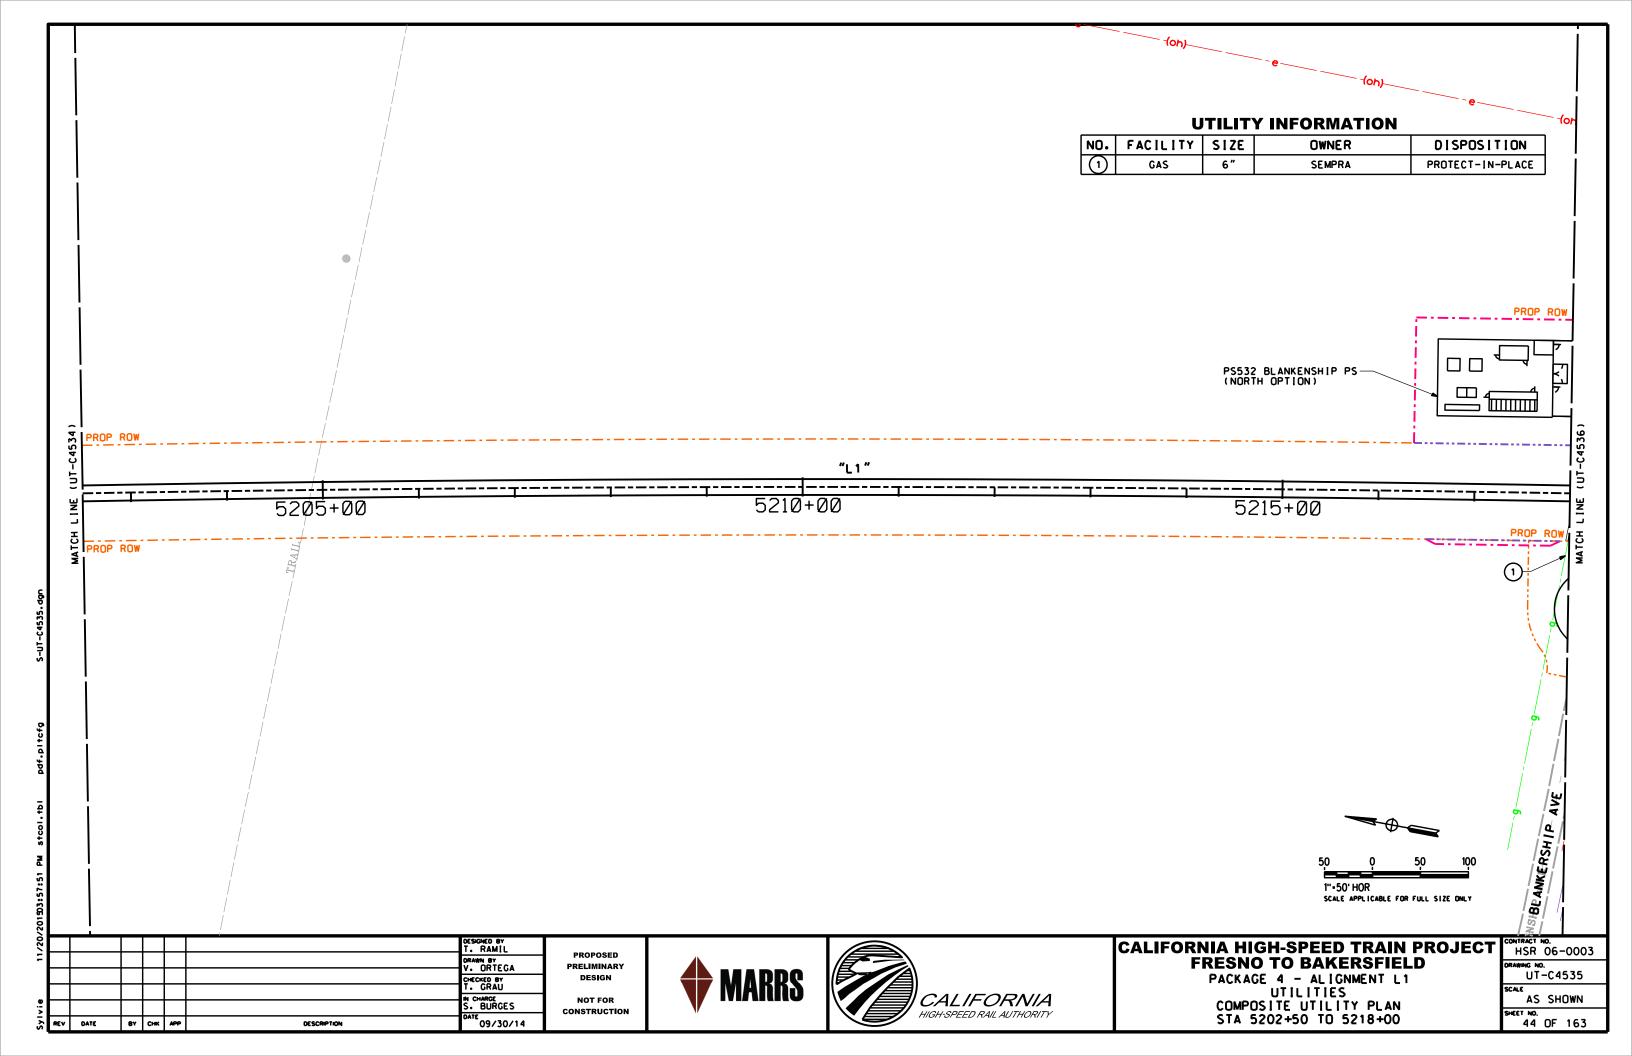


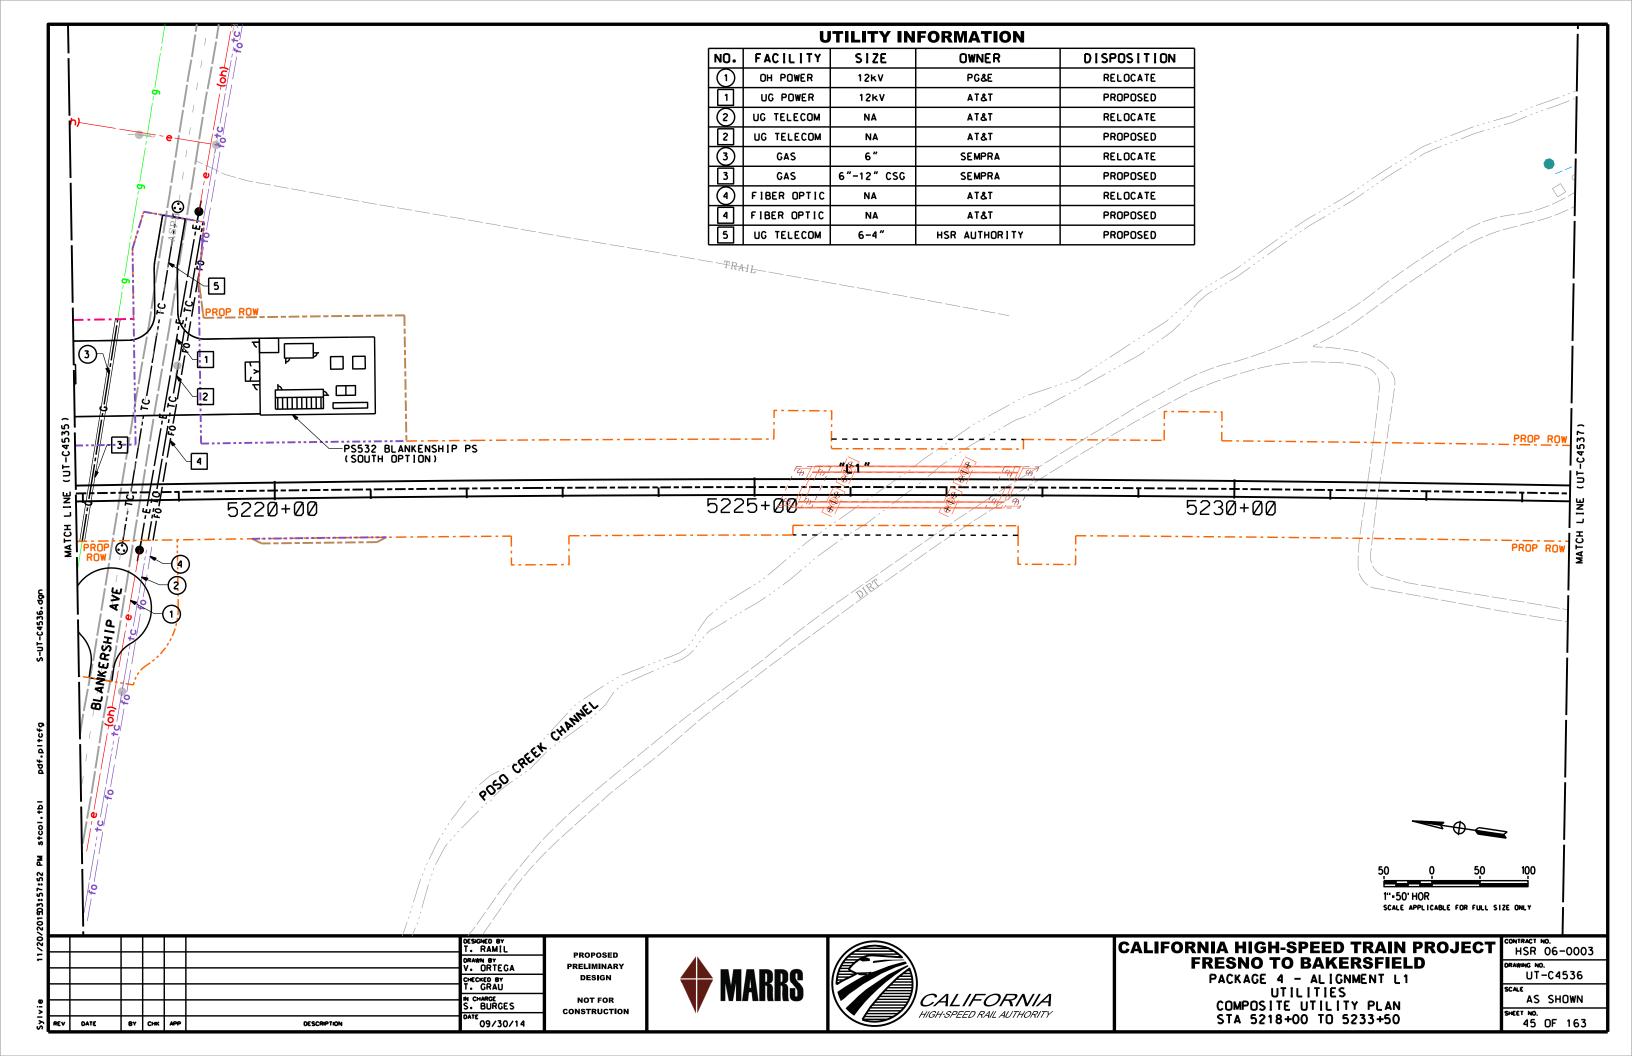


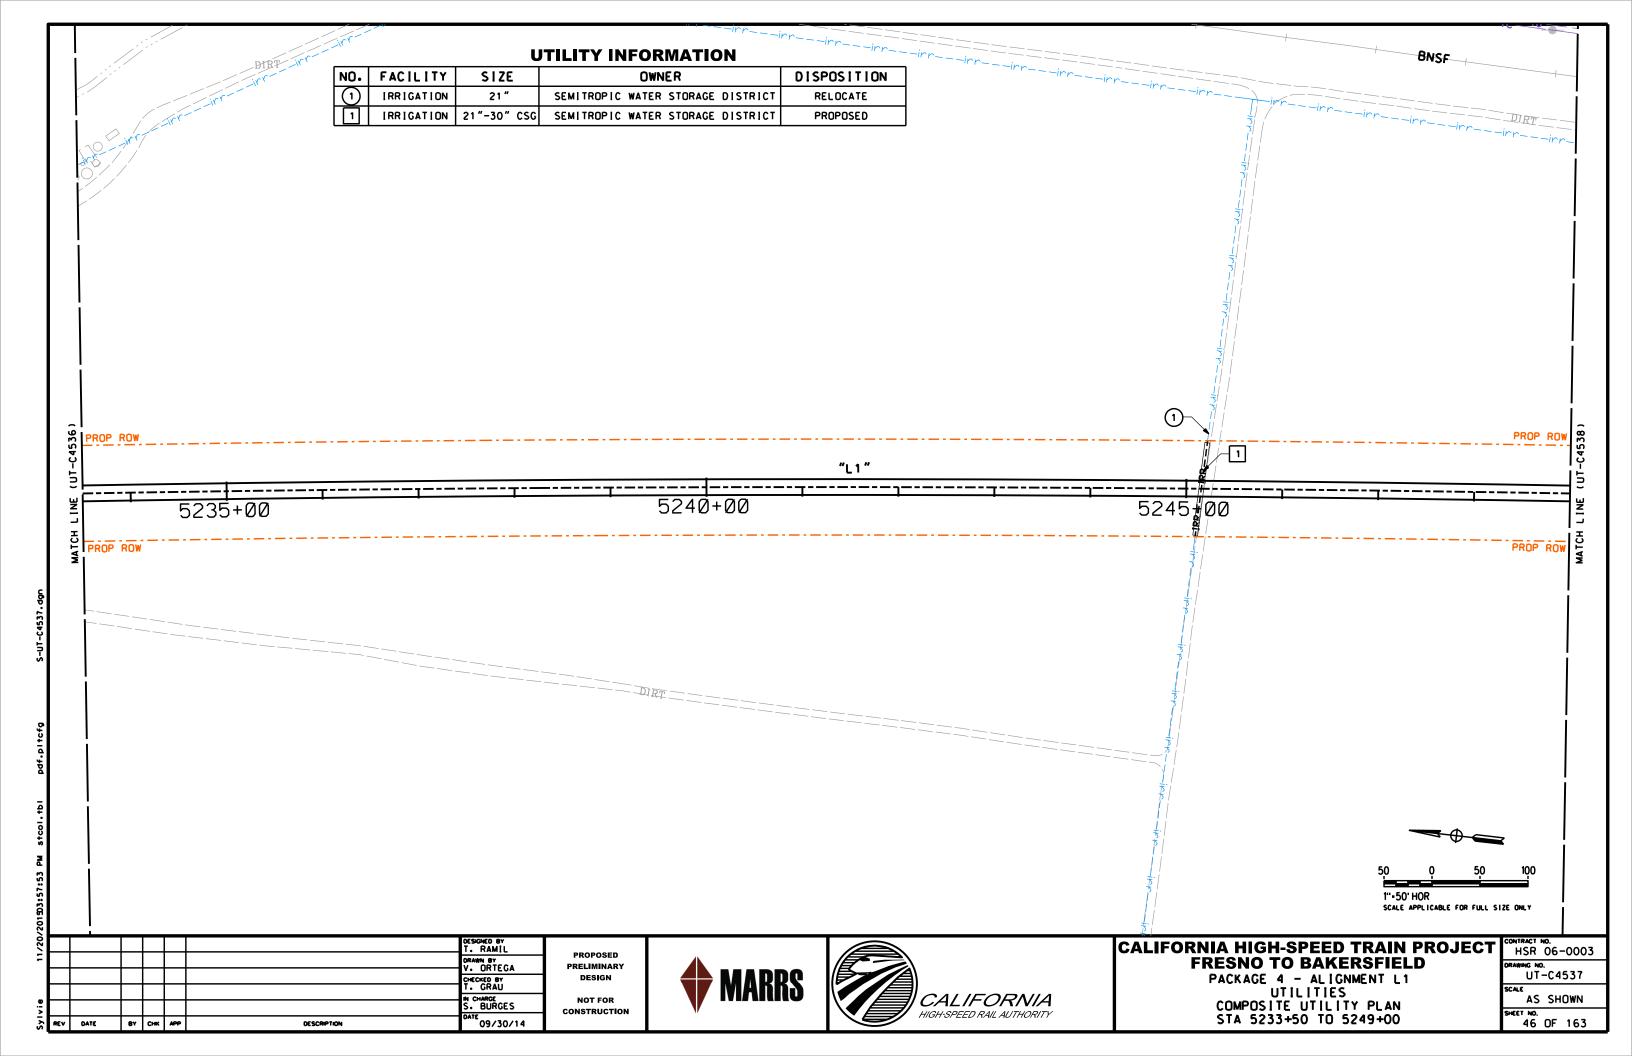


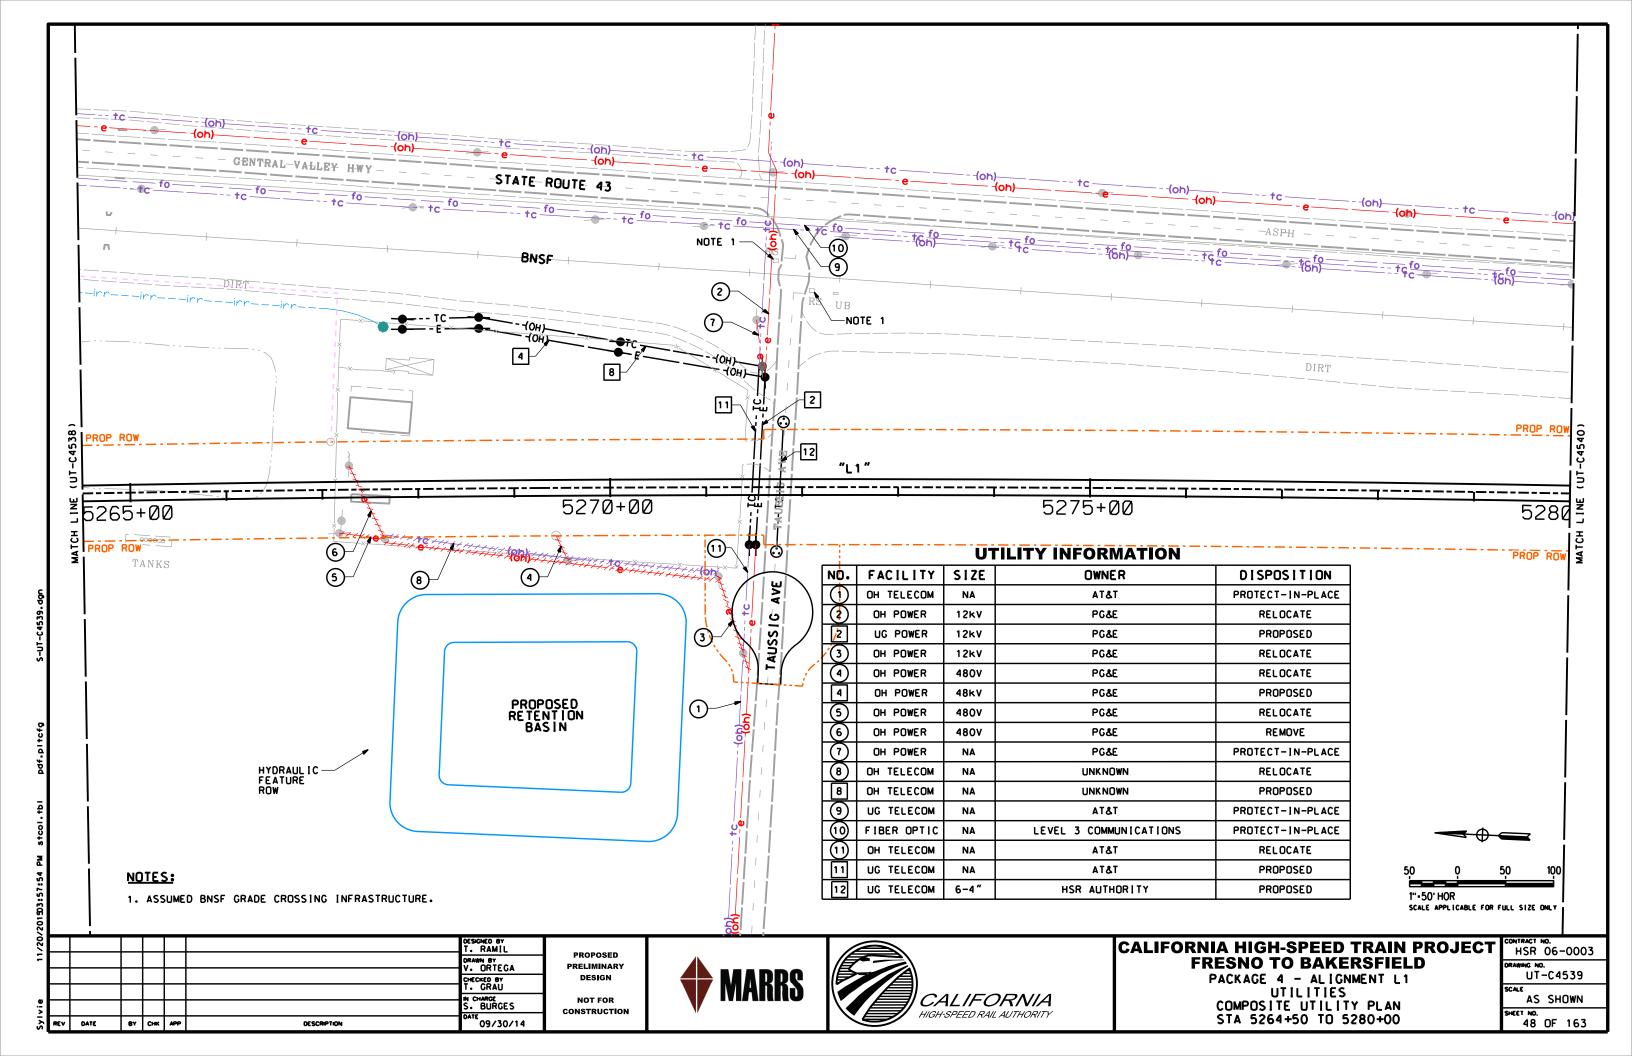


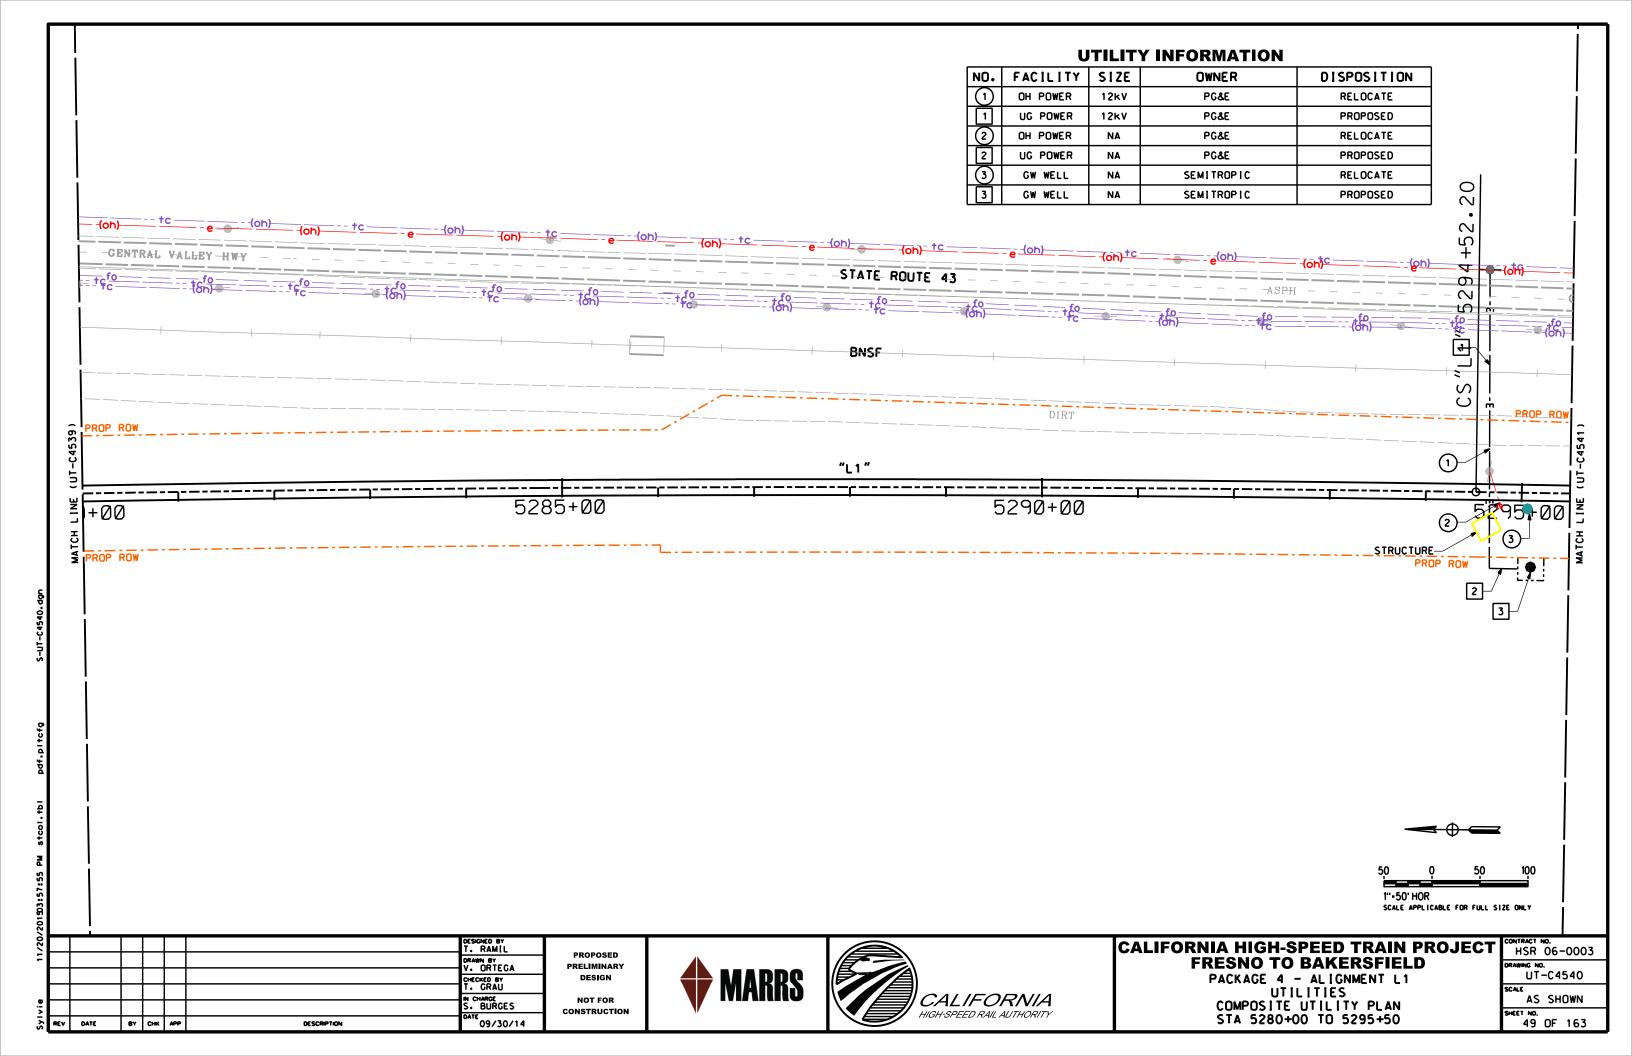


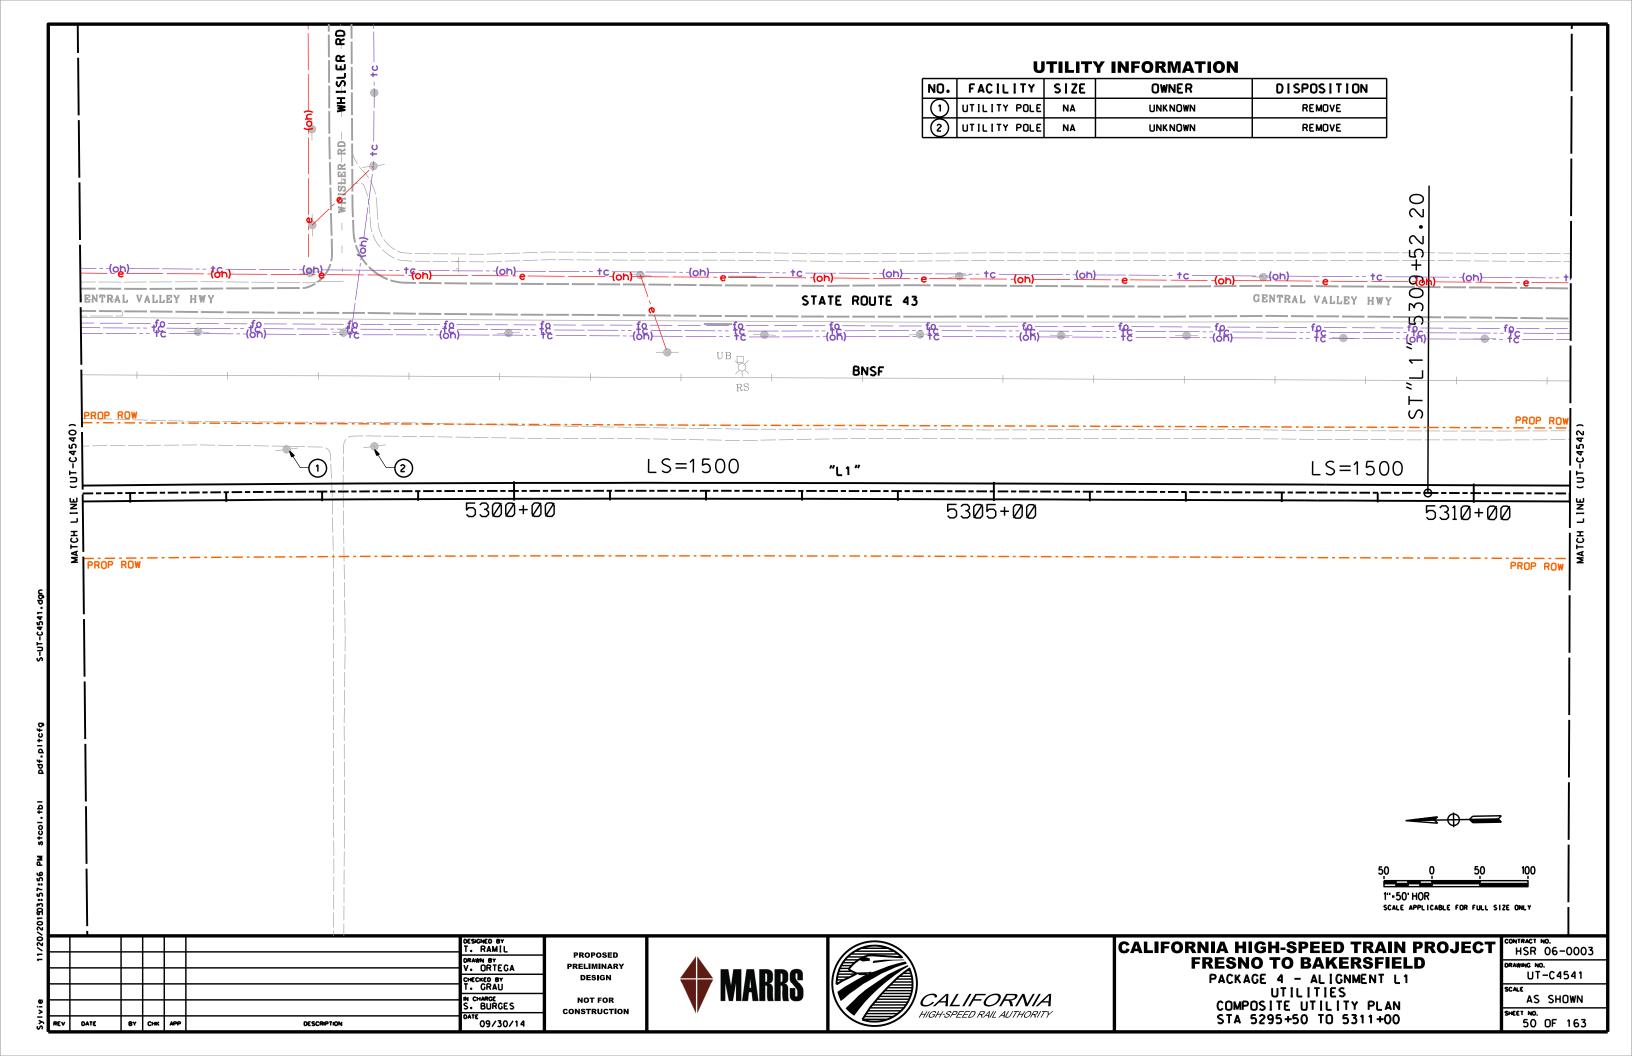


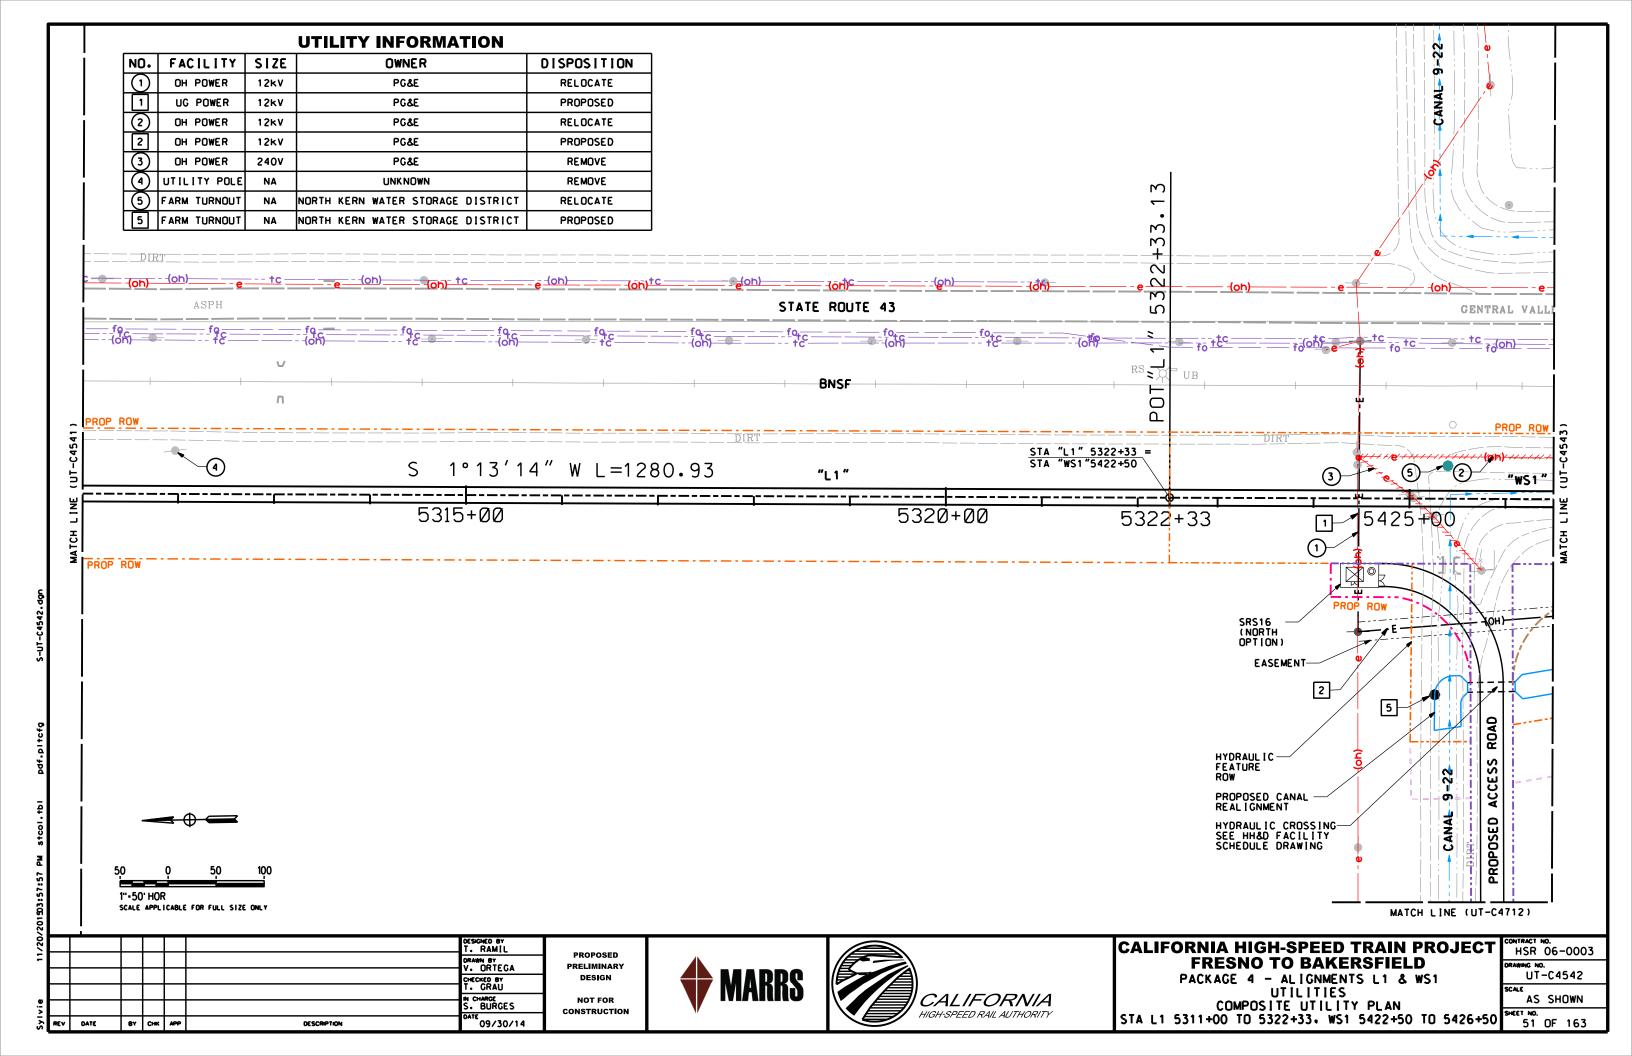


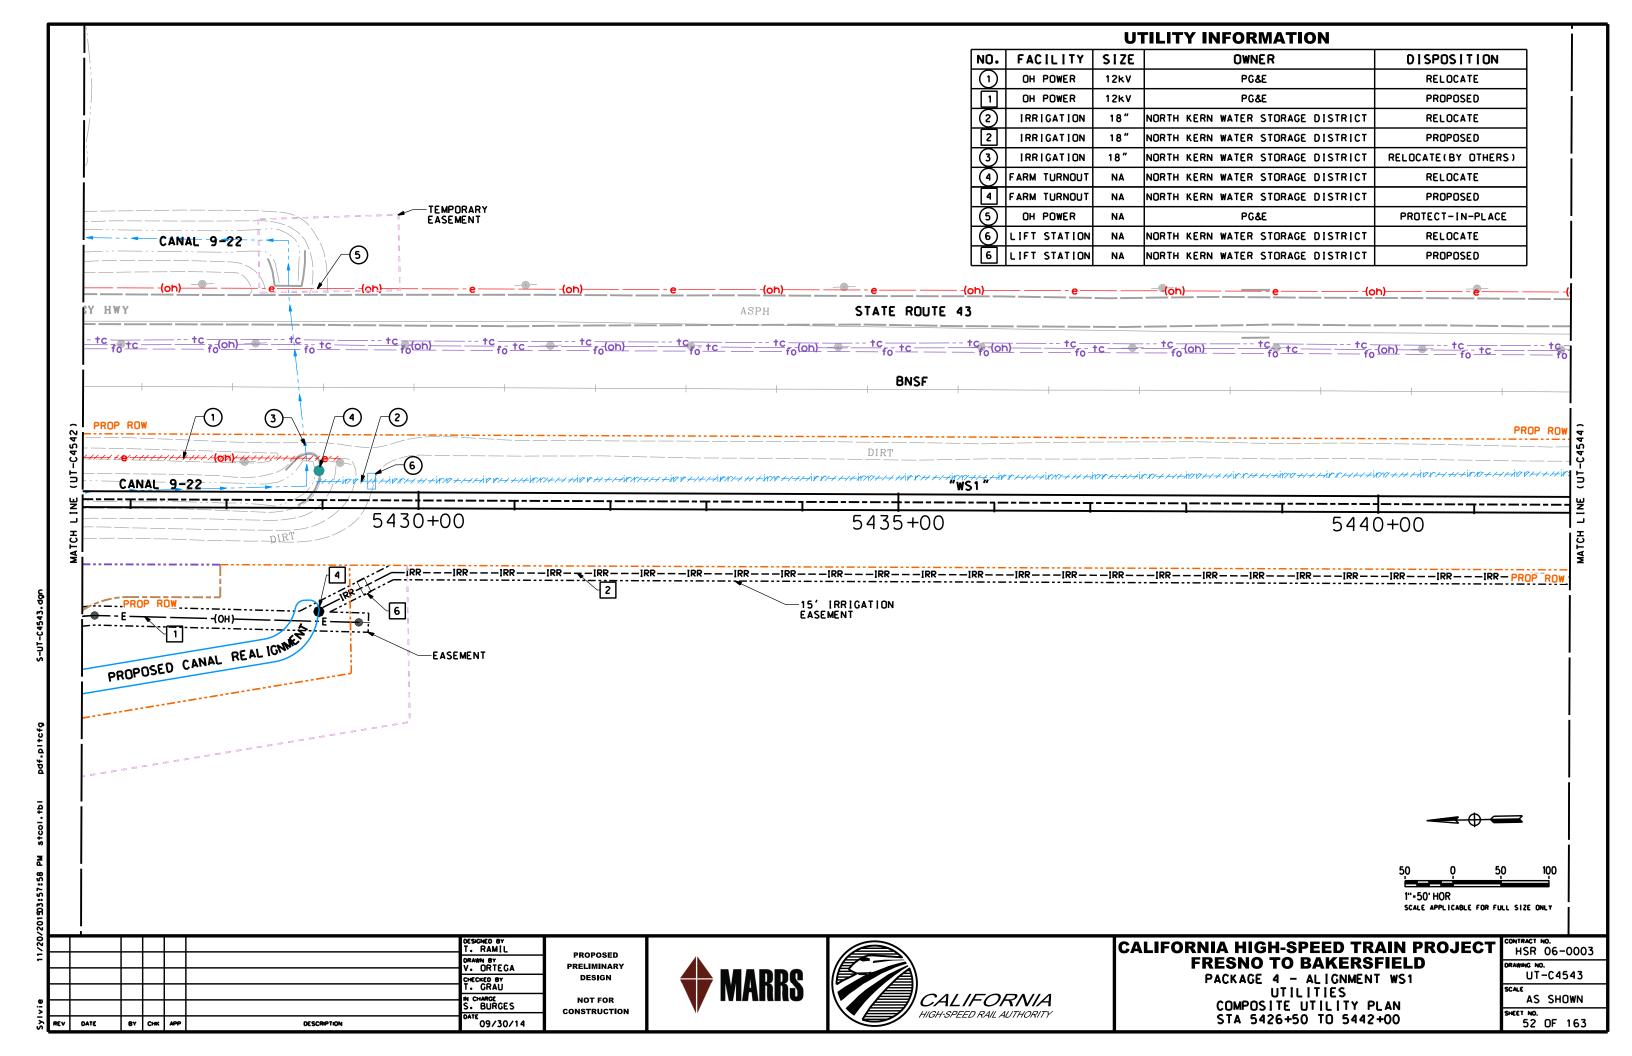


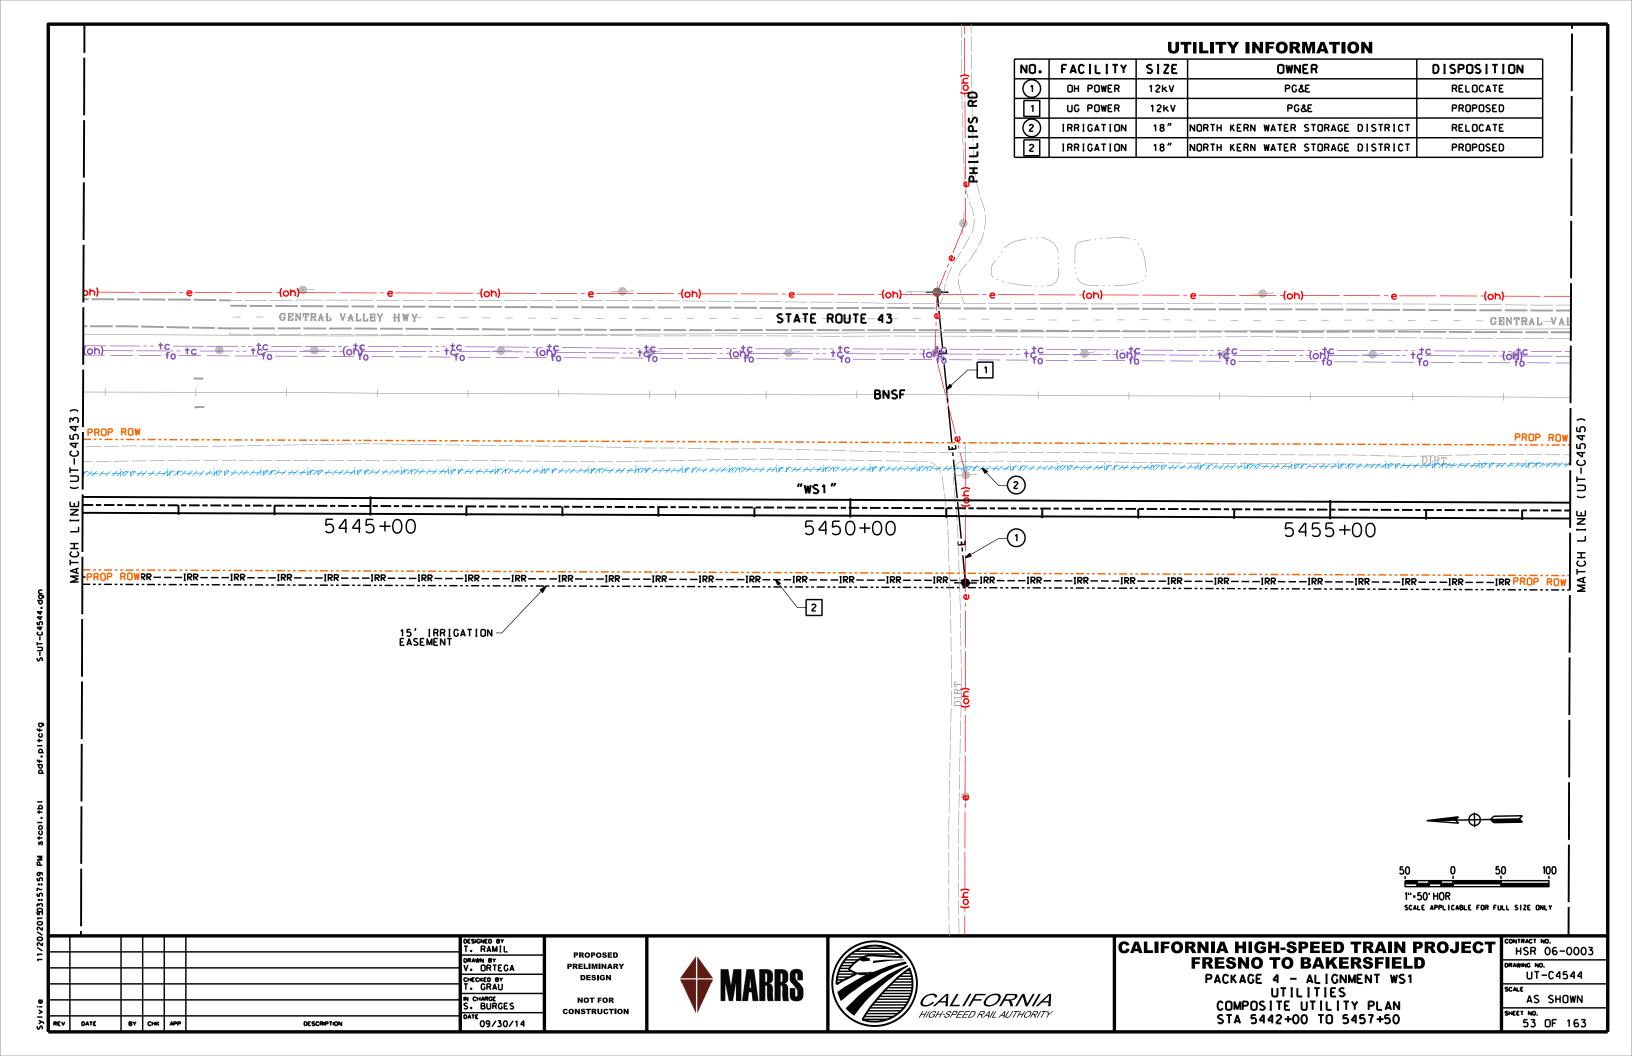


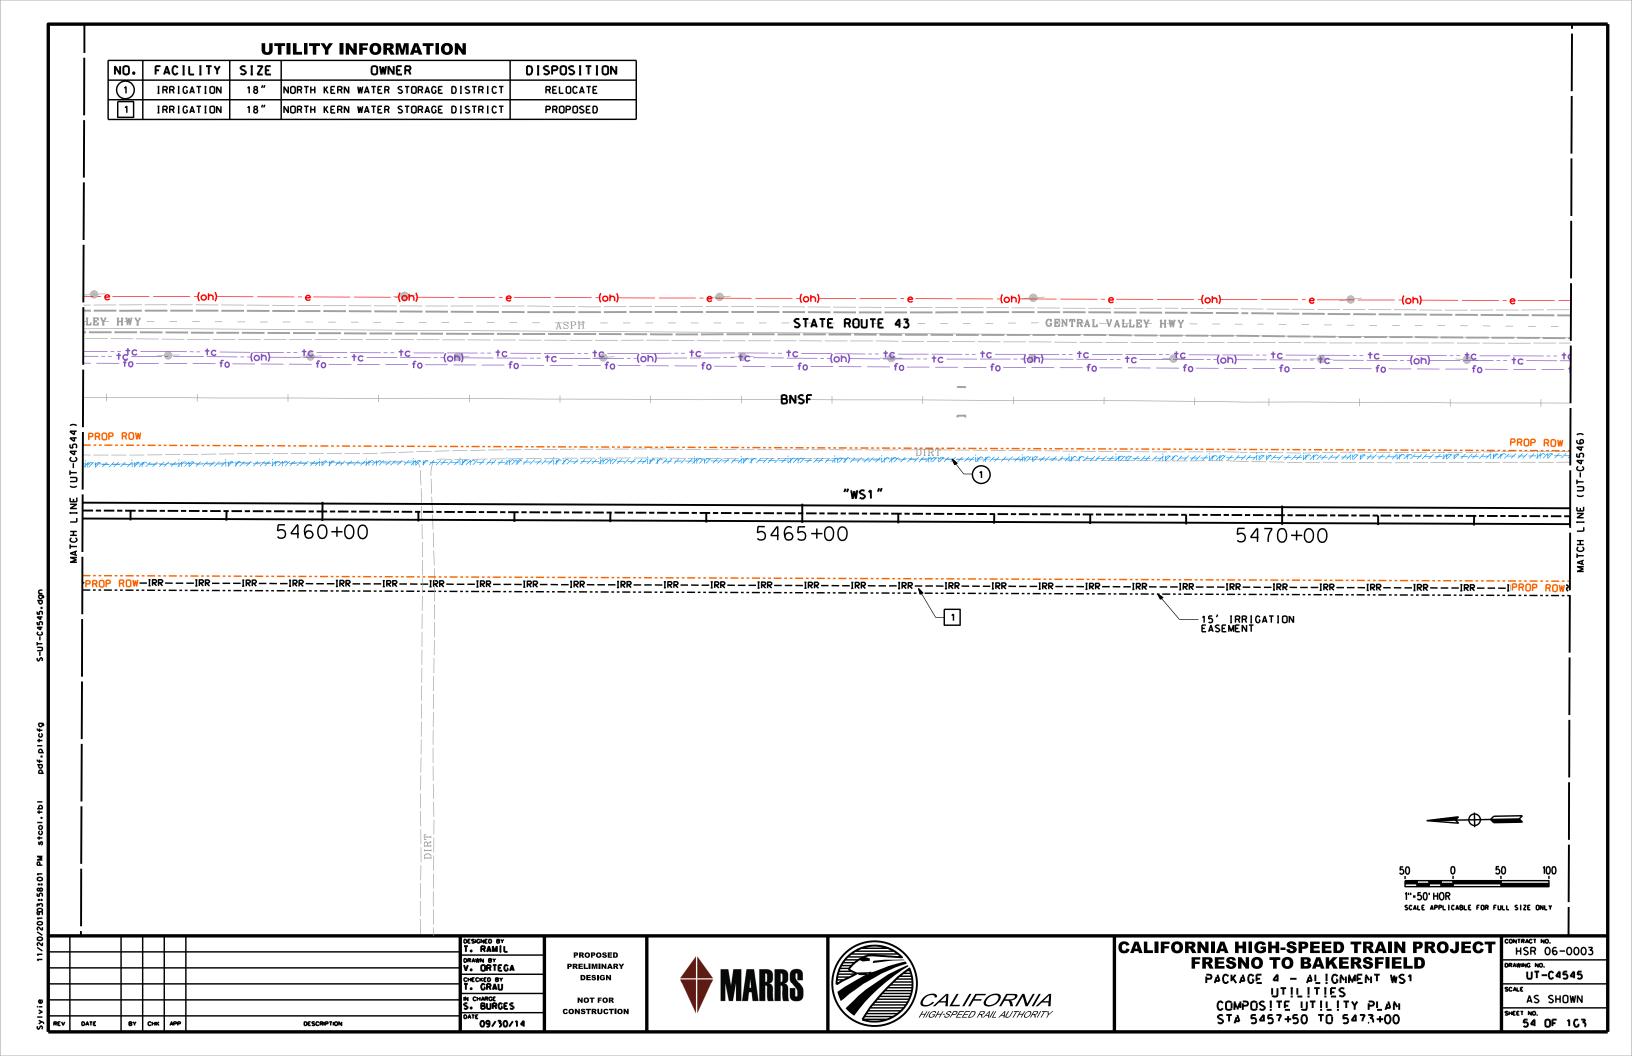


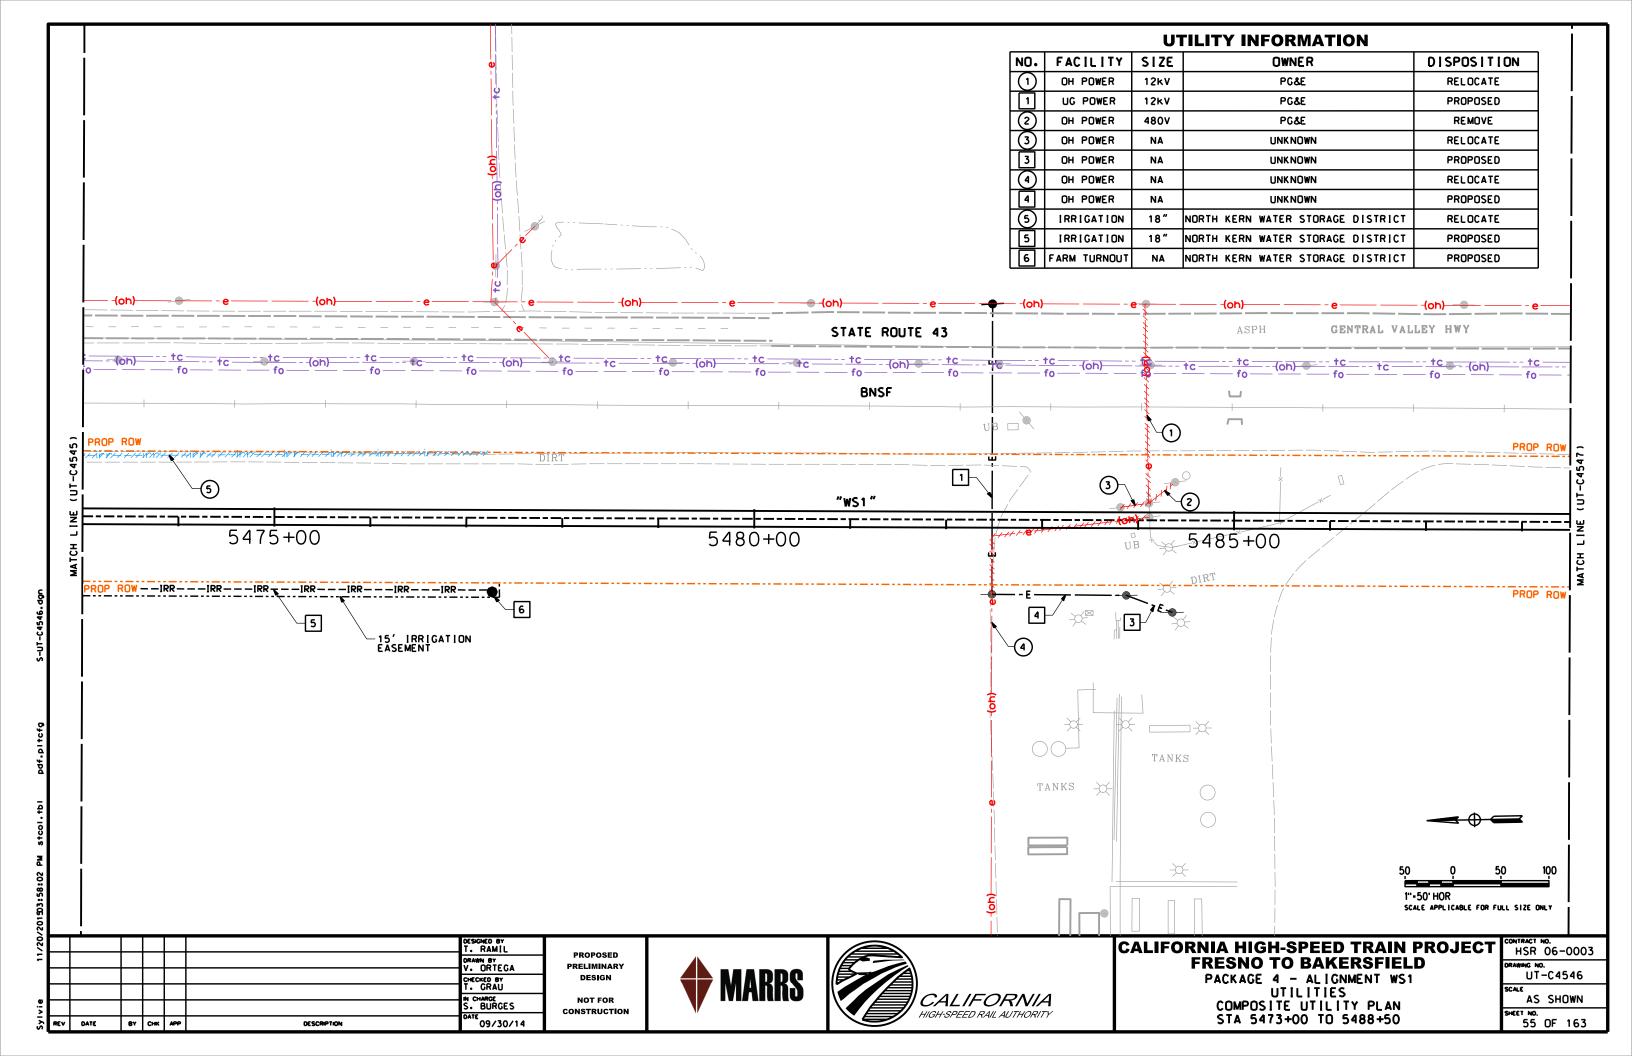


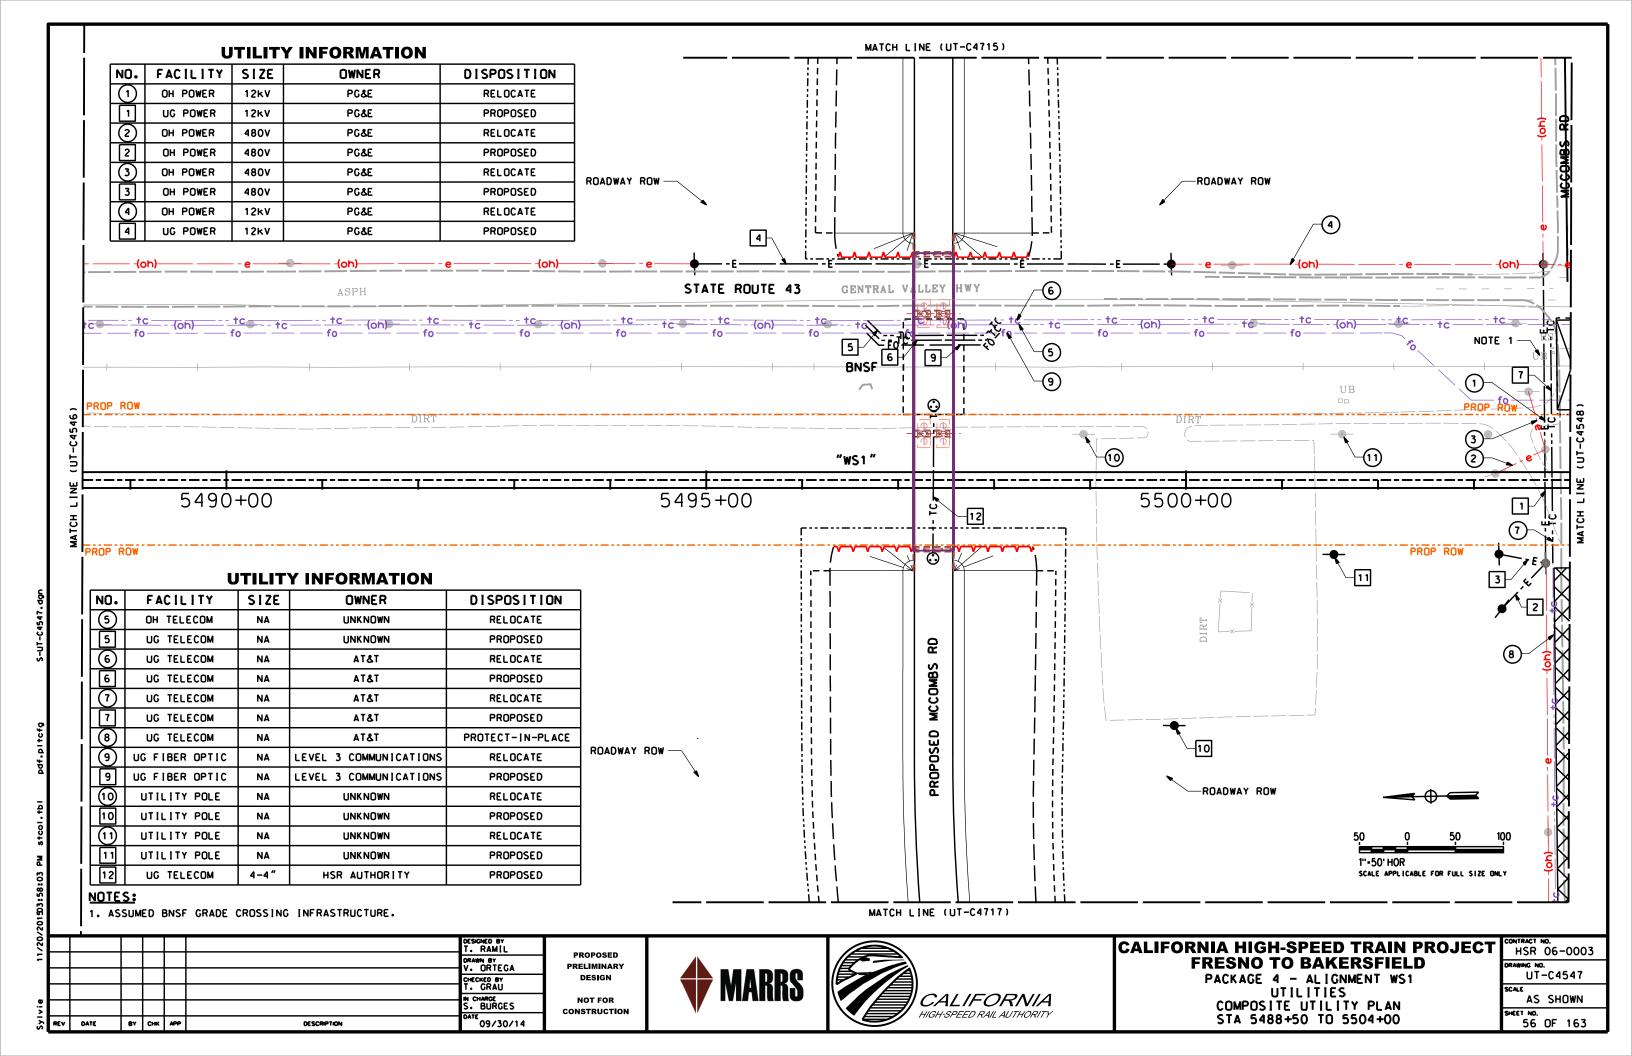


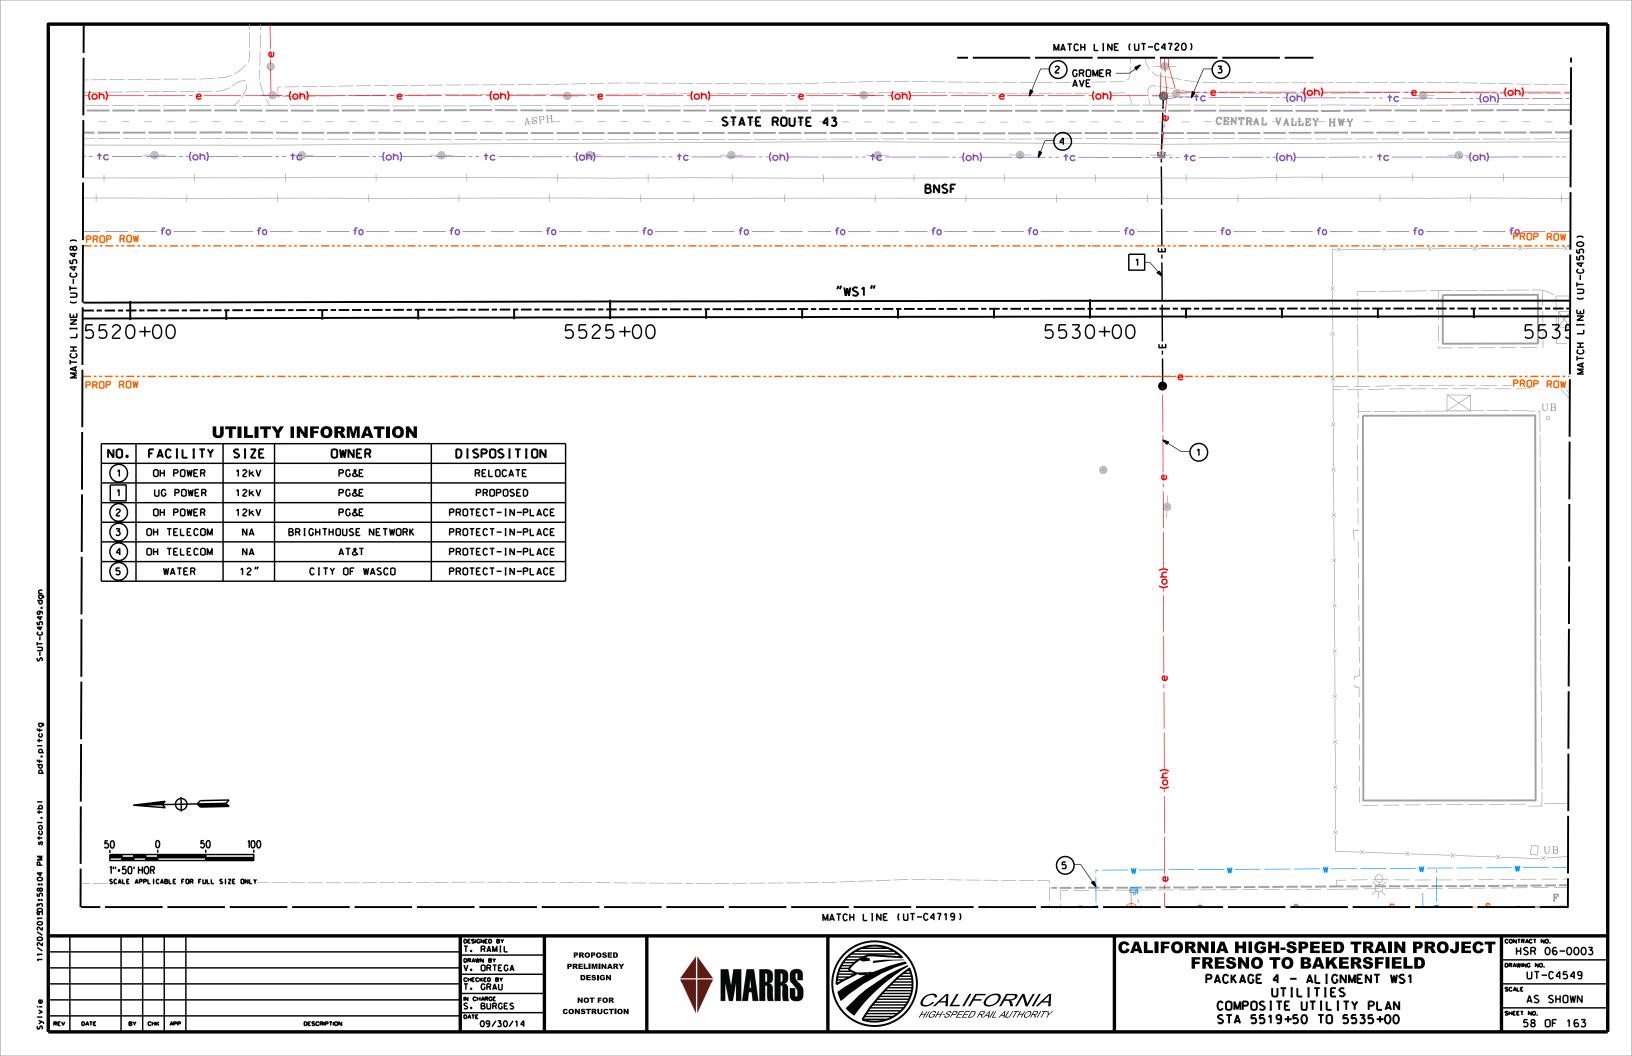


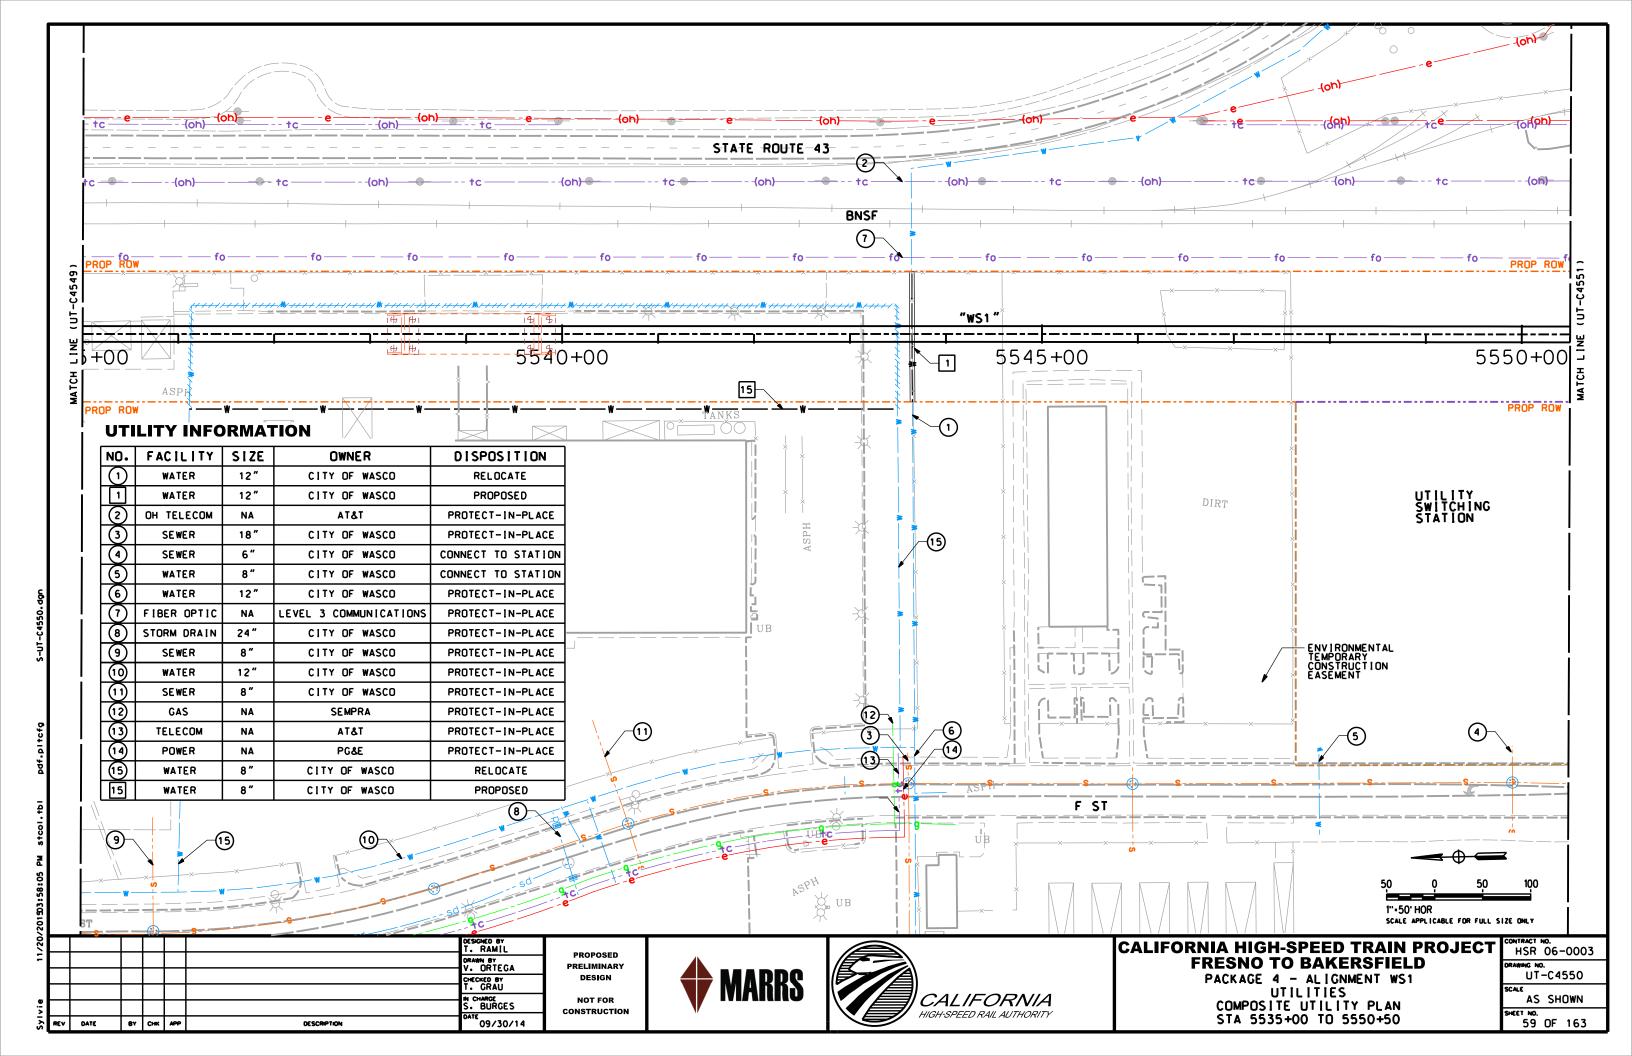


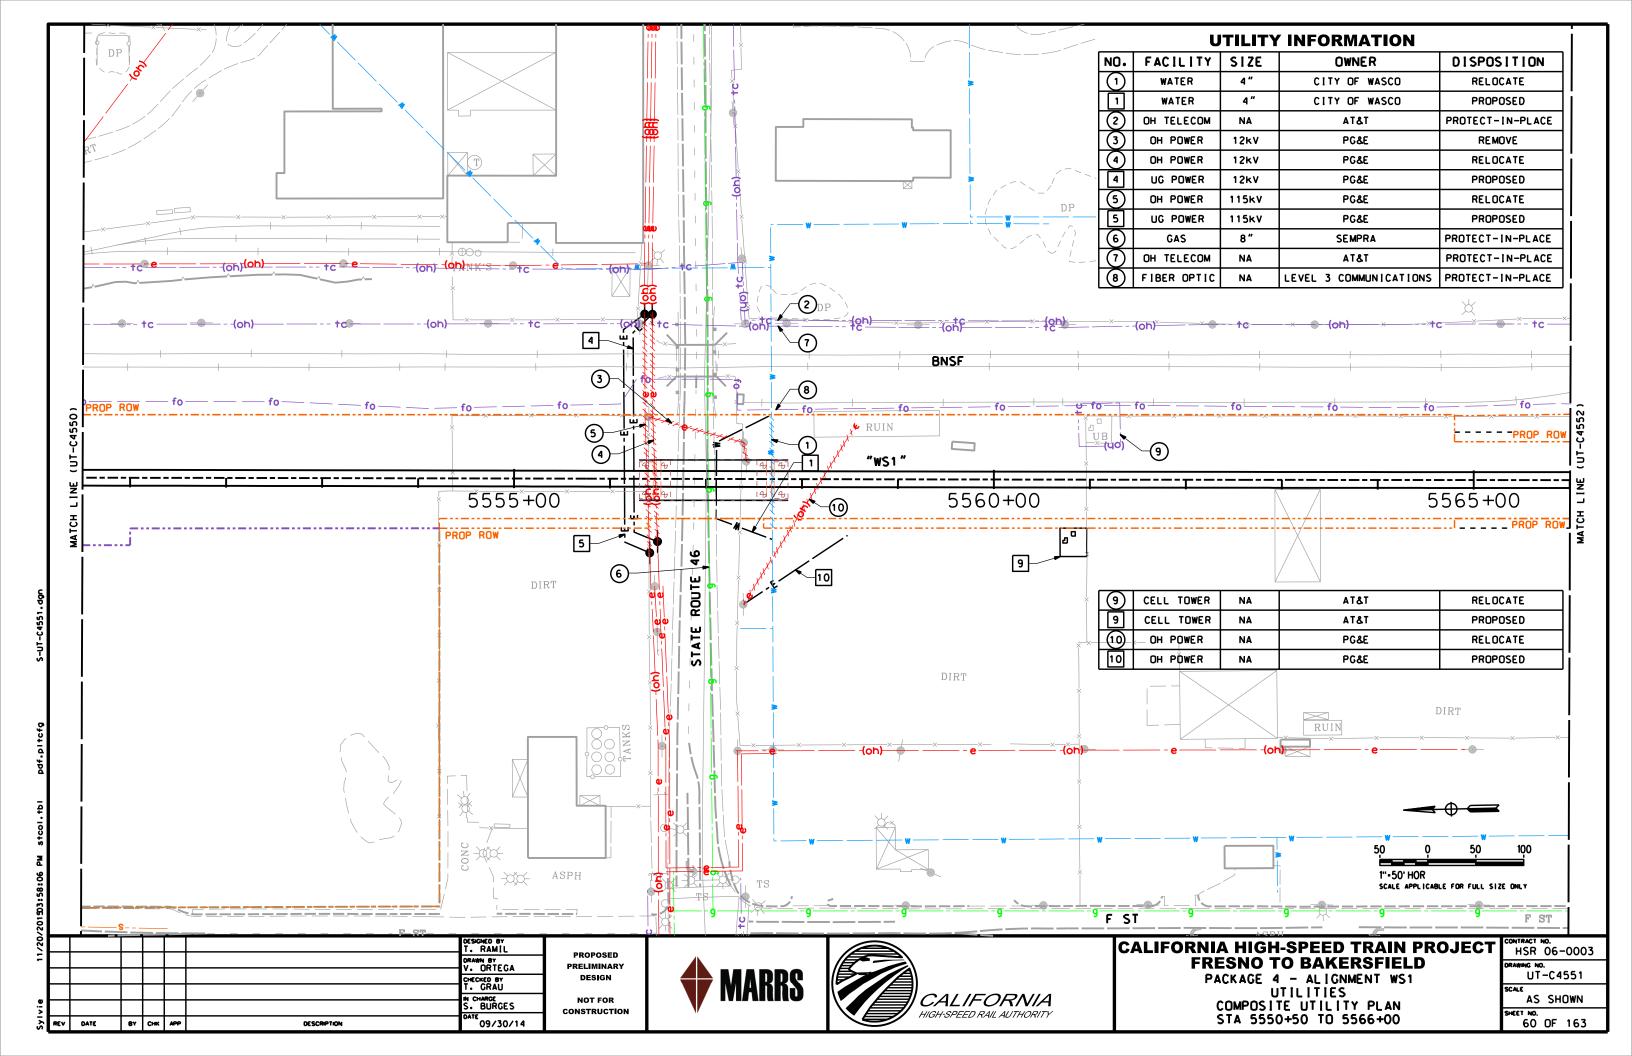


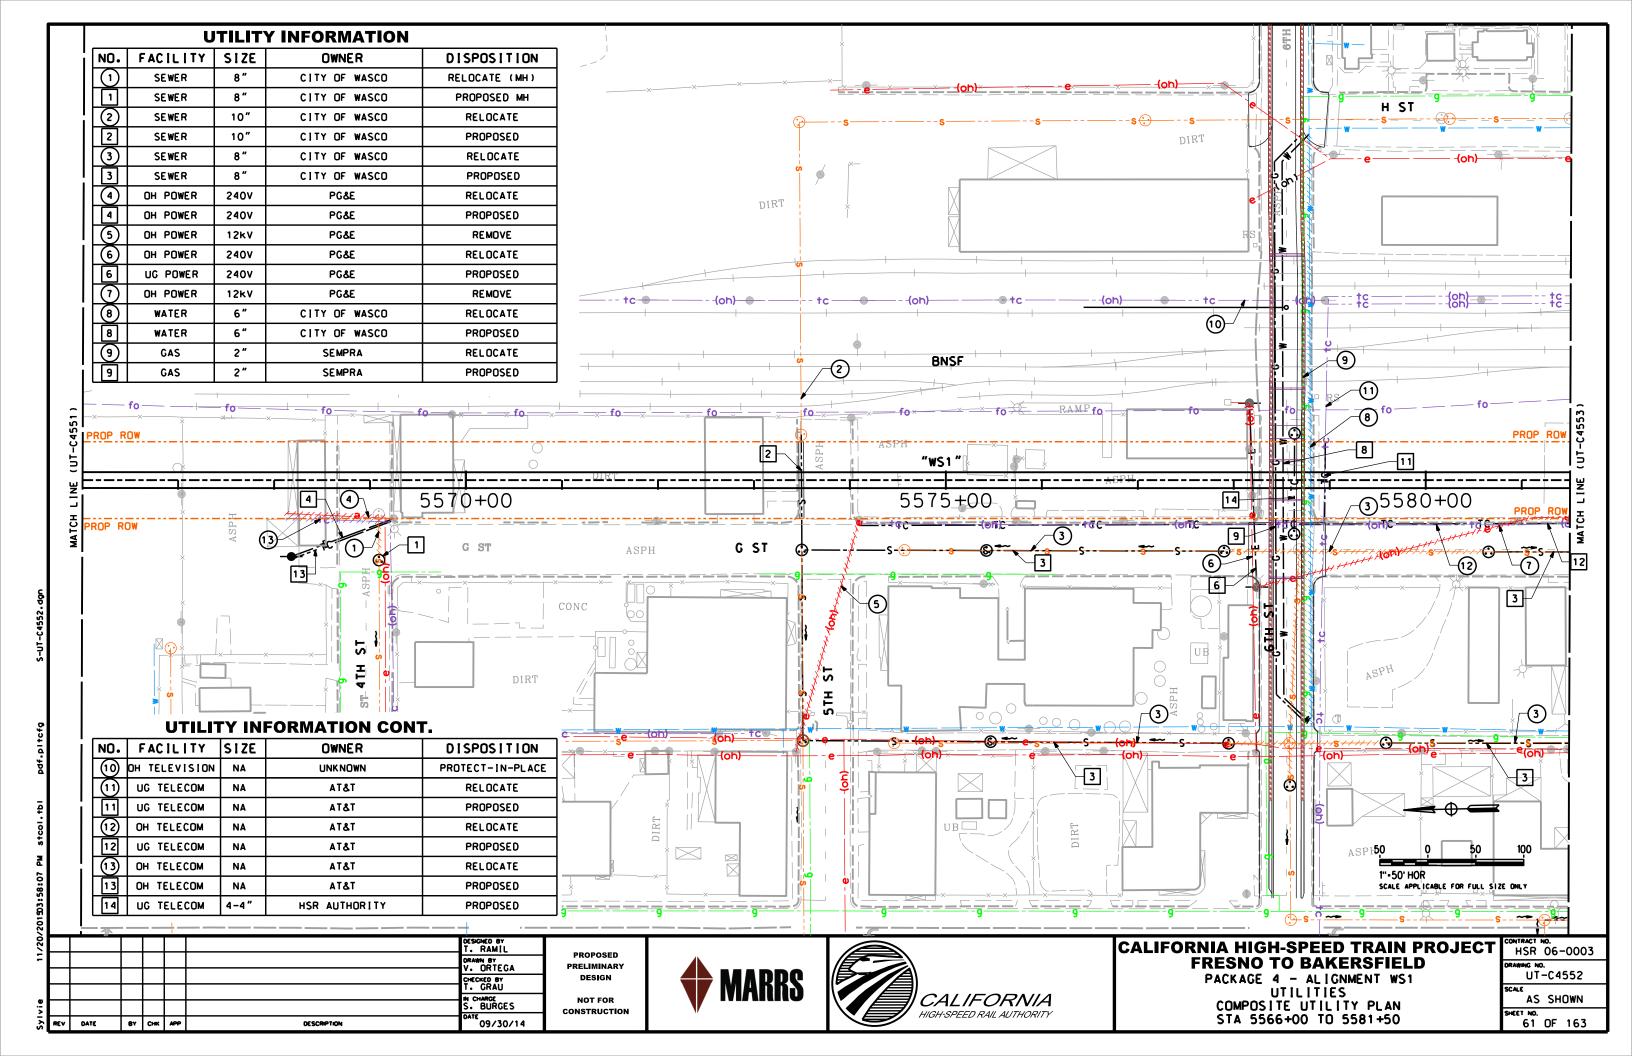


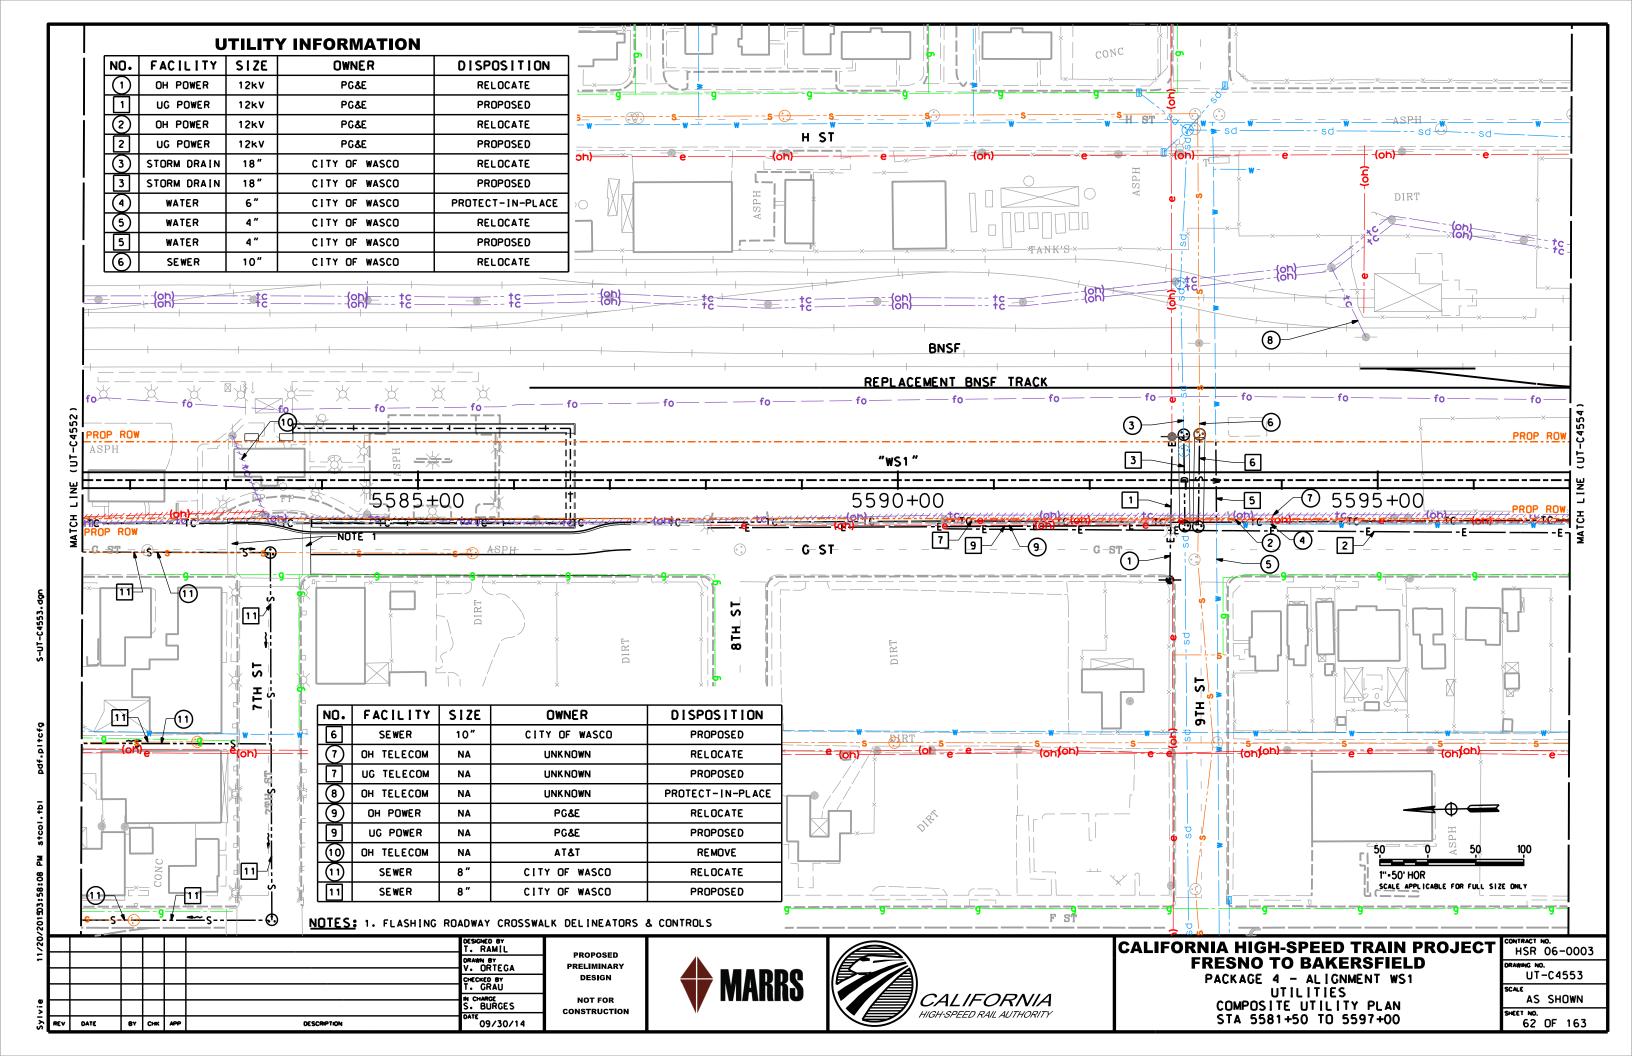


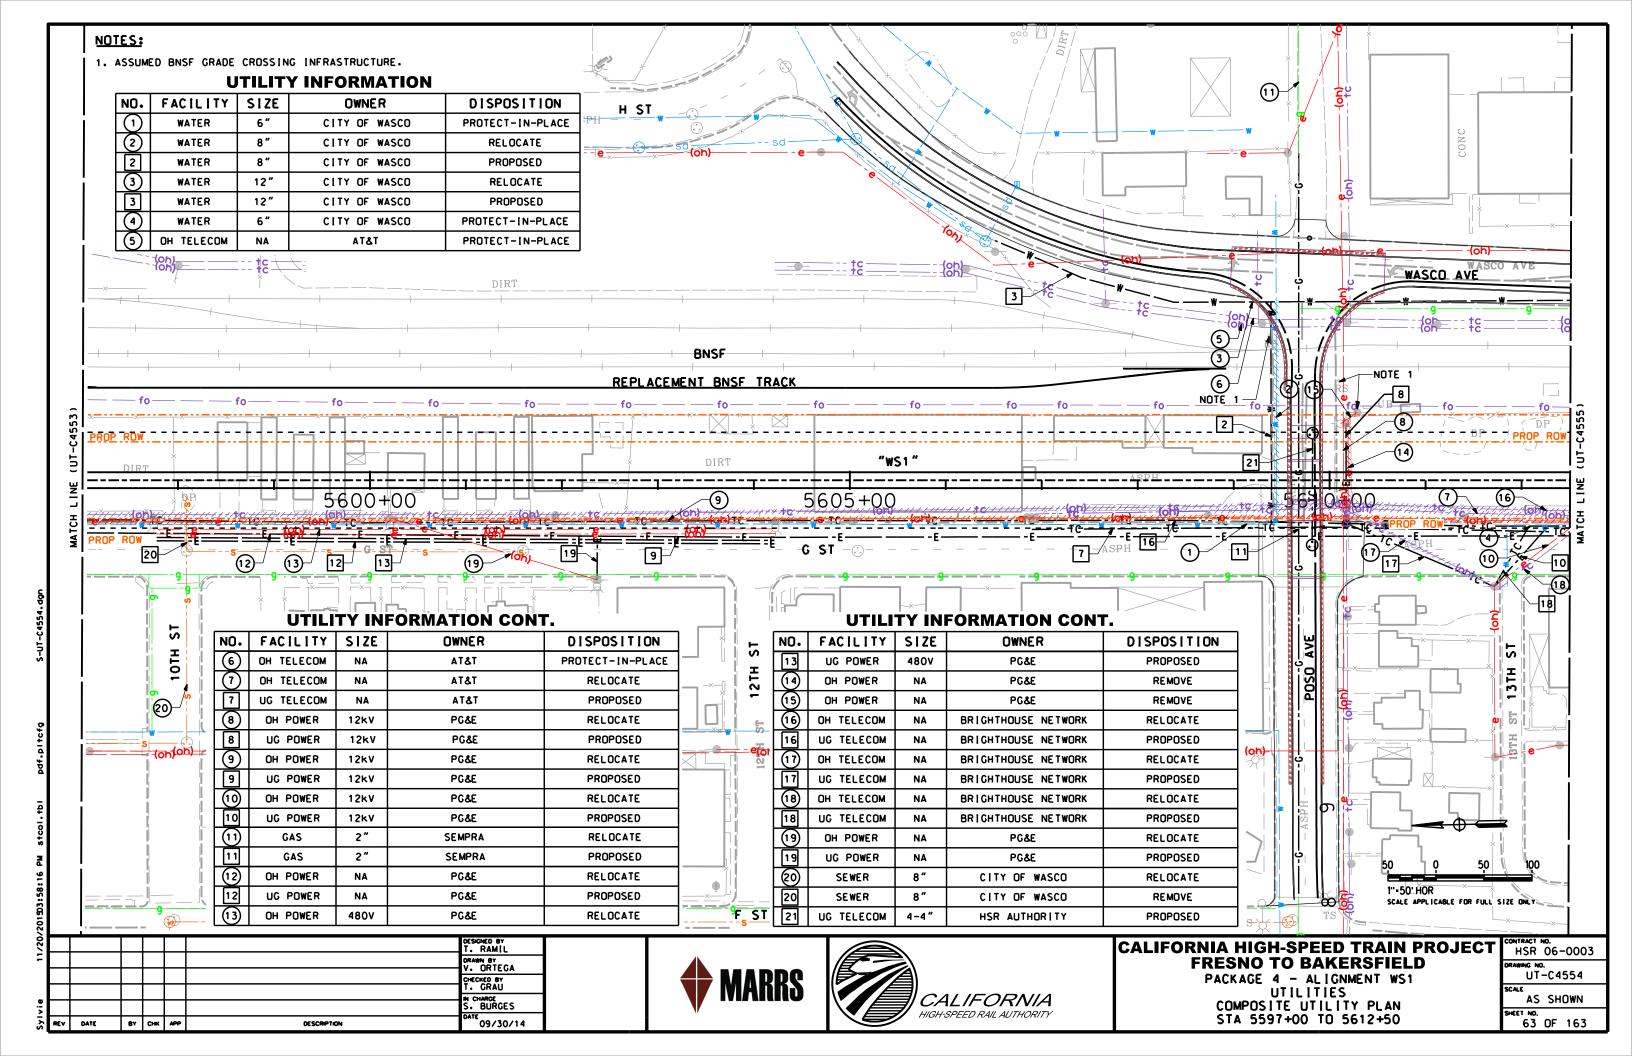


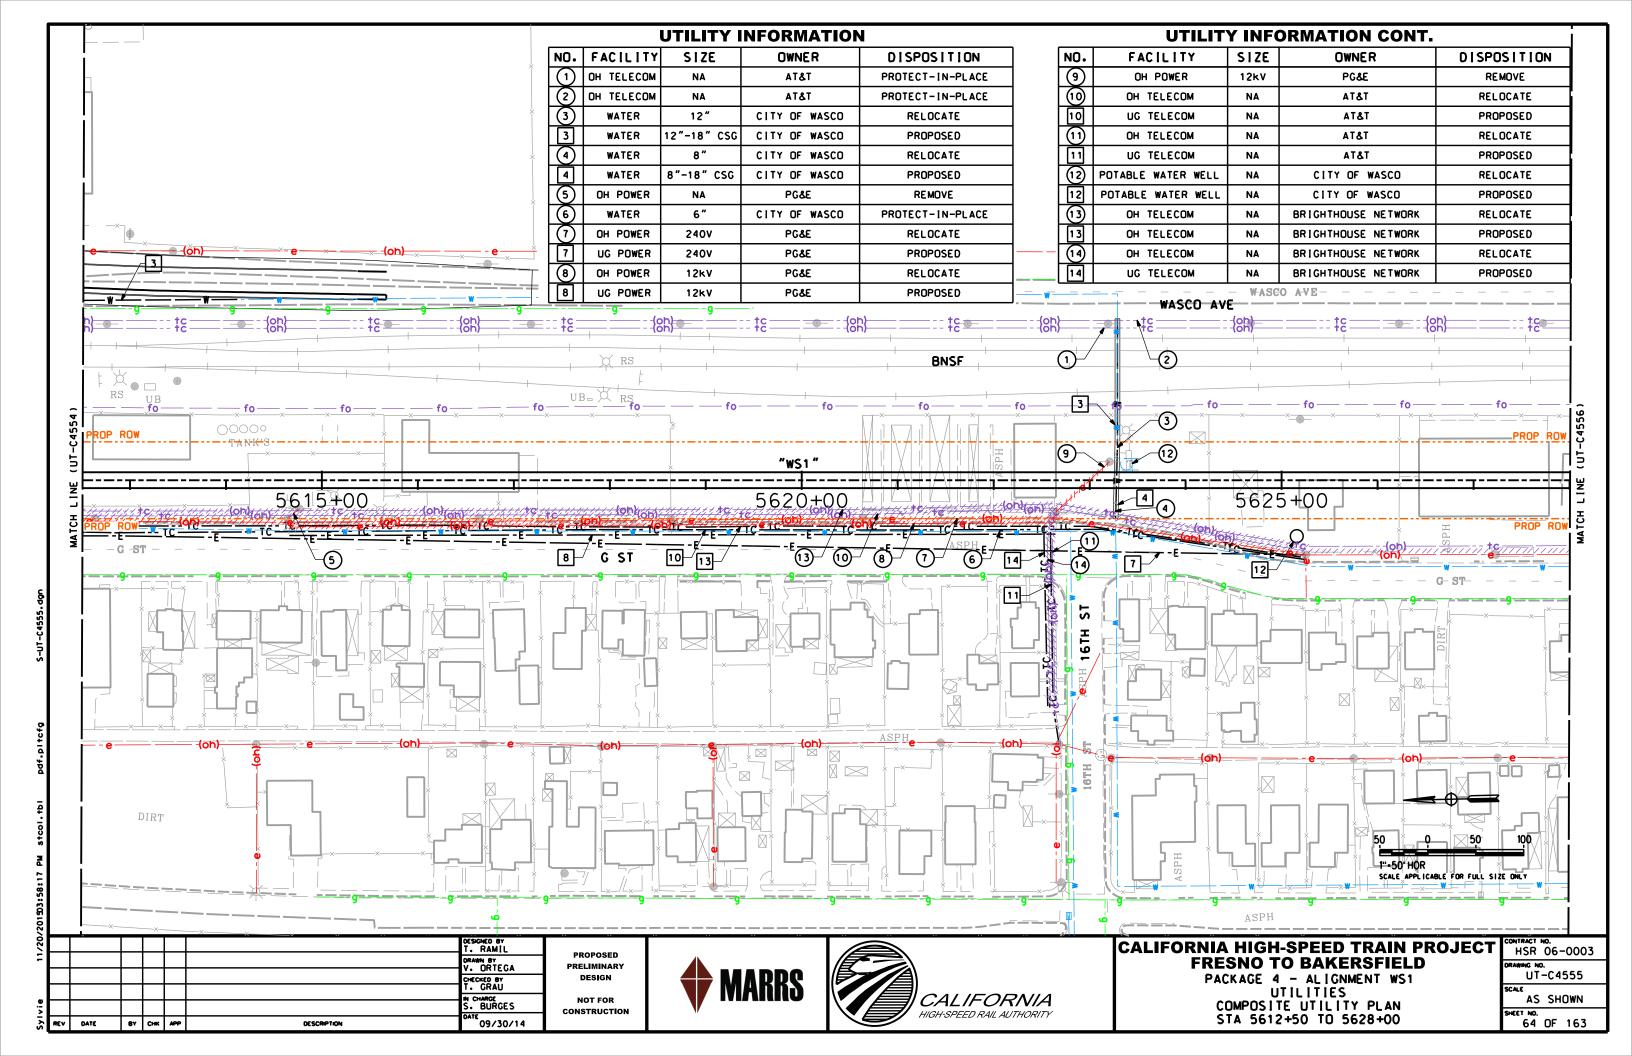


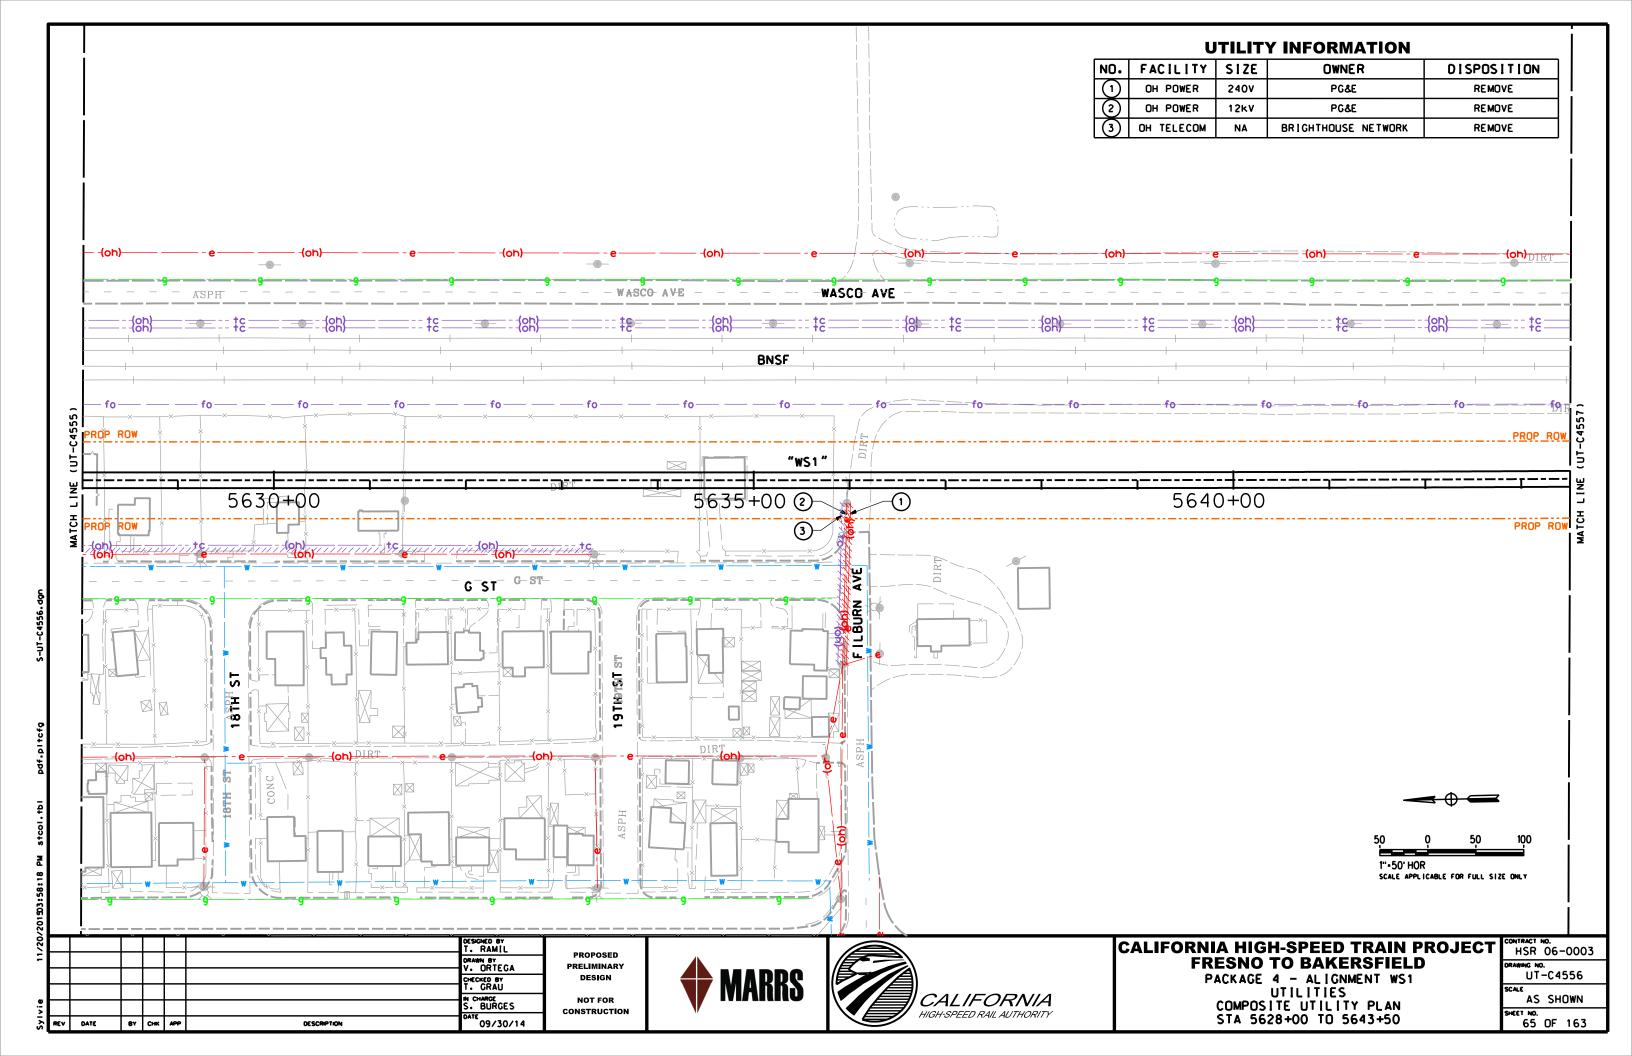


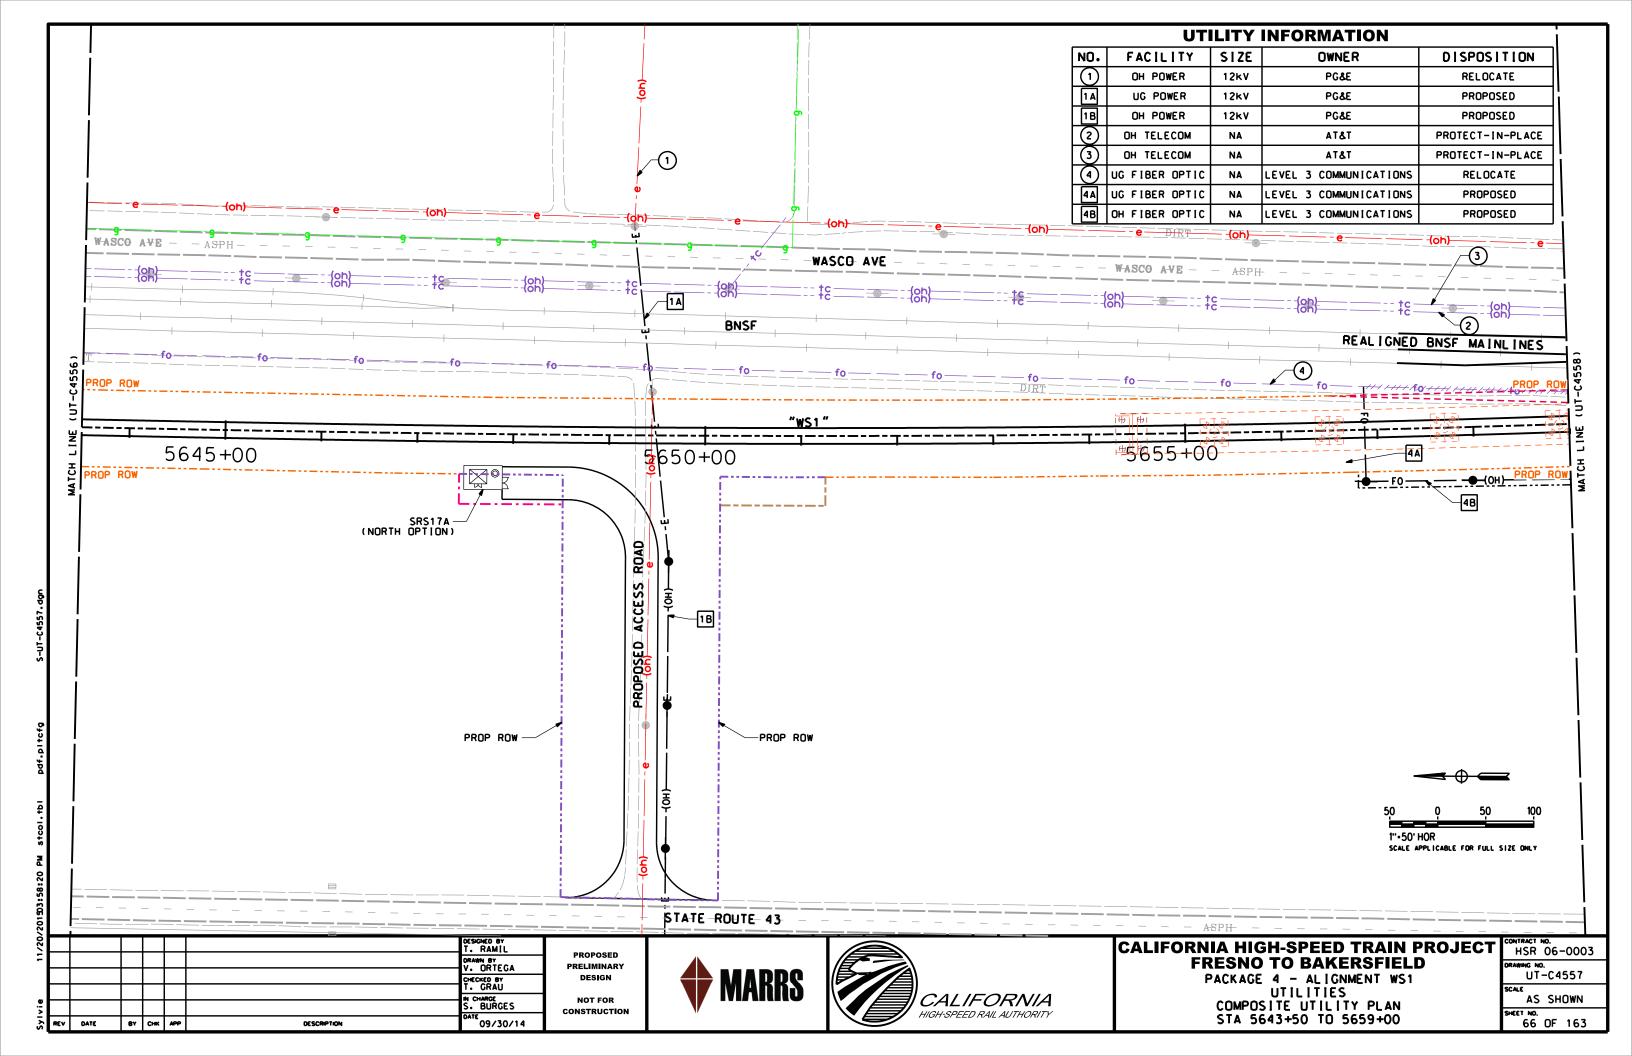


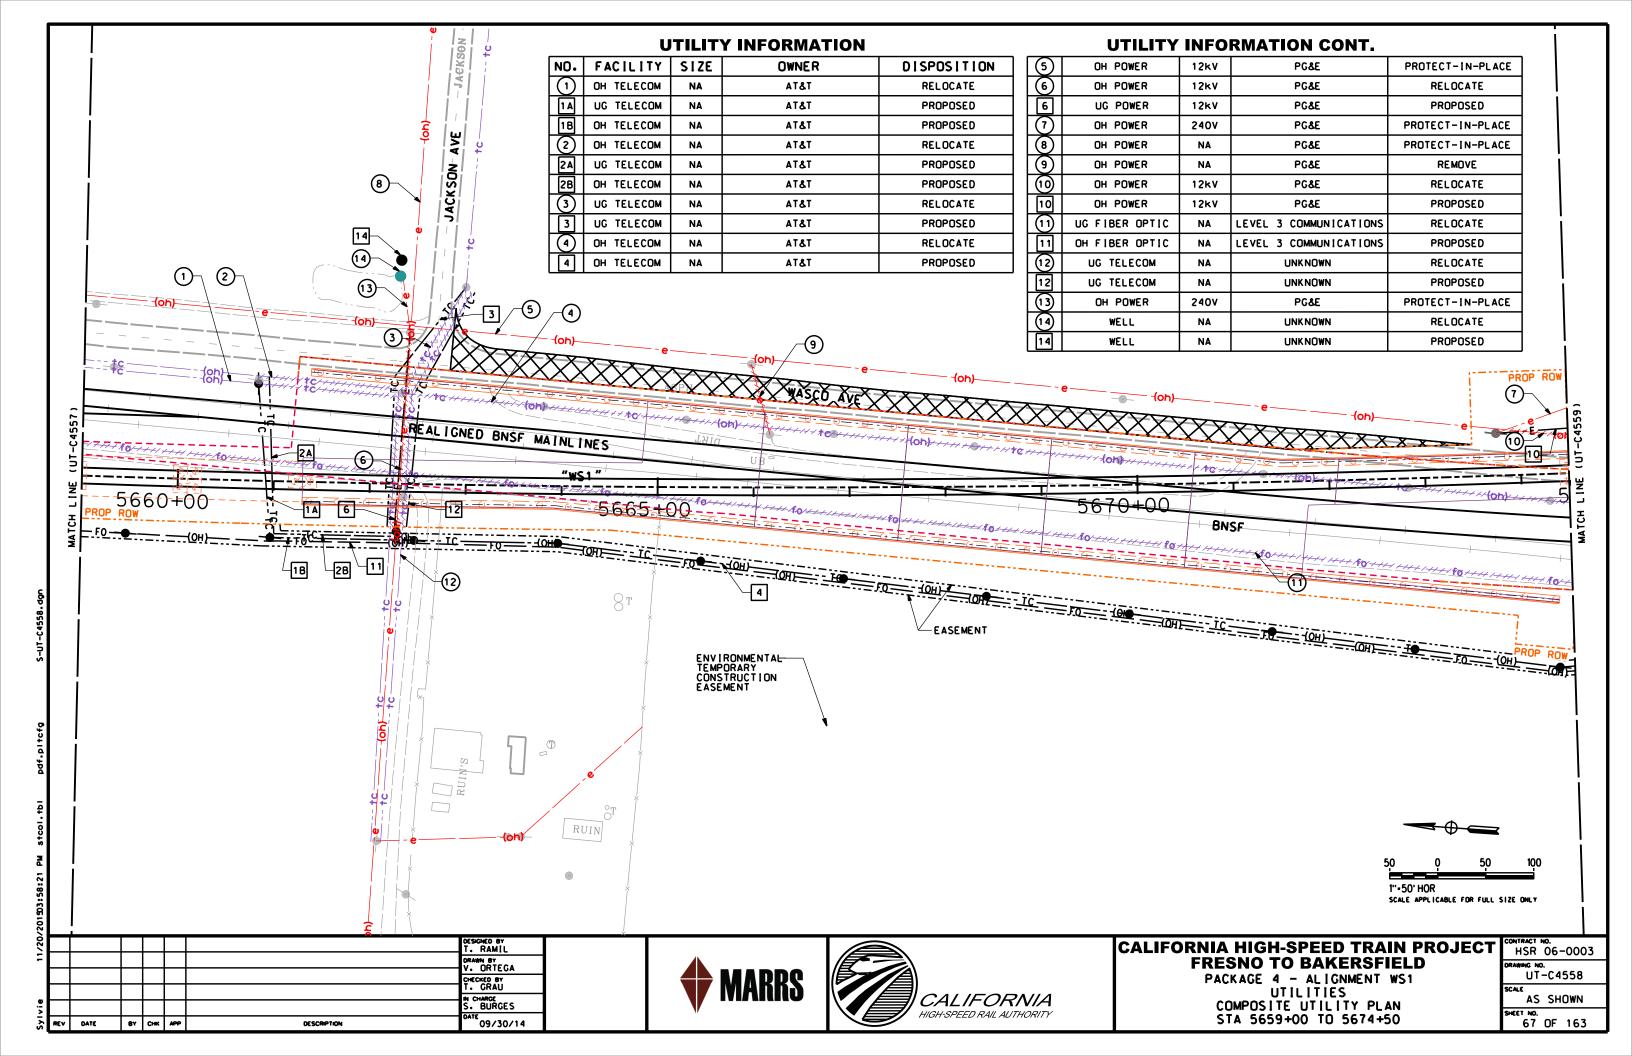


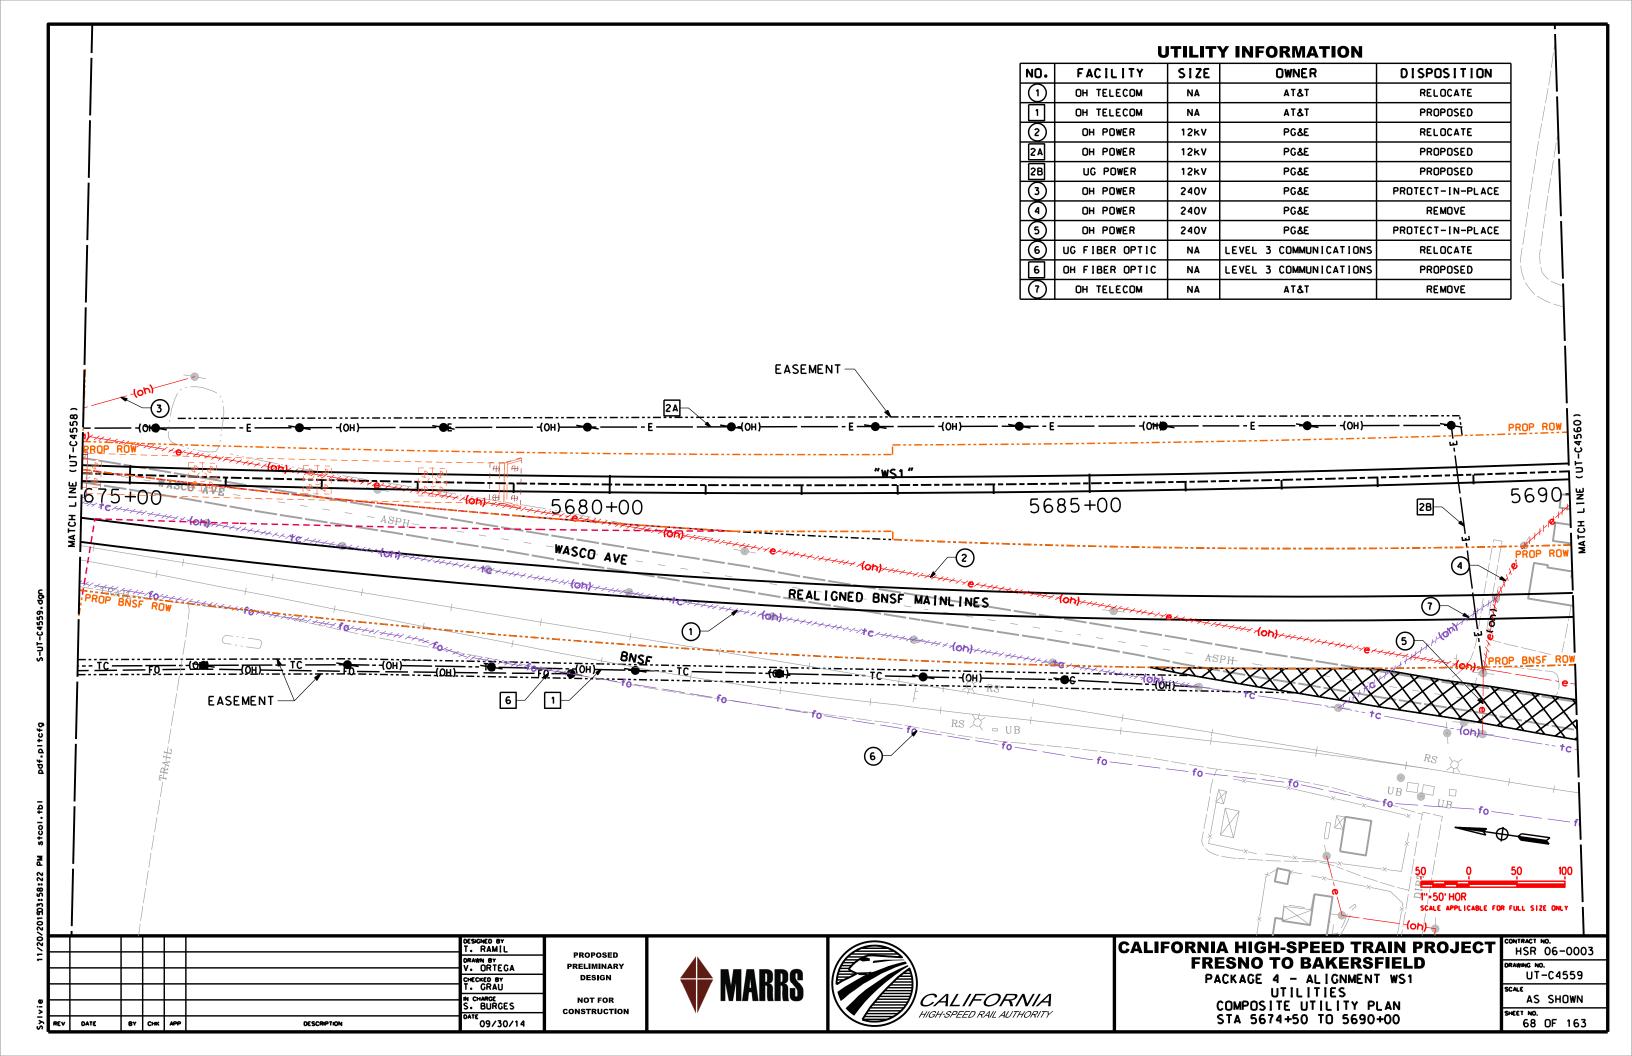


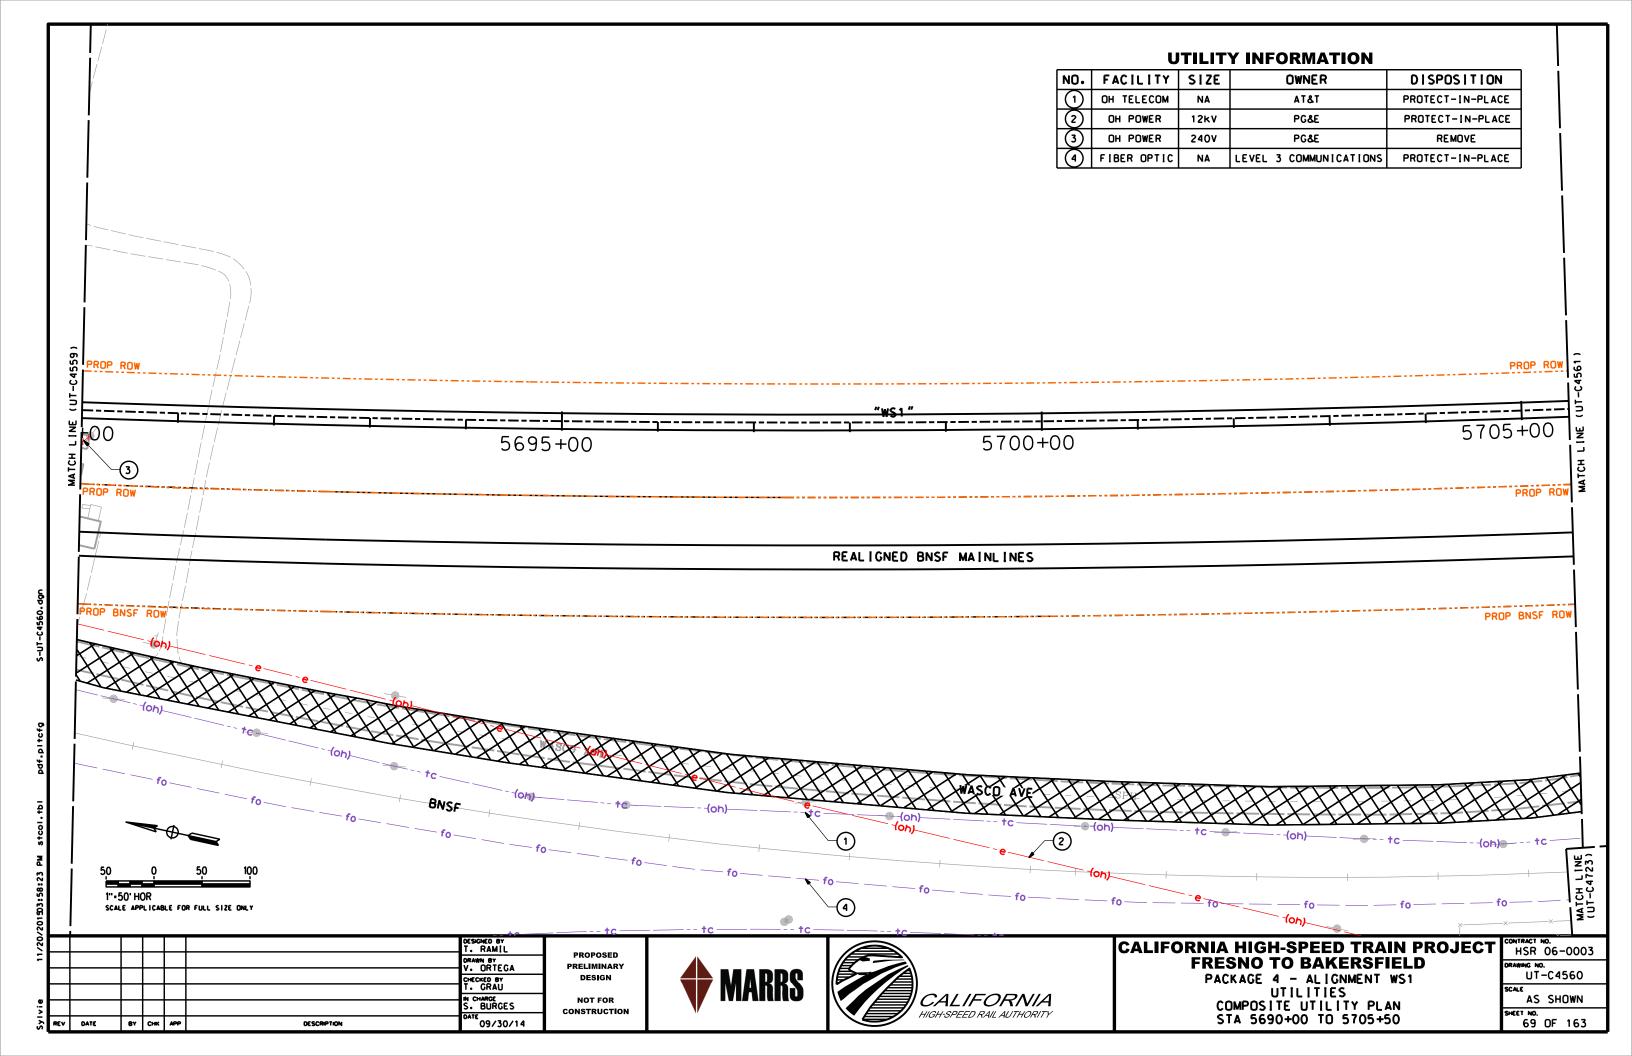


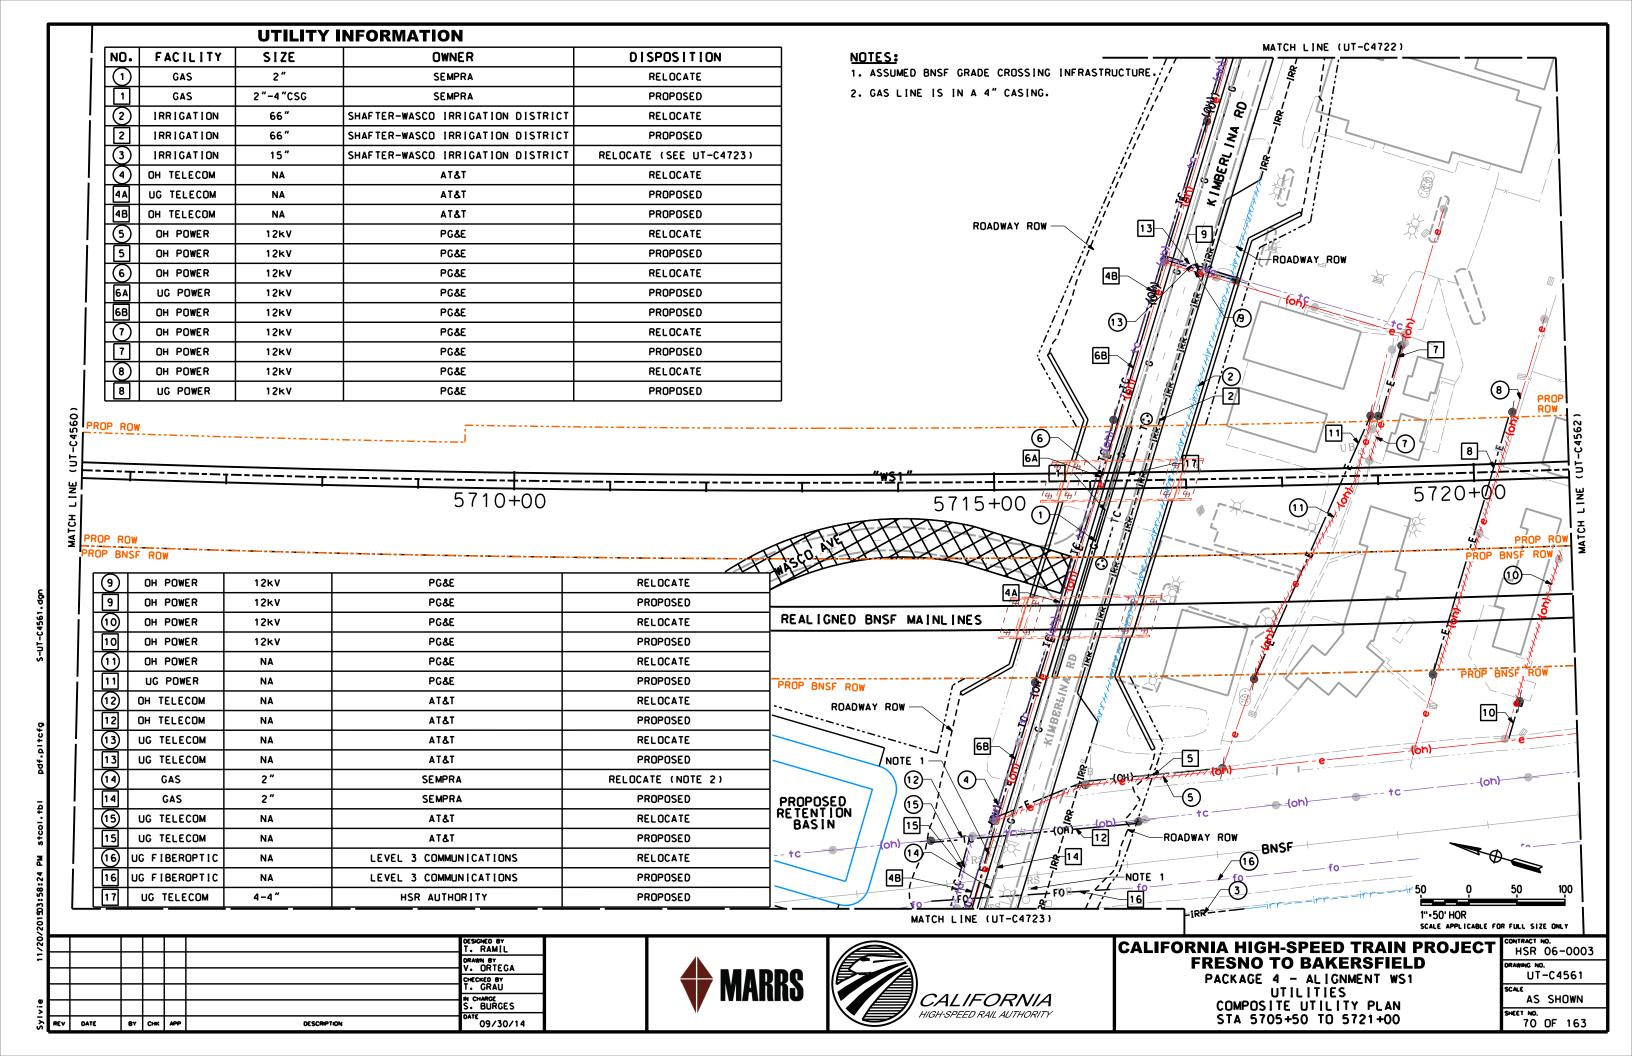


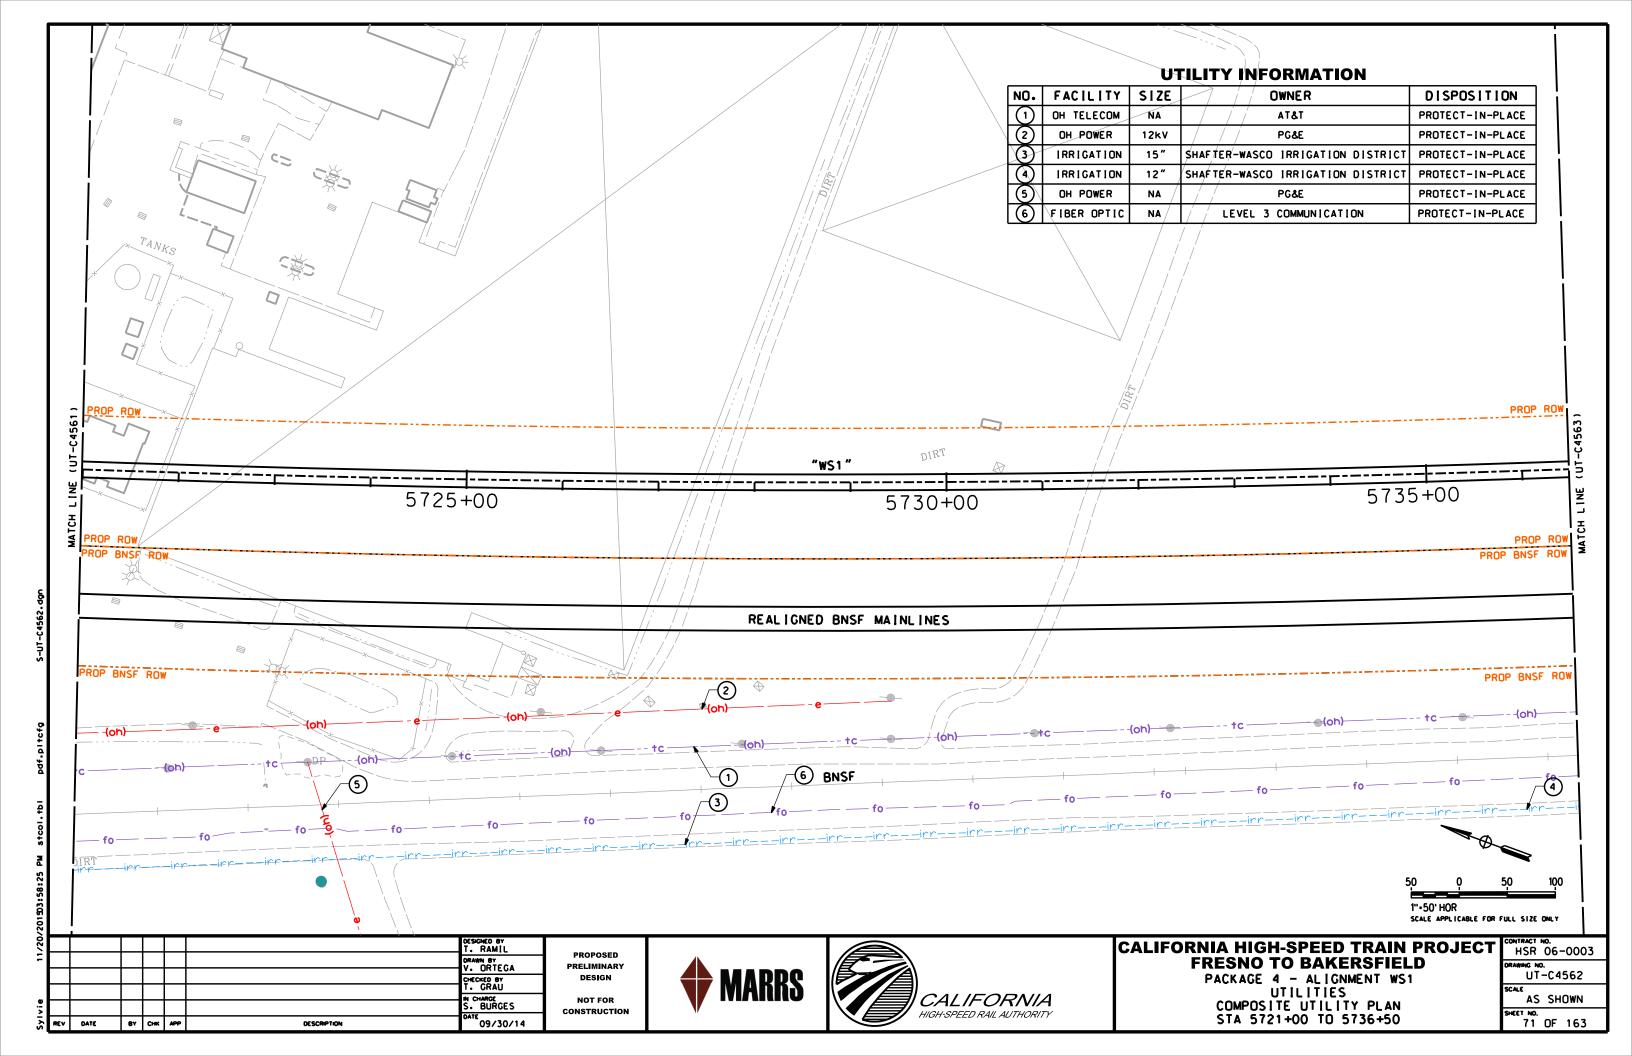


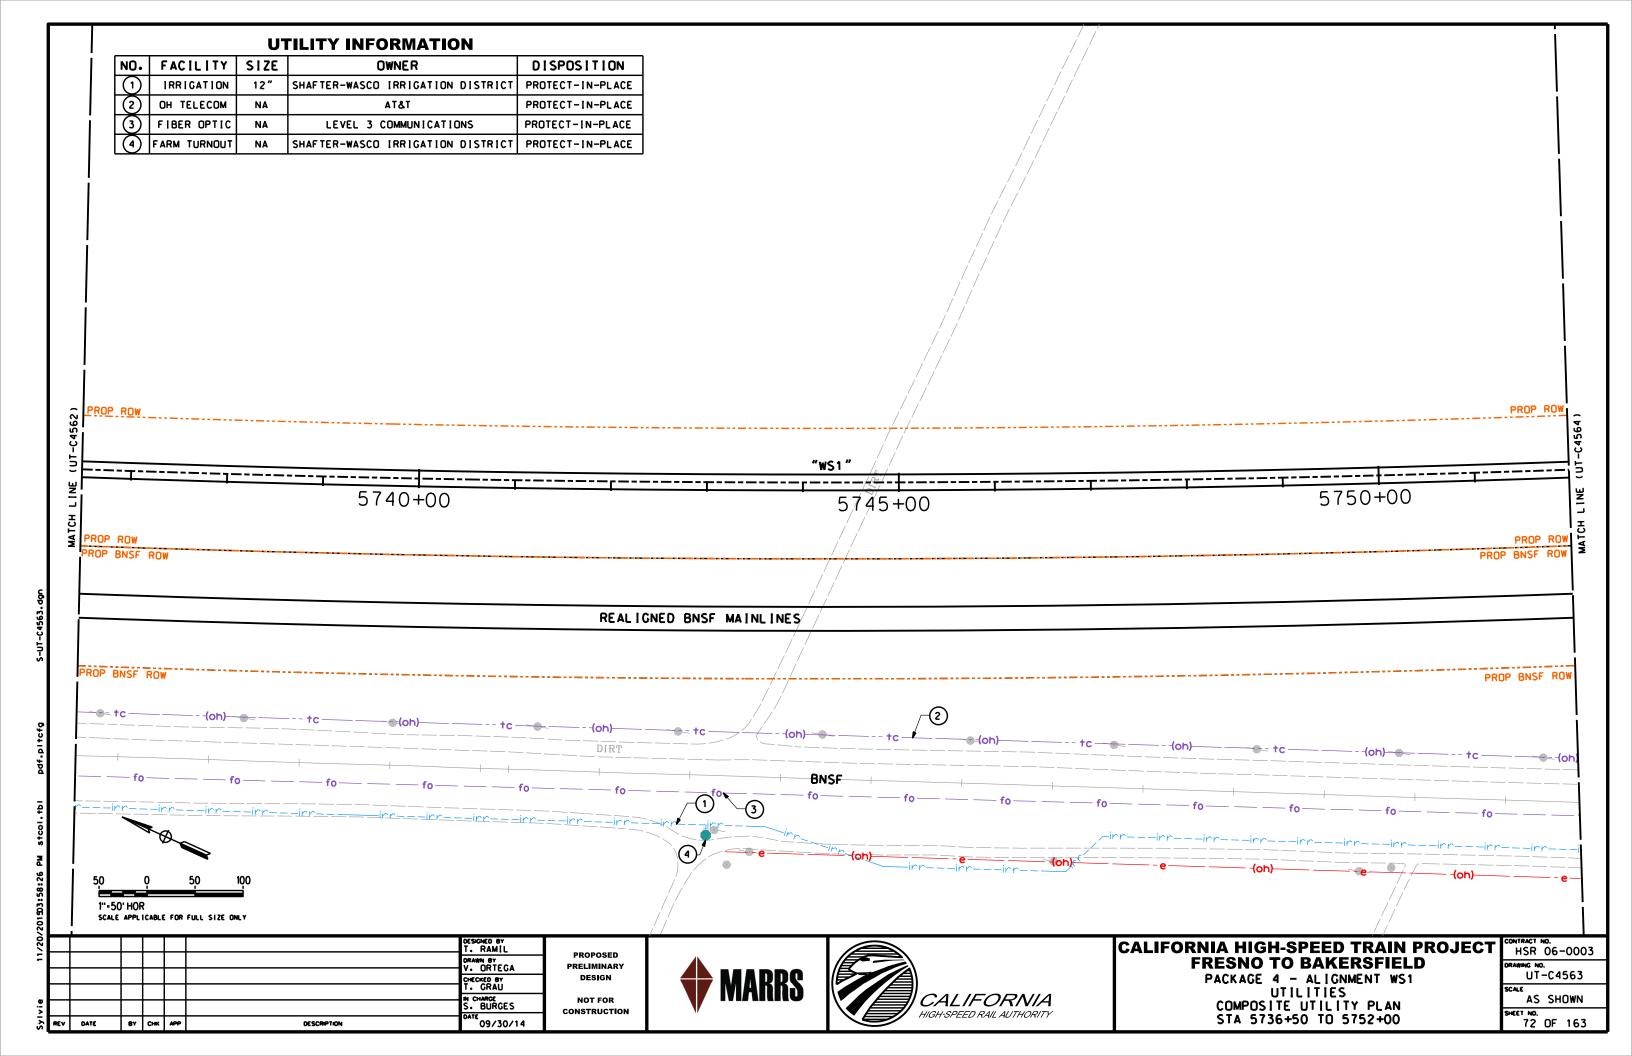


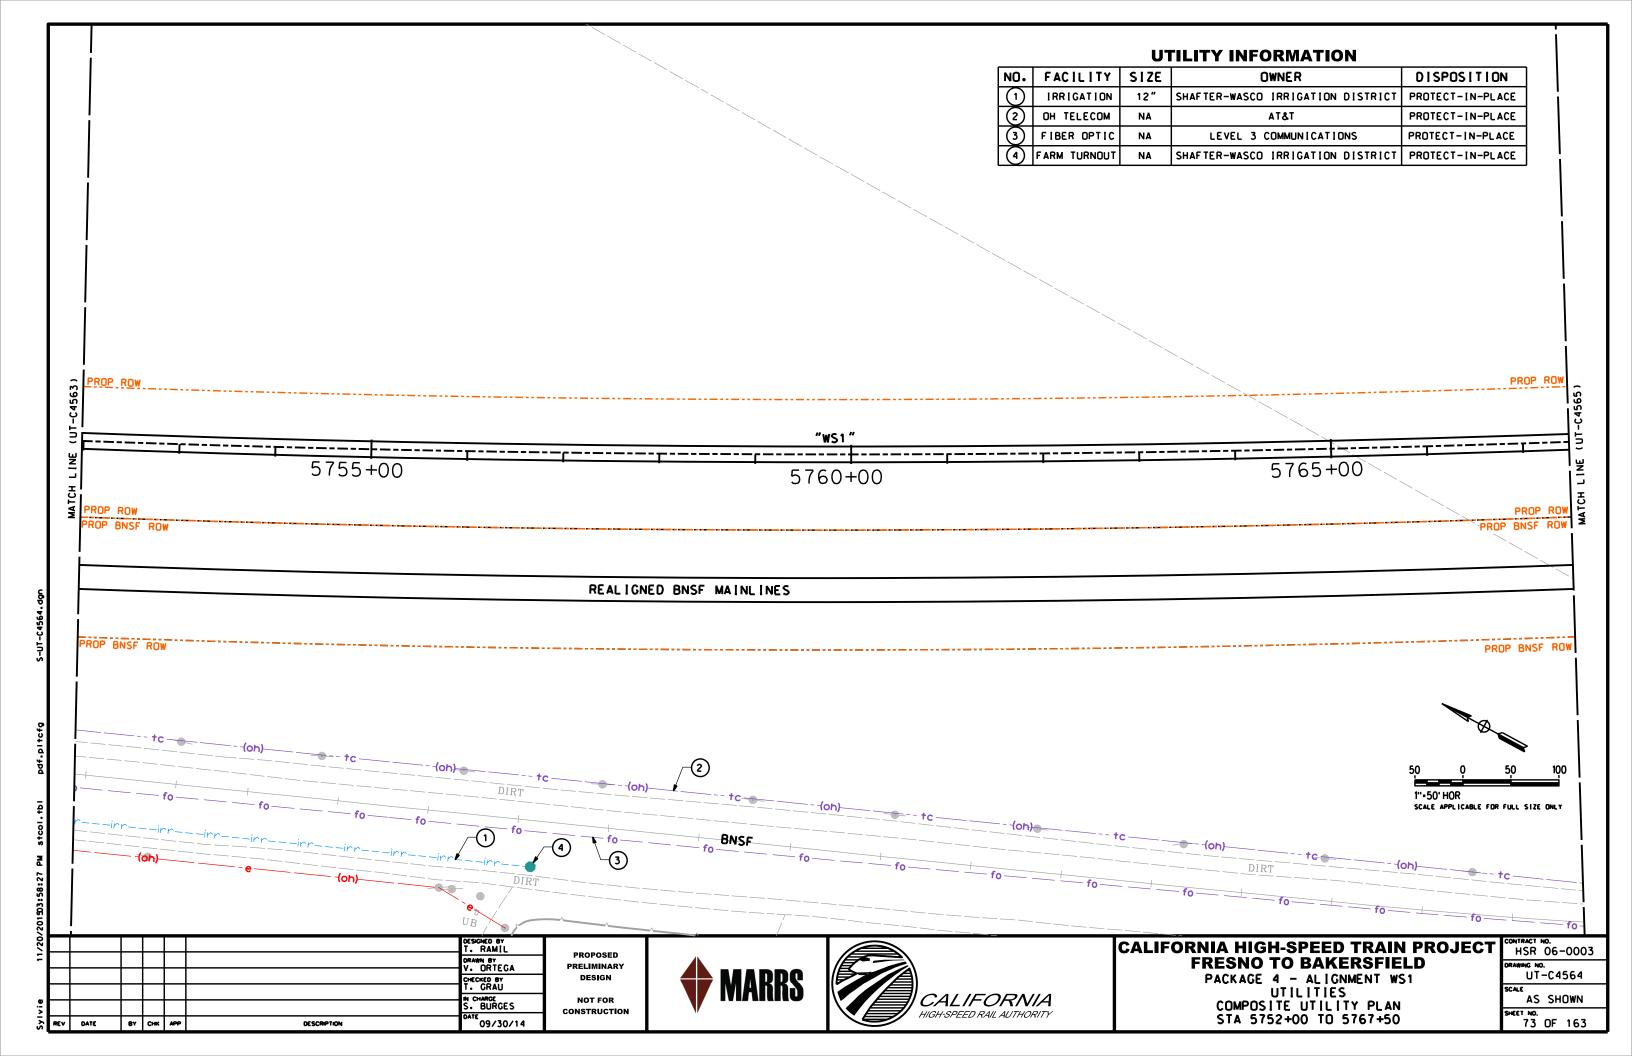


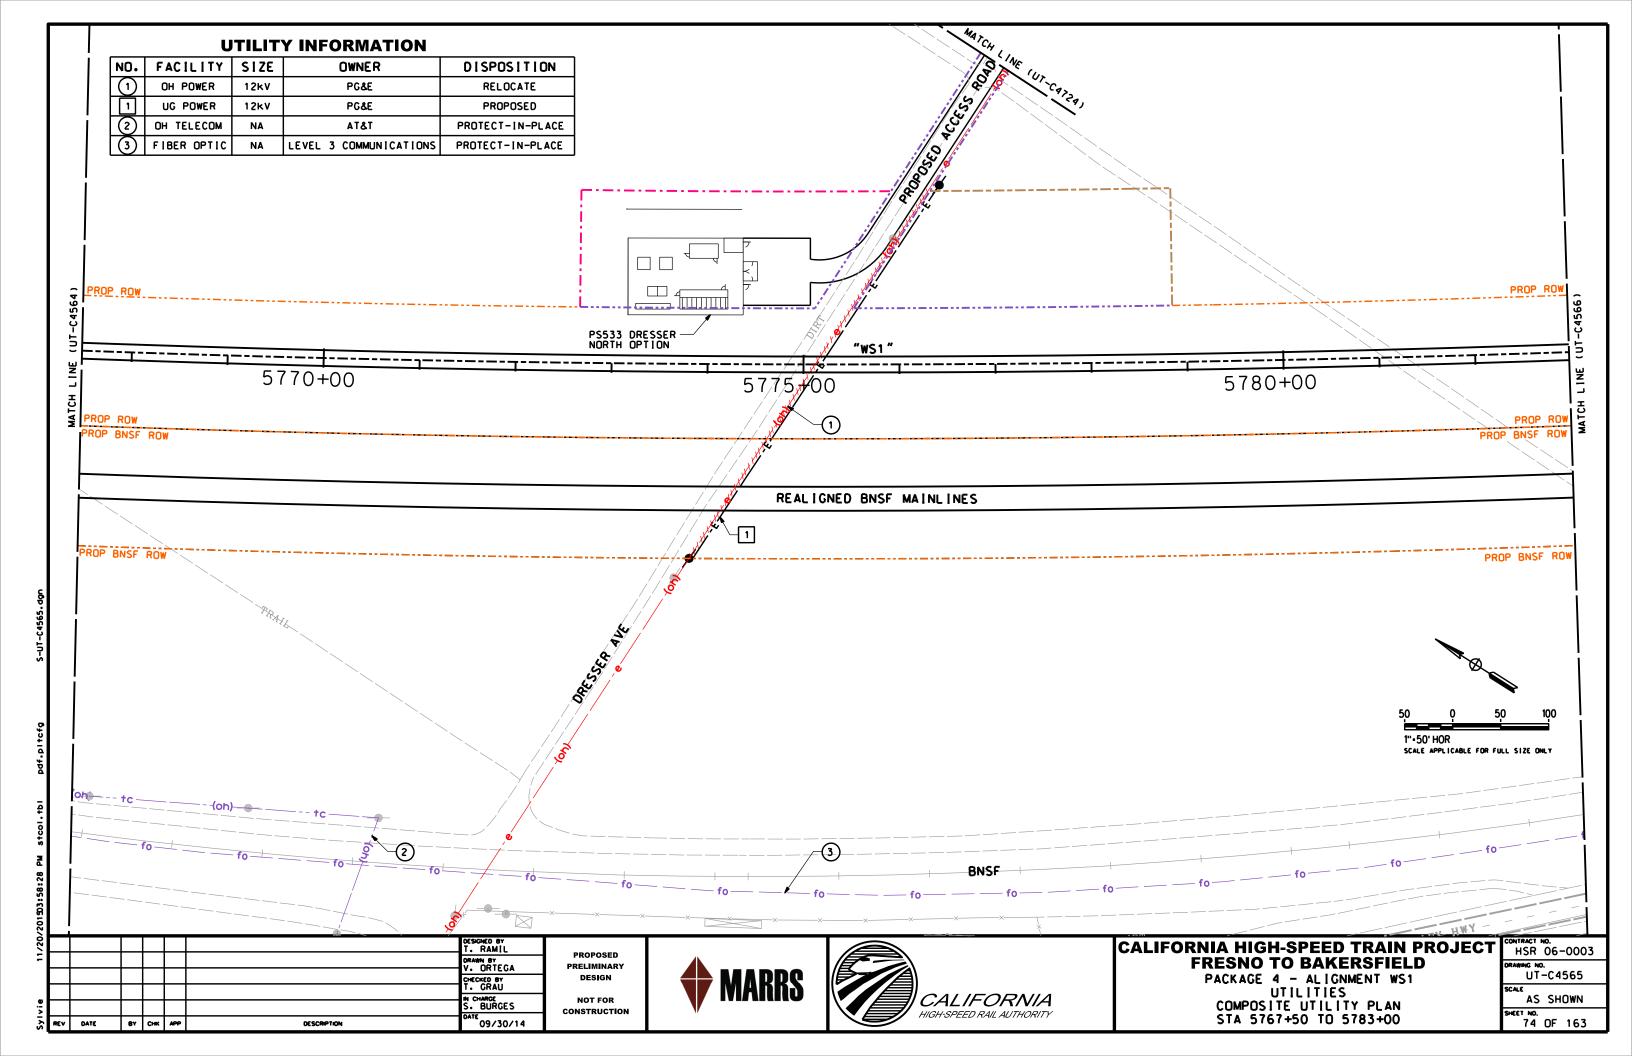


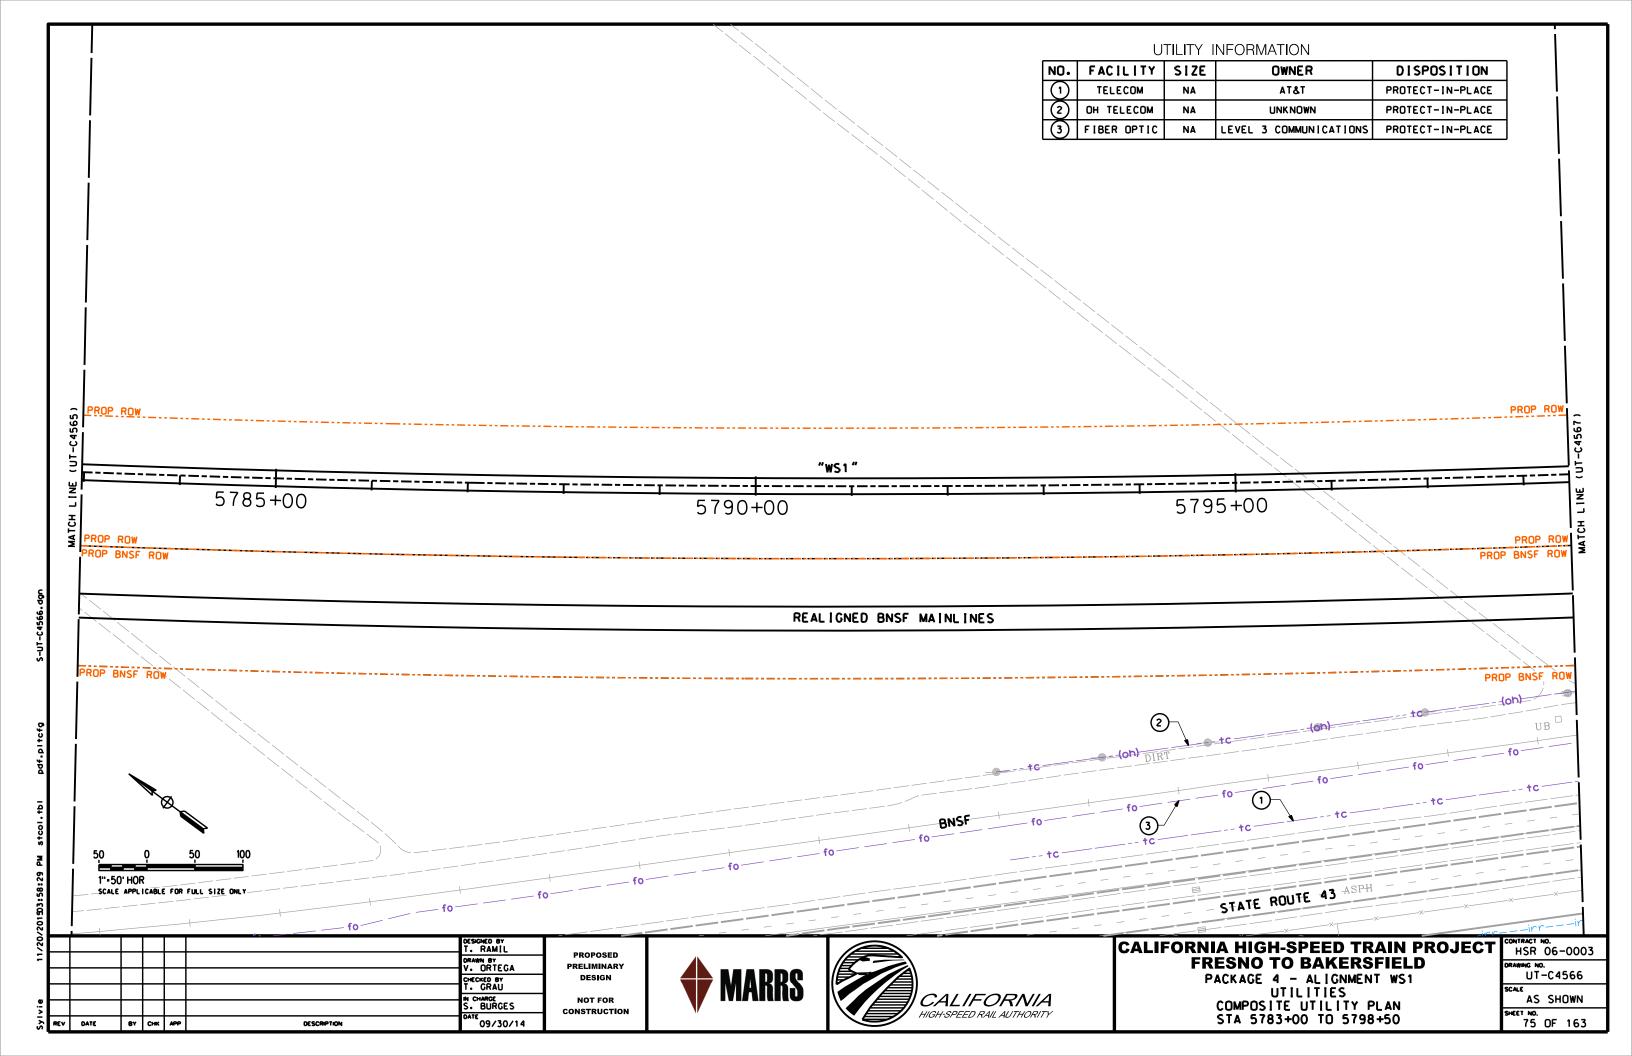


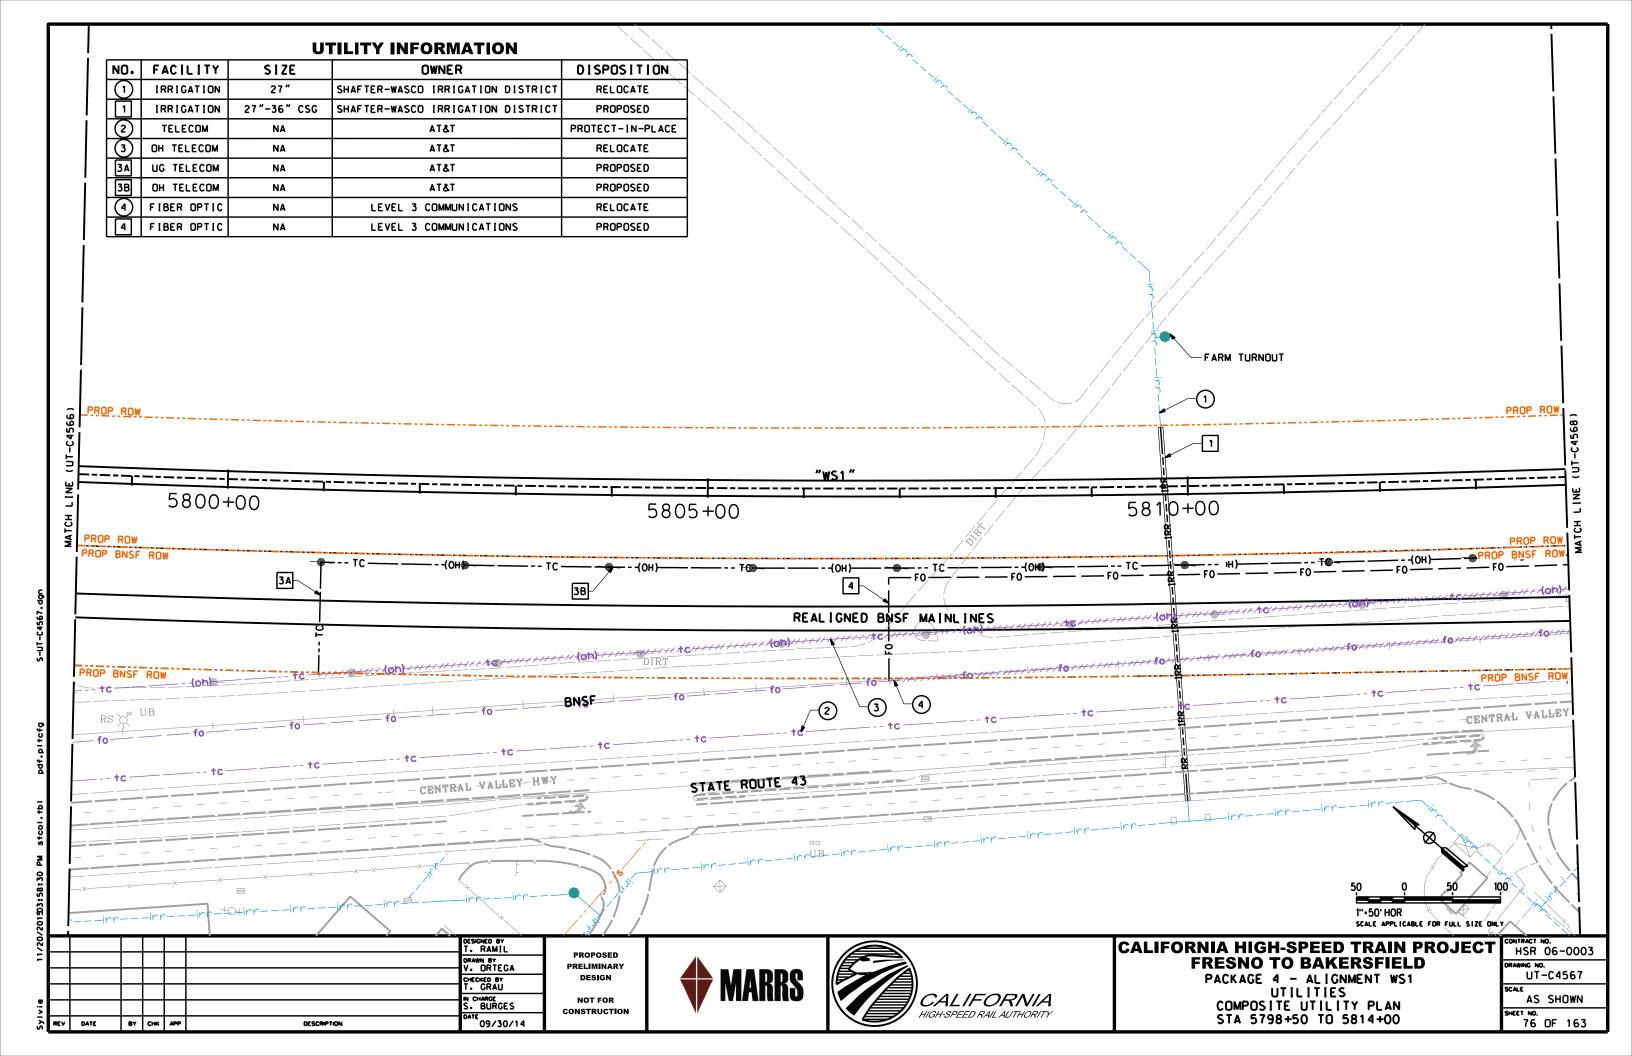


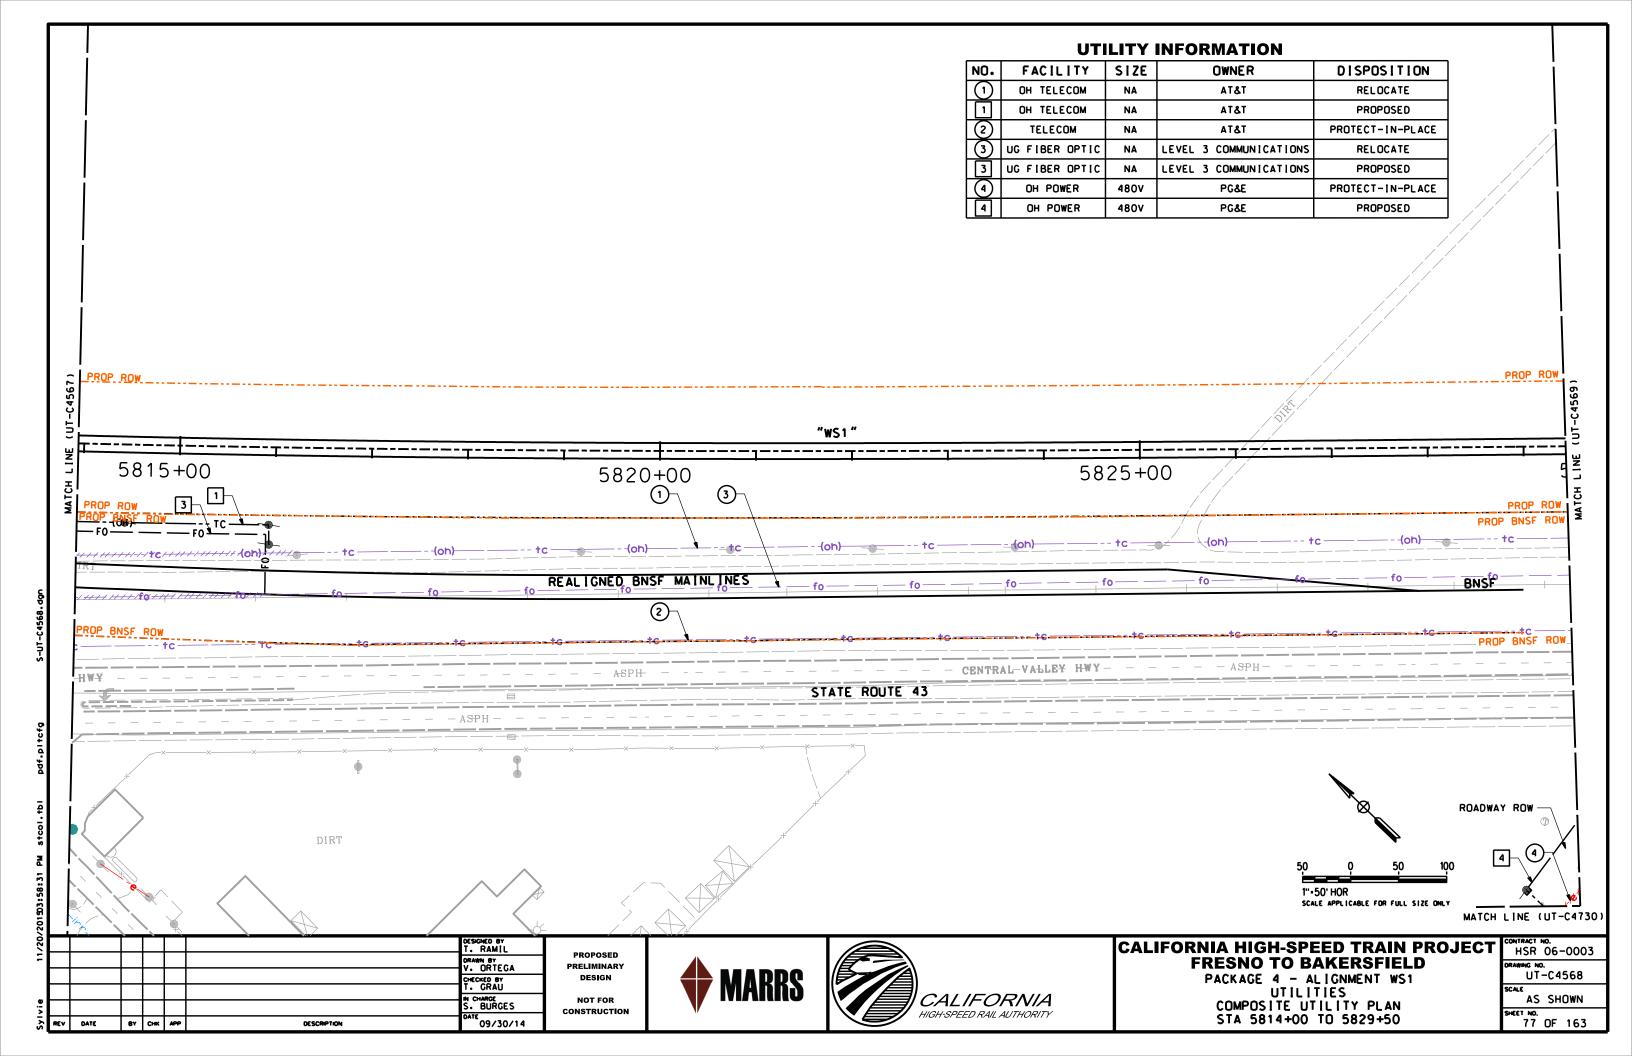


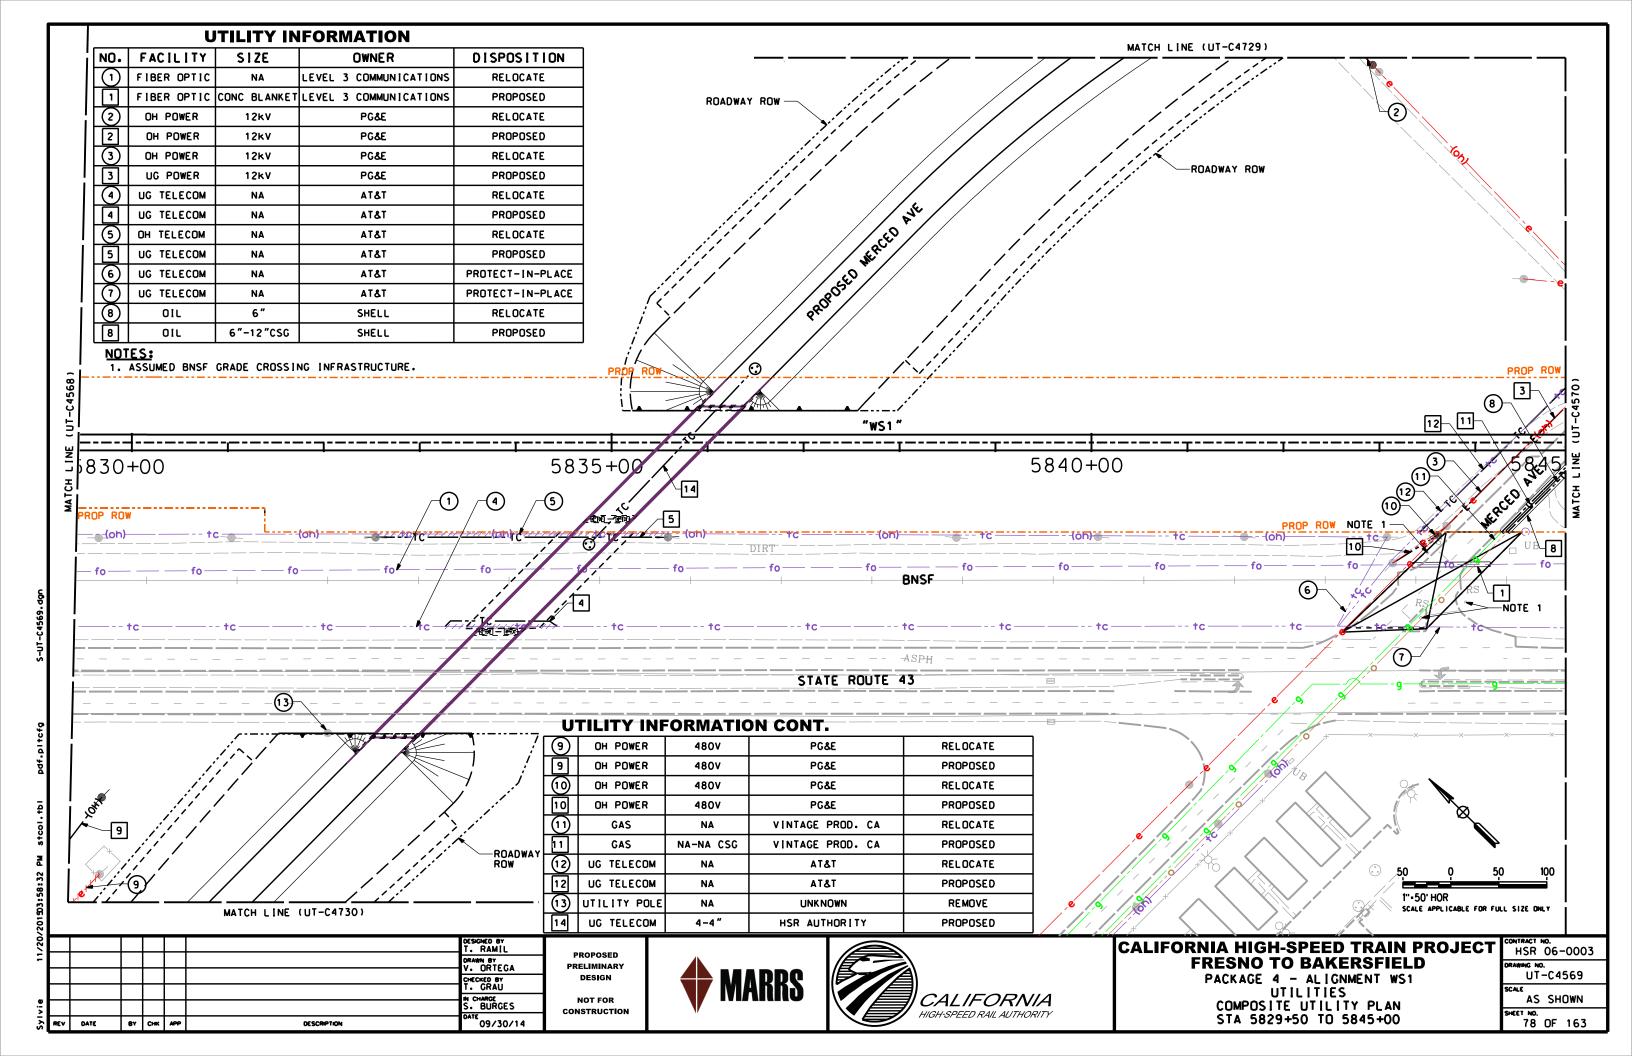

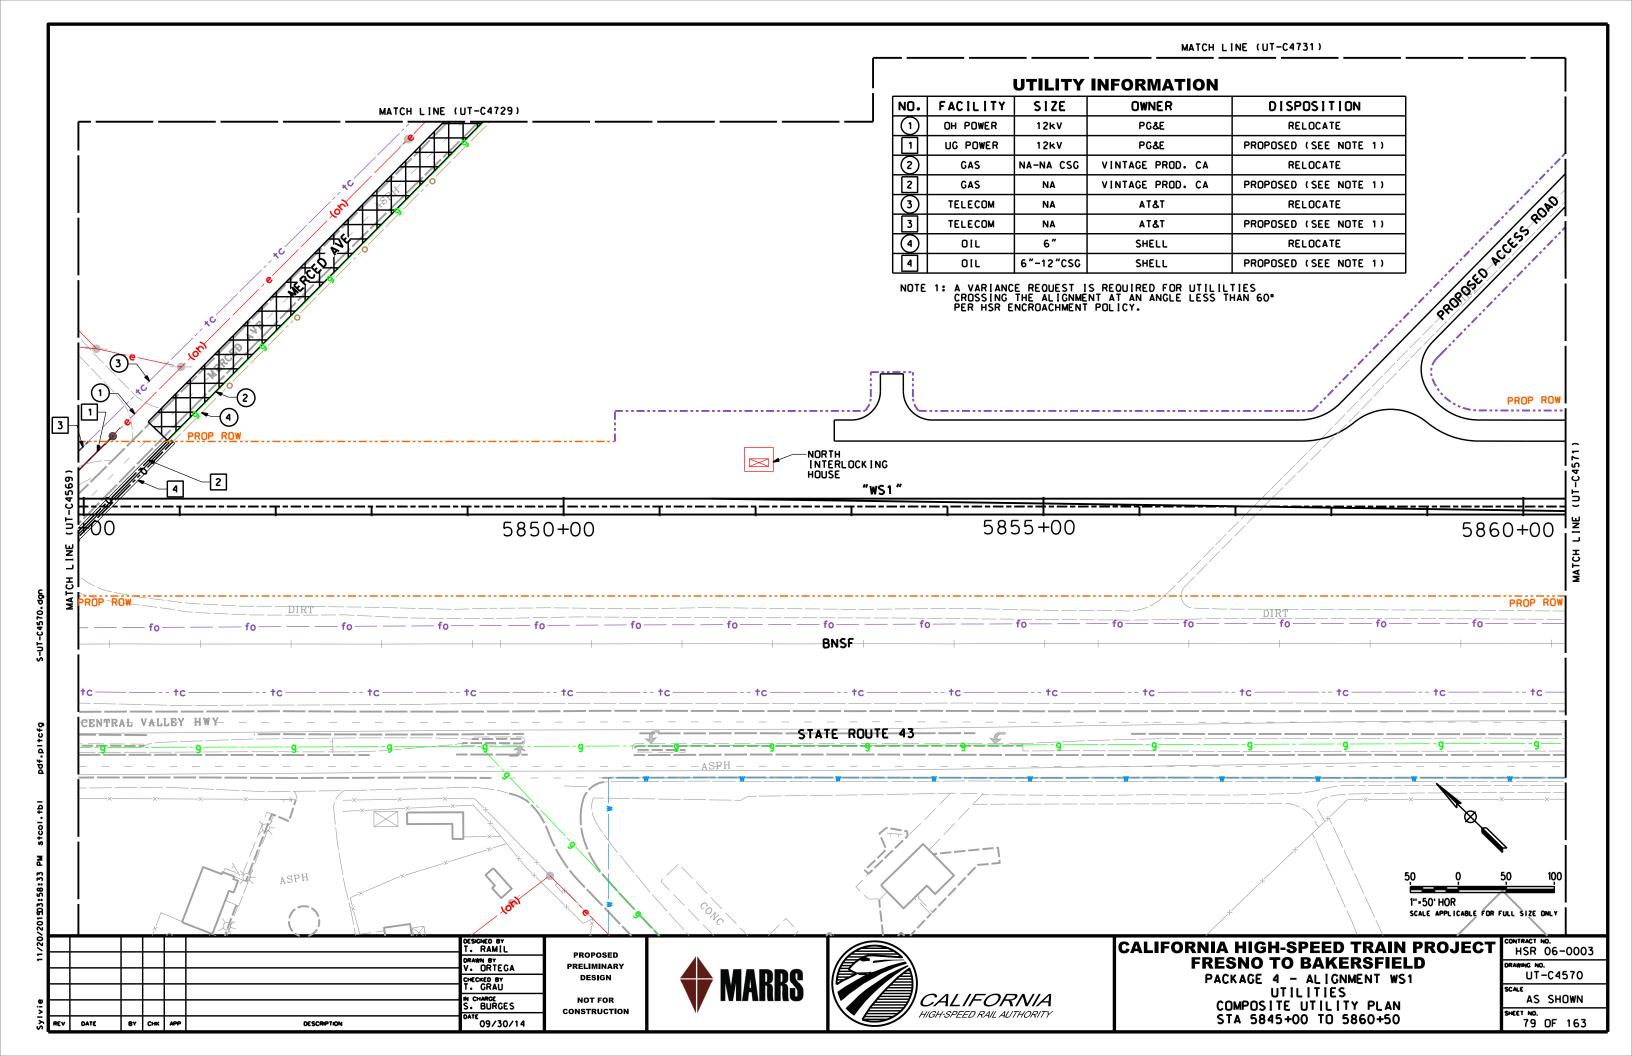

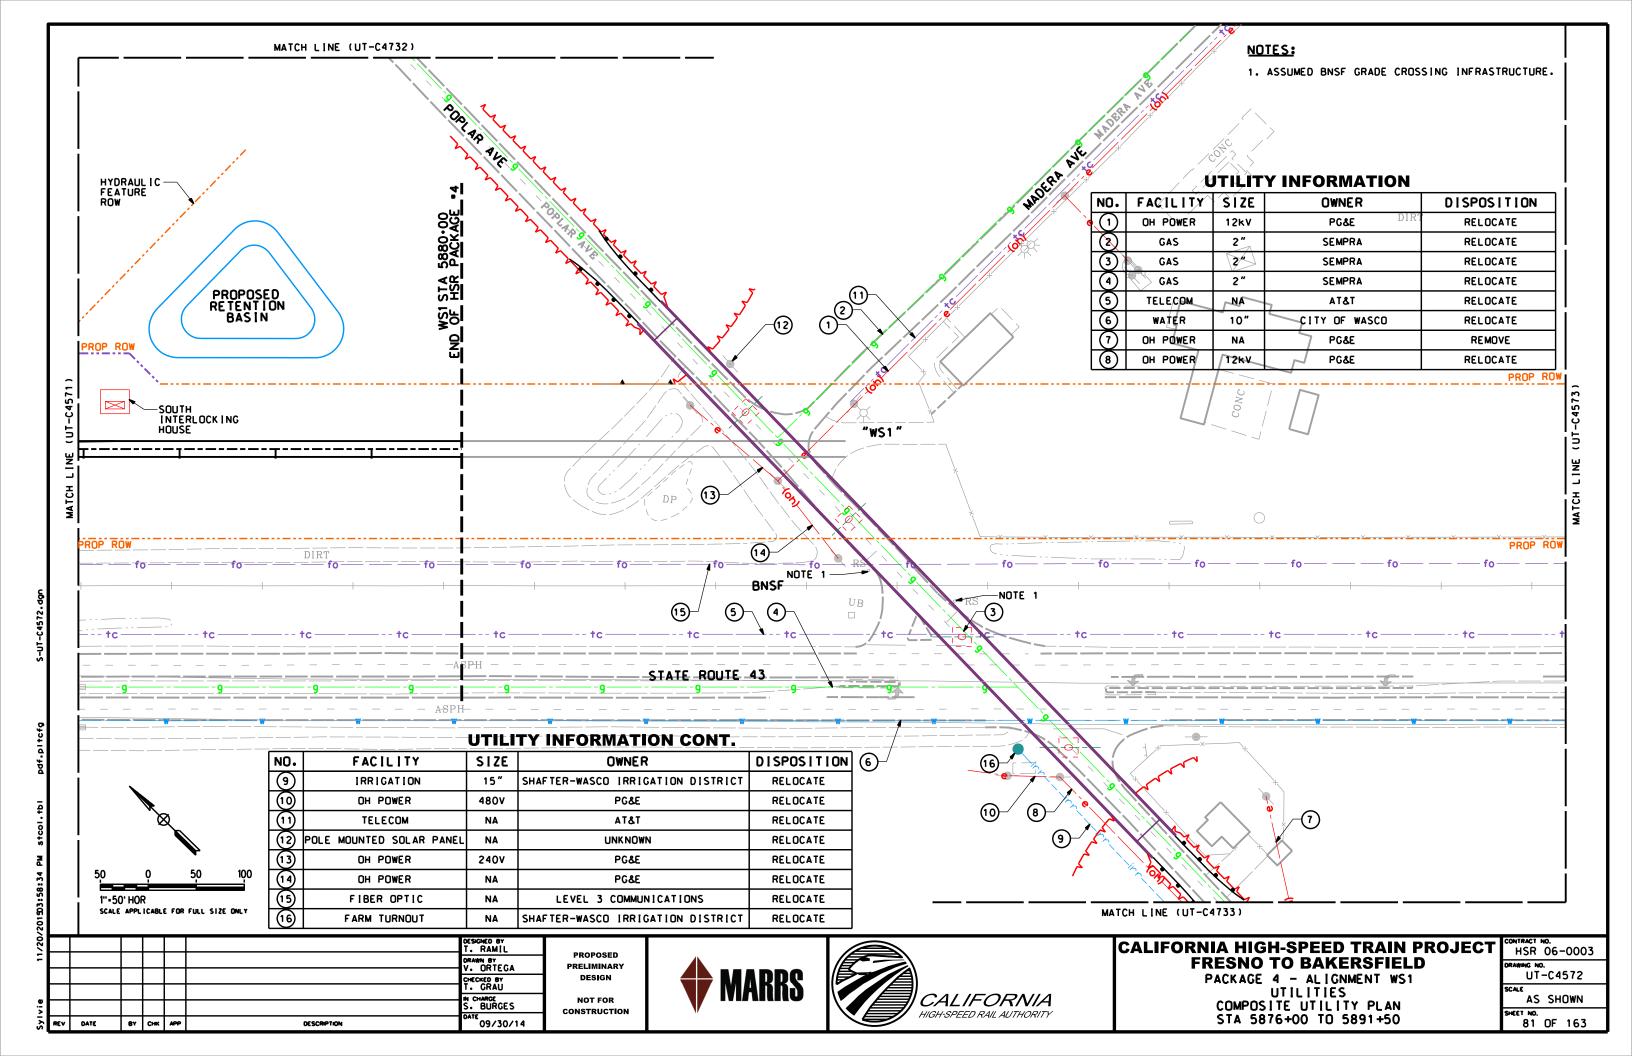


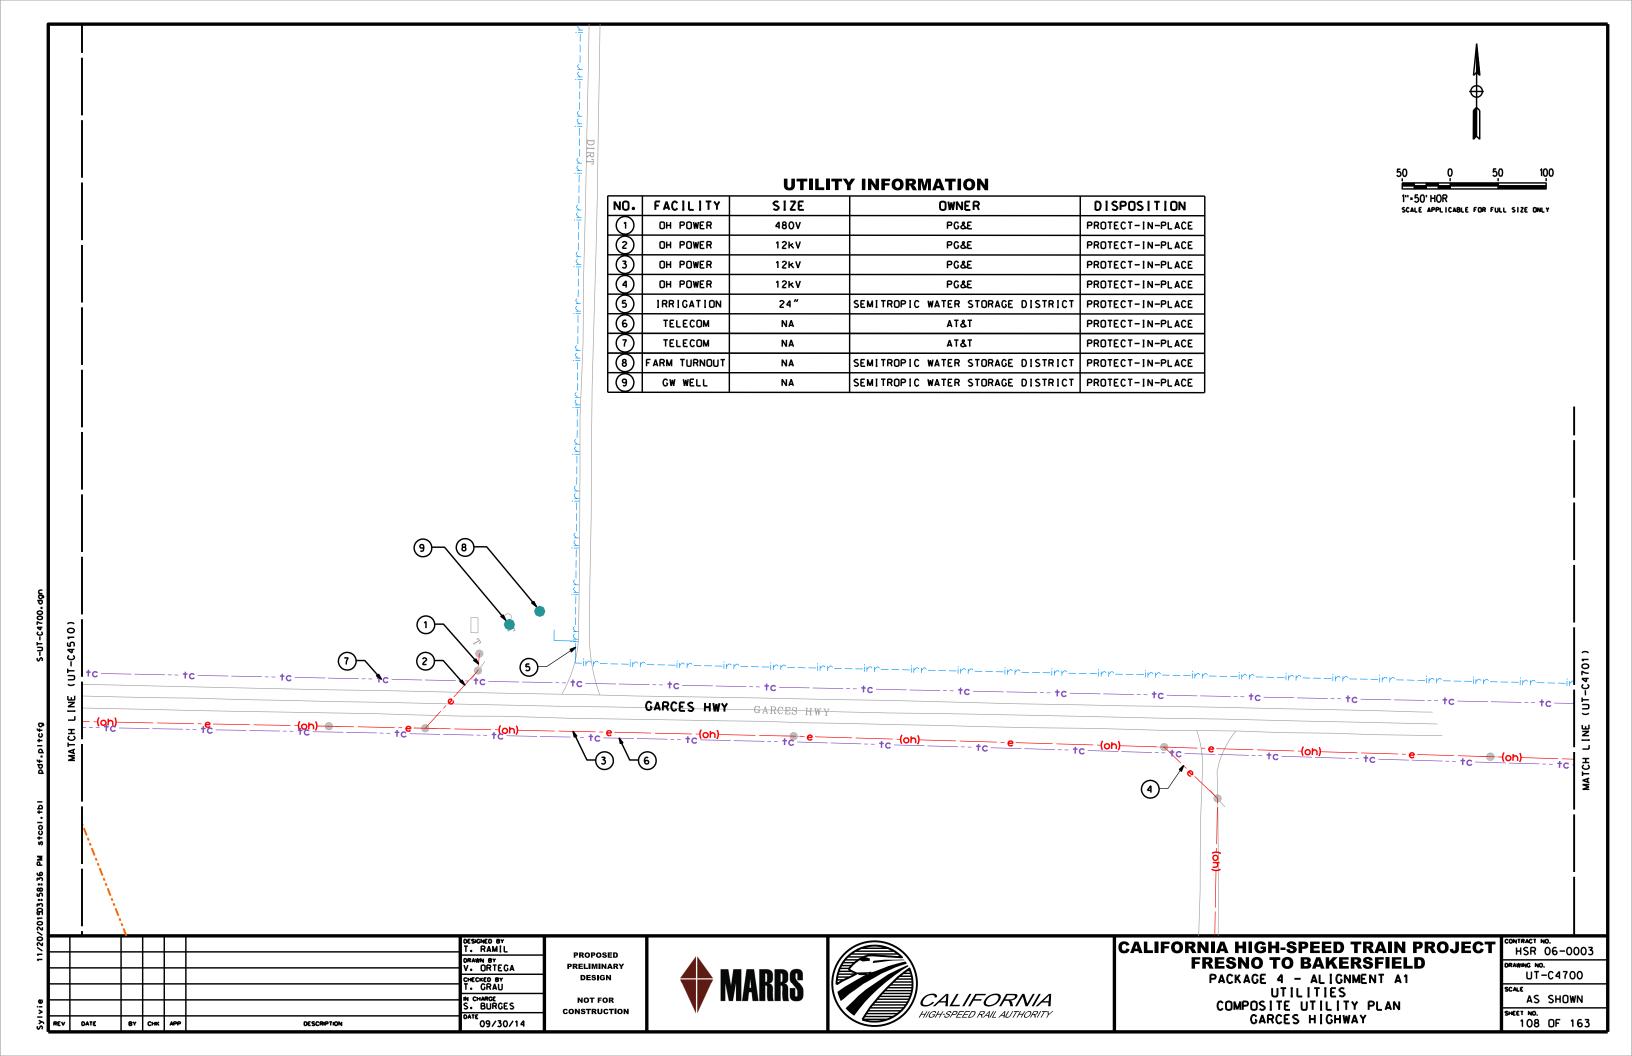

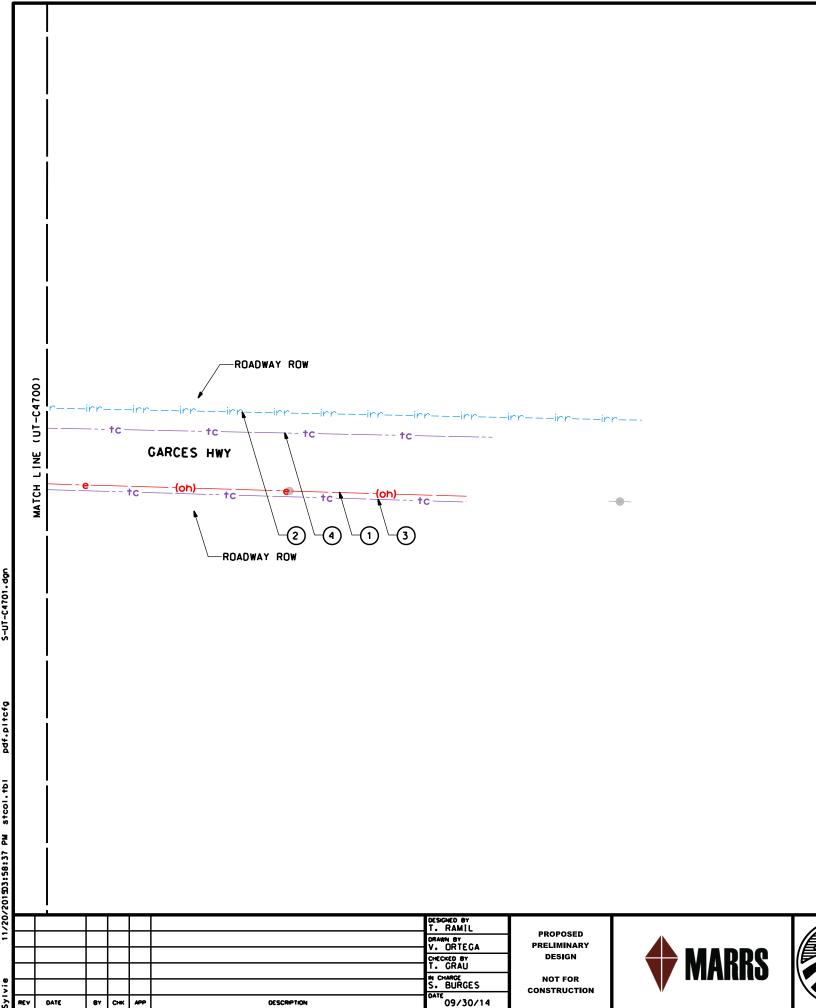

## UTILITY INFORMATION

NO.	FACILITY	SIZE	OWNER	DISPOSITION
0	OH POWER	12kV	PG&E	PROTECT-IN-PLACE
(A)	IRRIGATION	24"	SEMITROPIC WATER STORAGE DISTRICT	PROTECT-IN-PLACE
3	TELECOM	NA	AT&T	PROTECT-IN-PLACE
4	TELECOM	NA	AT&T	PROTECT-IN-PLACE

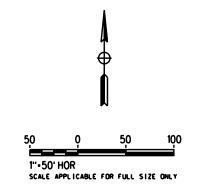




## CALIFORNIA HIGH-SPEED TRAIN PROJECT FRESNO TO BAKERSFIELD

PACKAGE 4 - ALIGNMENT A1 UTILITIES COMPOSITE UTILITY PLAN GARCES HIGHWAY

CONTRACT NO. HSR 06-0003
DRAWING NO.
UT-C4701
SCALE
AS SHOWN
SHEET NO.
109 OF 163

# **UTILITY INFORMATION**

NO.	FACILITY	SIZE OWNER		DISPOSITION	
0	OH POWER	12kV	PG&E	PROTECT-IN-PLACE	
(2)	TELECOM	NA	AT&T	PROTECT-IN-PLACE	
3	TELECOM	NA	AT&T	PROTECT-IN-PLACE	

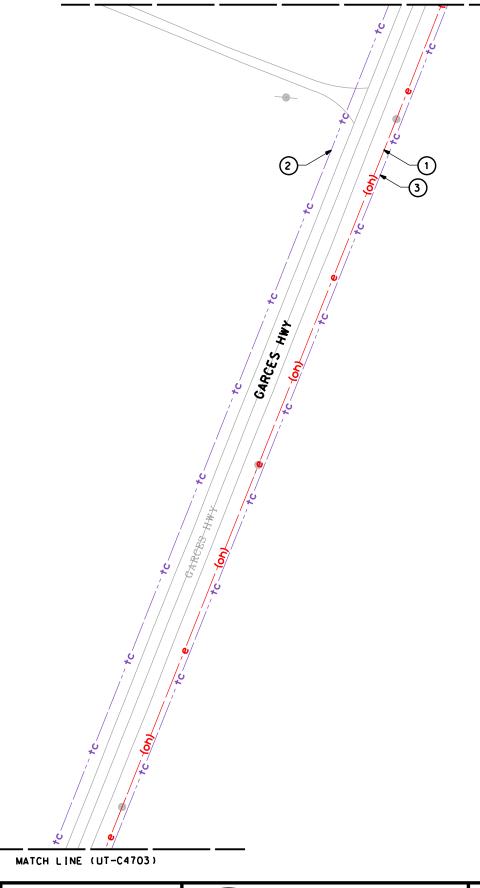

MATCH LINE (UT-C4510)

1"•50' HOR

SCALE APPLICABLE FOR FULL SIZE ONLY

REV	DATE	BY	CHK	APP	DESCRIPTION	09/30/14
						S. BURGES
						T. GRAU
						CHECKED BY
						DRAWN BY V. ORTEGA
						DESIGNED BY T. RAMIL

PROPOSED PRELIMINARY DESIGN NOT FOR

CONSTRUCTION





# CALIFORNIA HIGH-SPEED TRAIN PROJECT

FRESNO TO BAKERSFIELD


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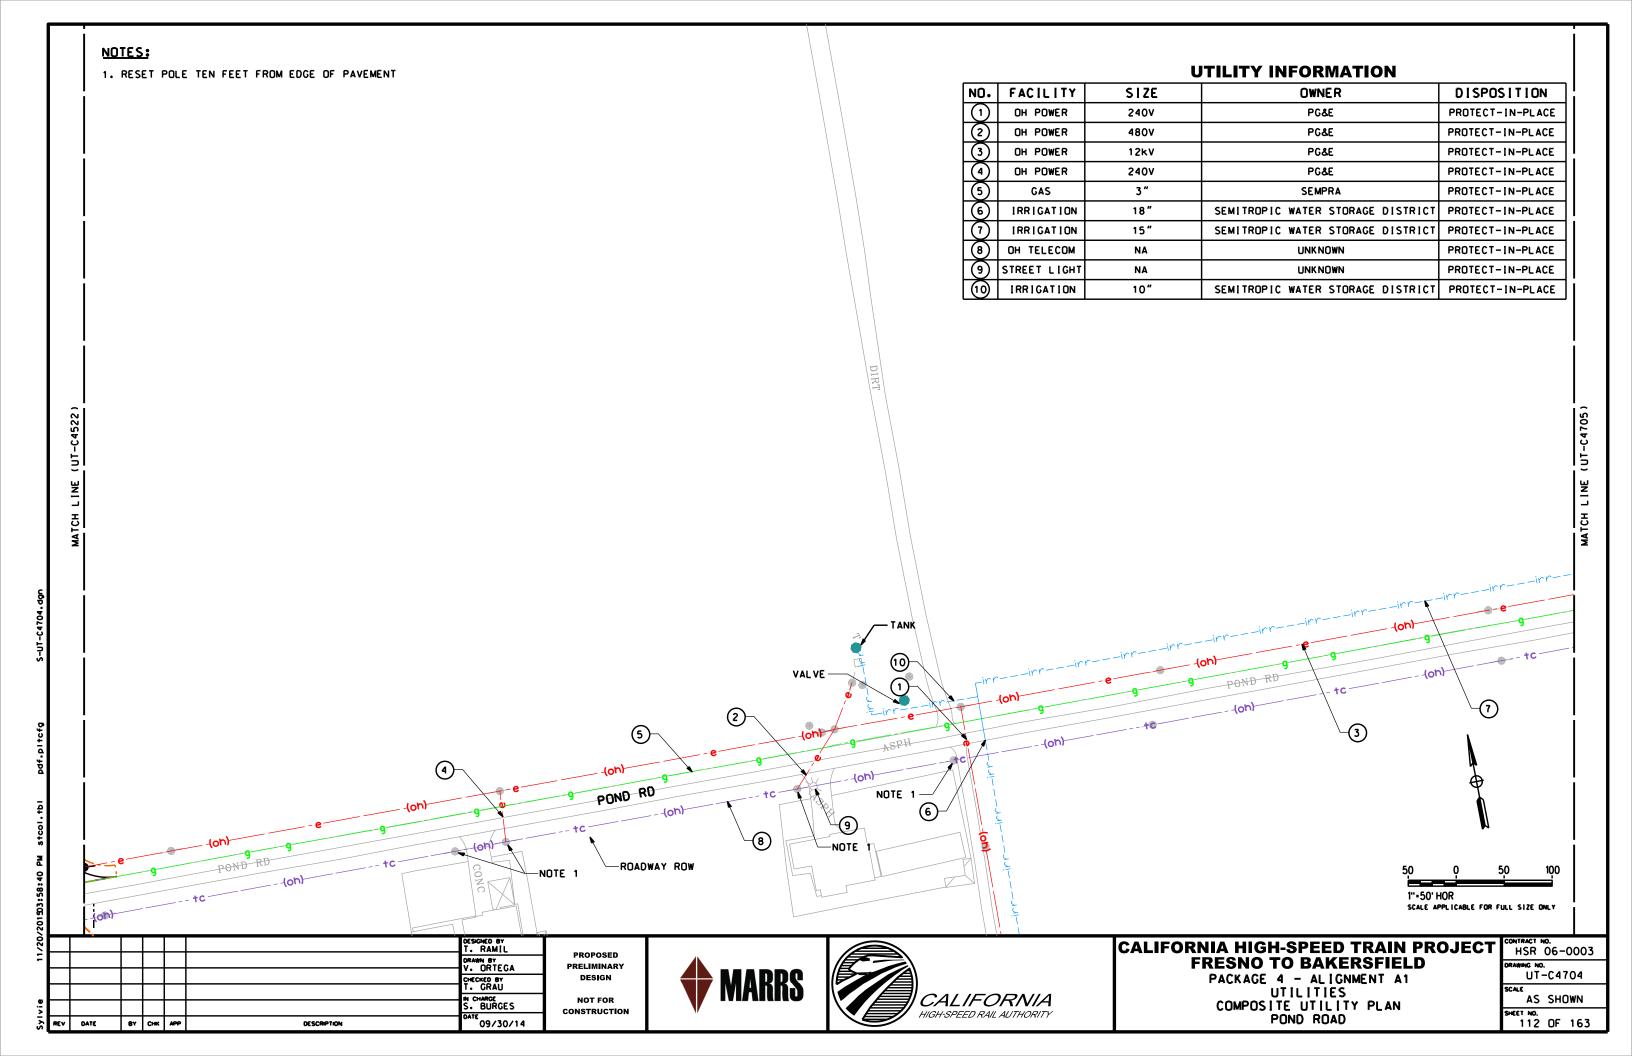
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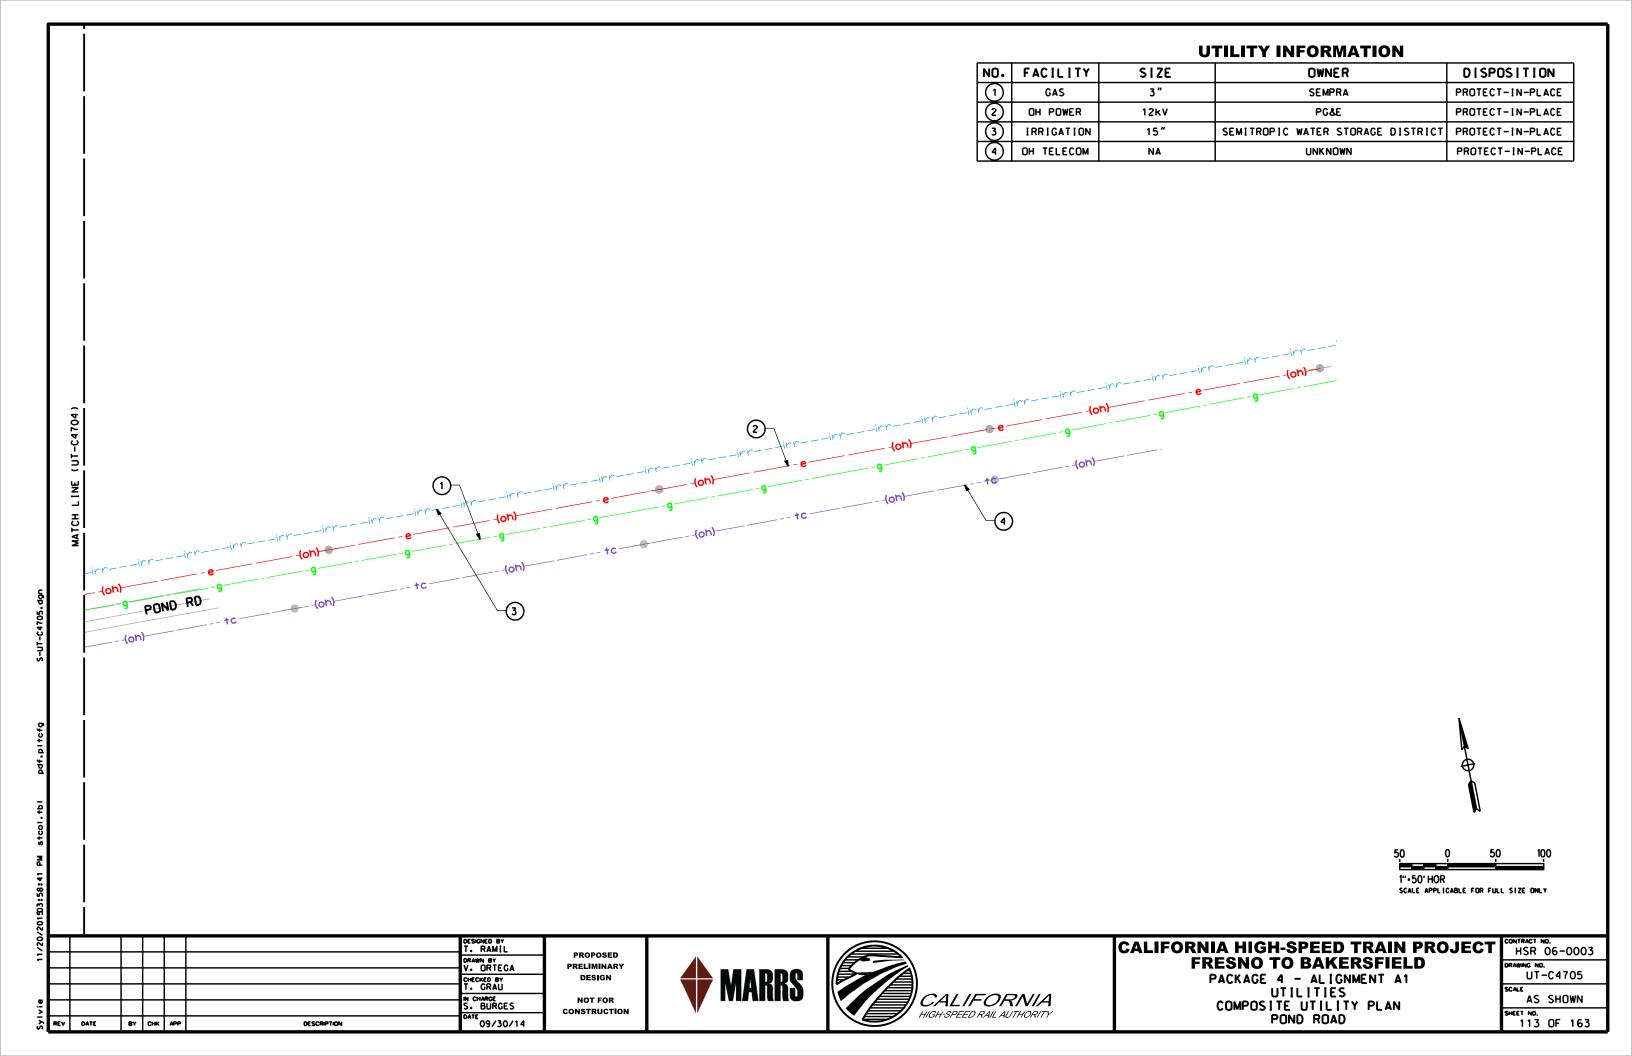
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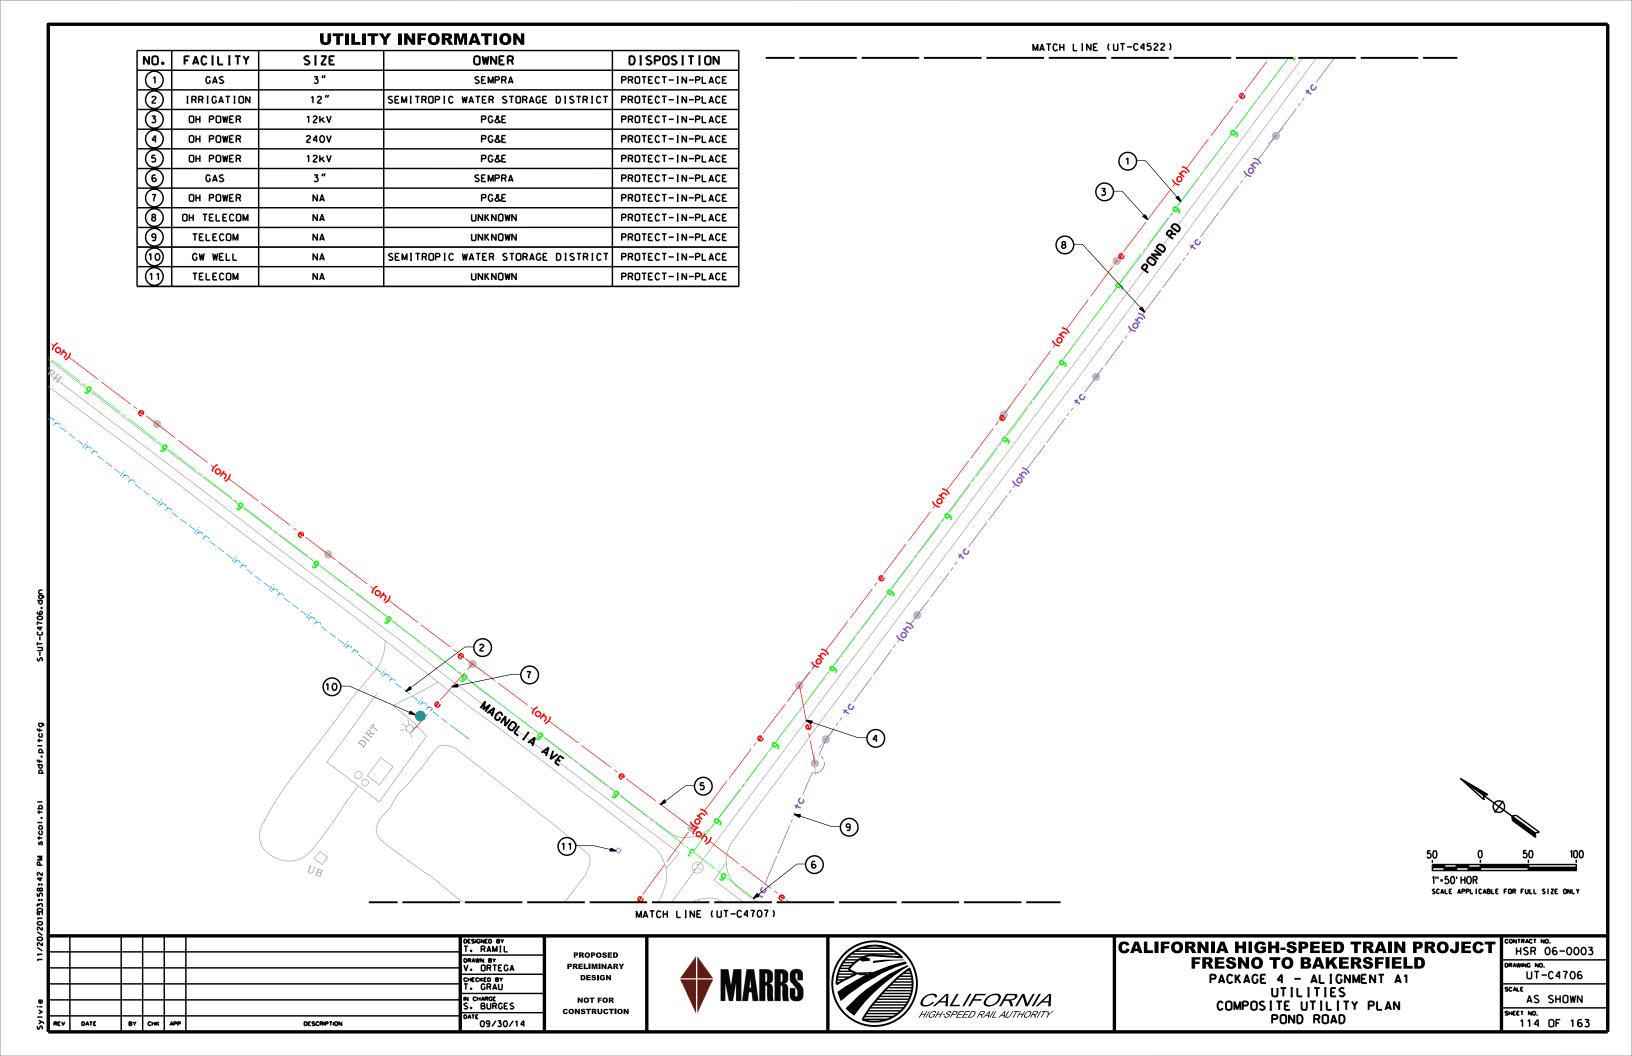
GARCES HIGHWAY


	CONTRACT NO.
	CONTRACT NO. HSR 06-0003
ı	DRAWING NO.
	UT-C4702
ı	SCALE
	AS SHOWN
ı	SHEET NO.
	110 OF 163









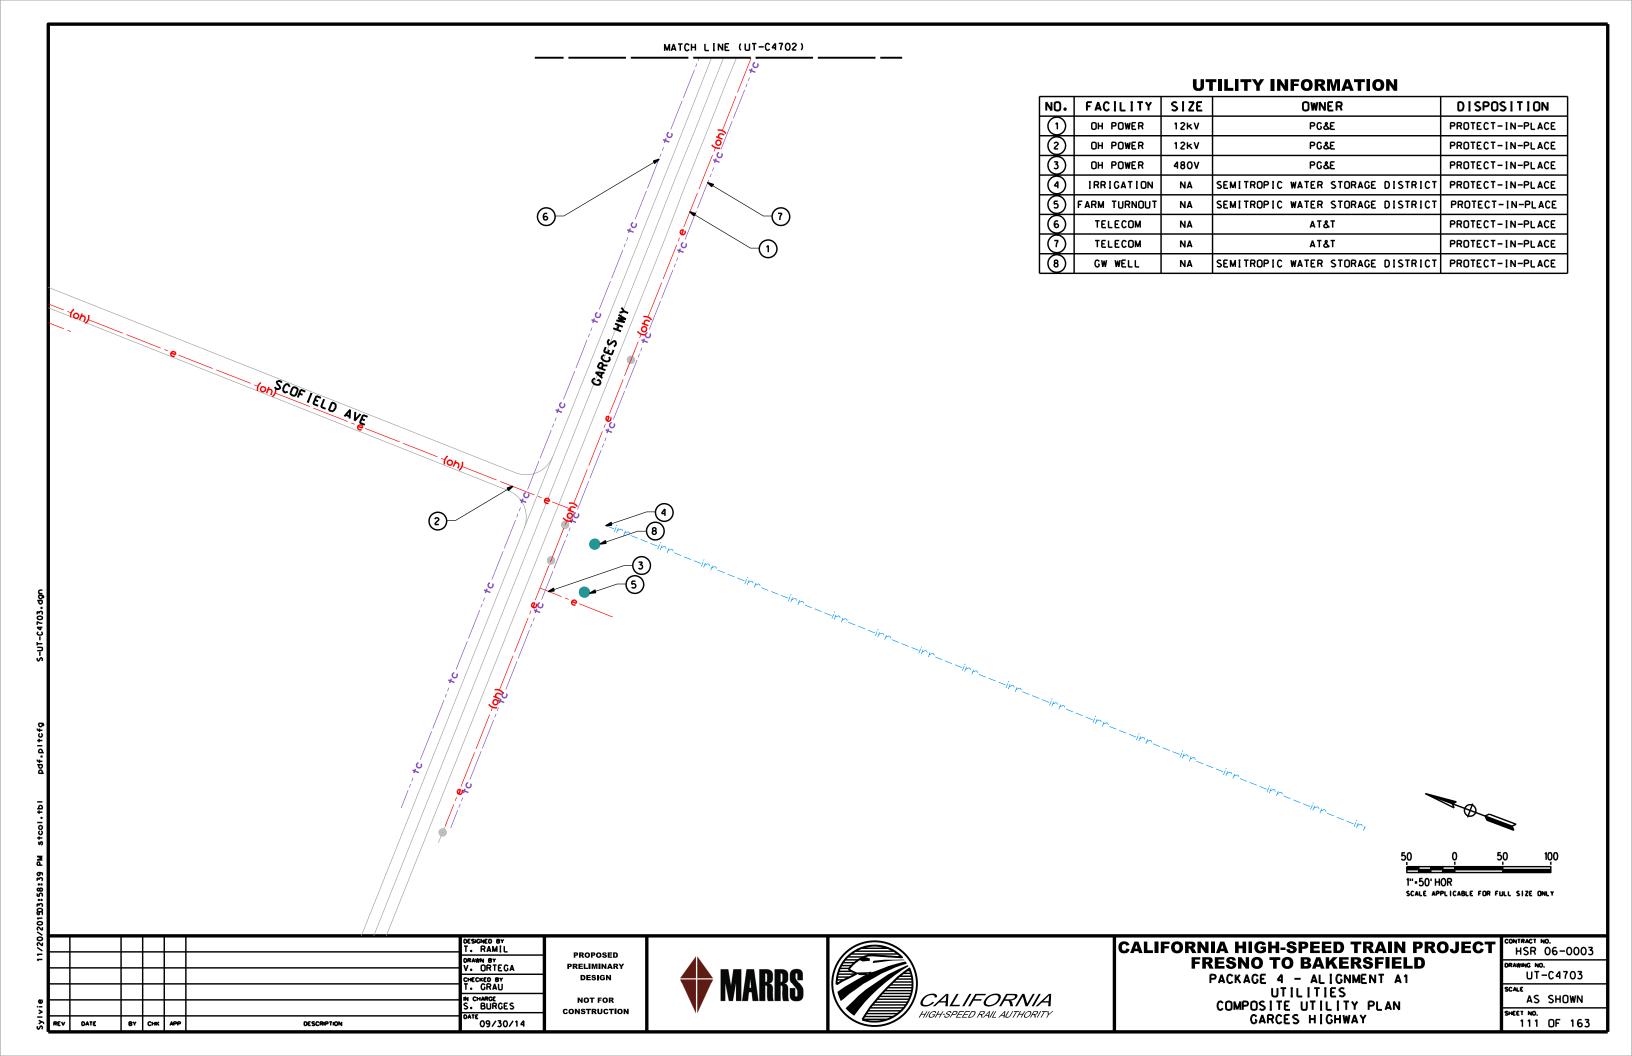

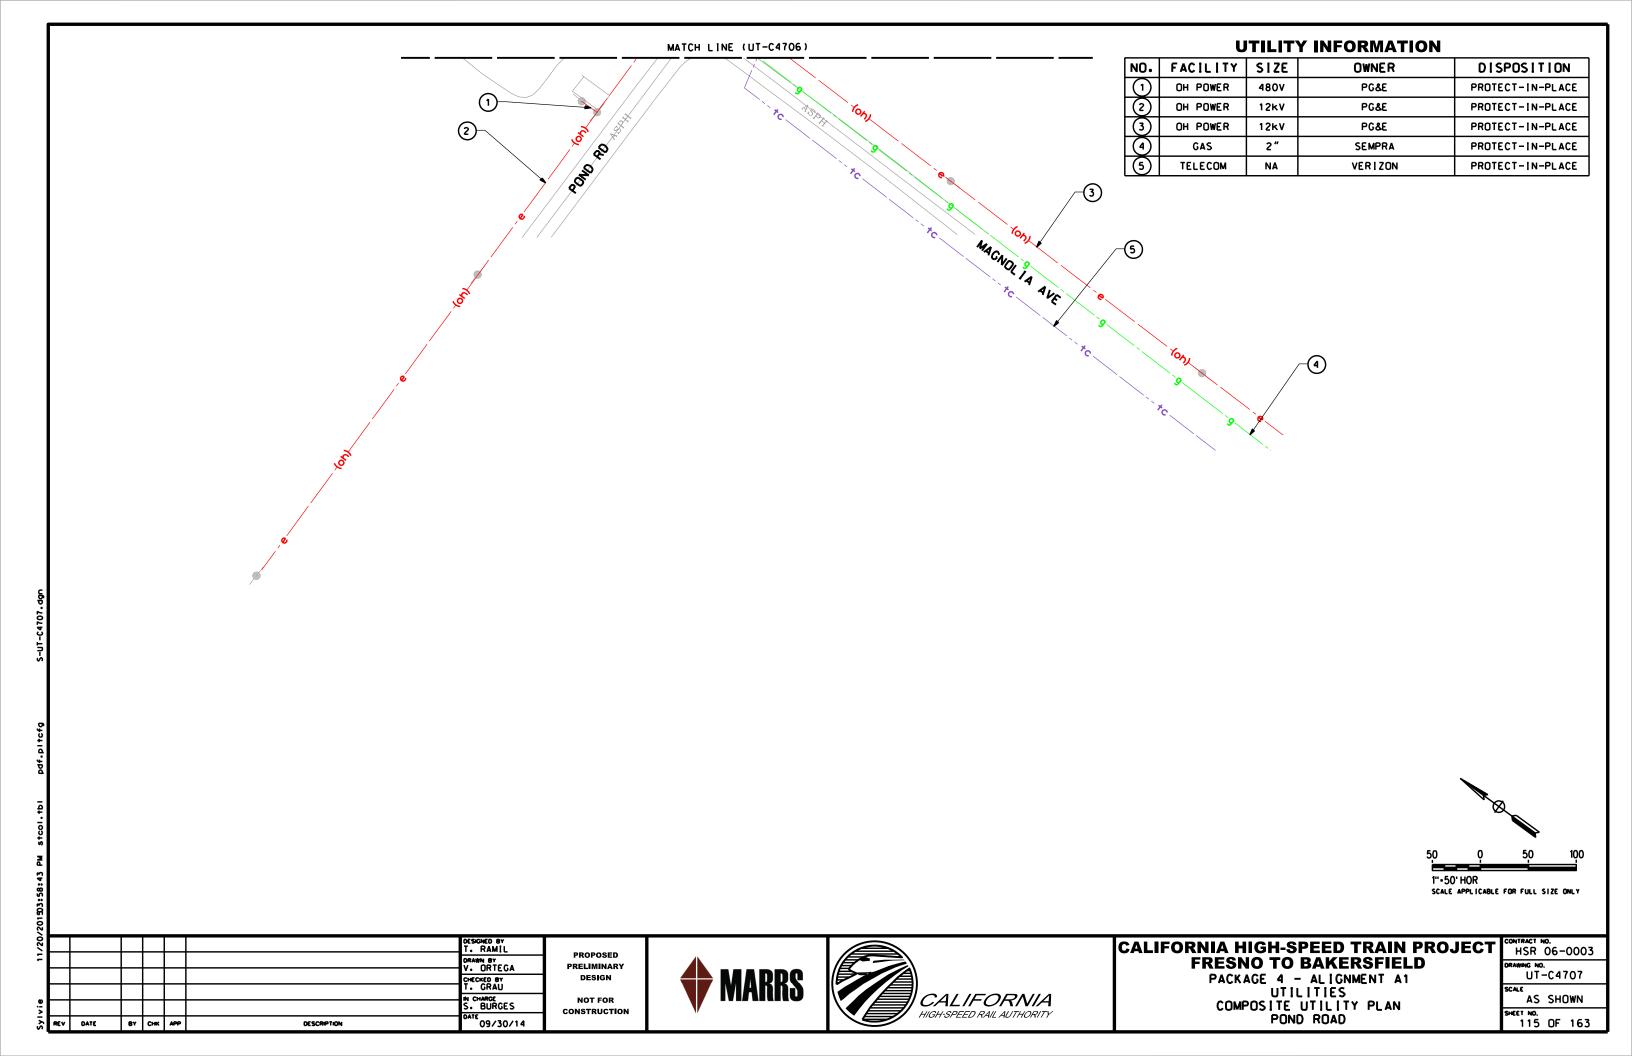


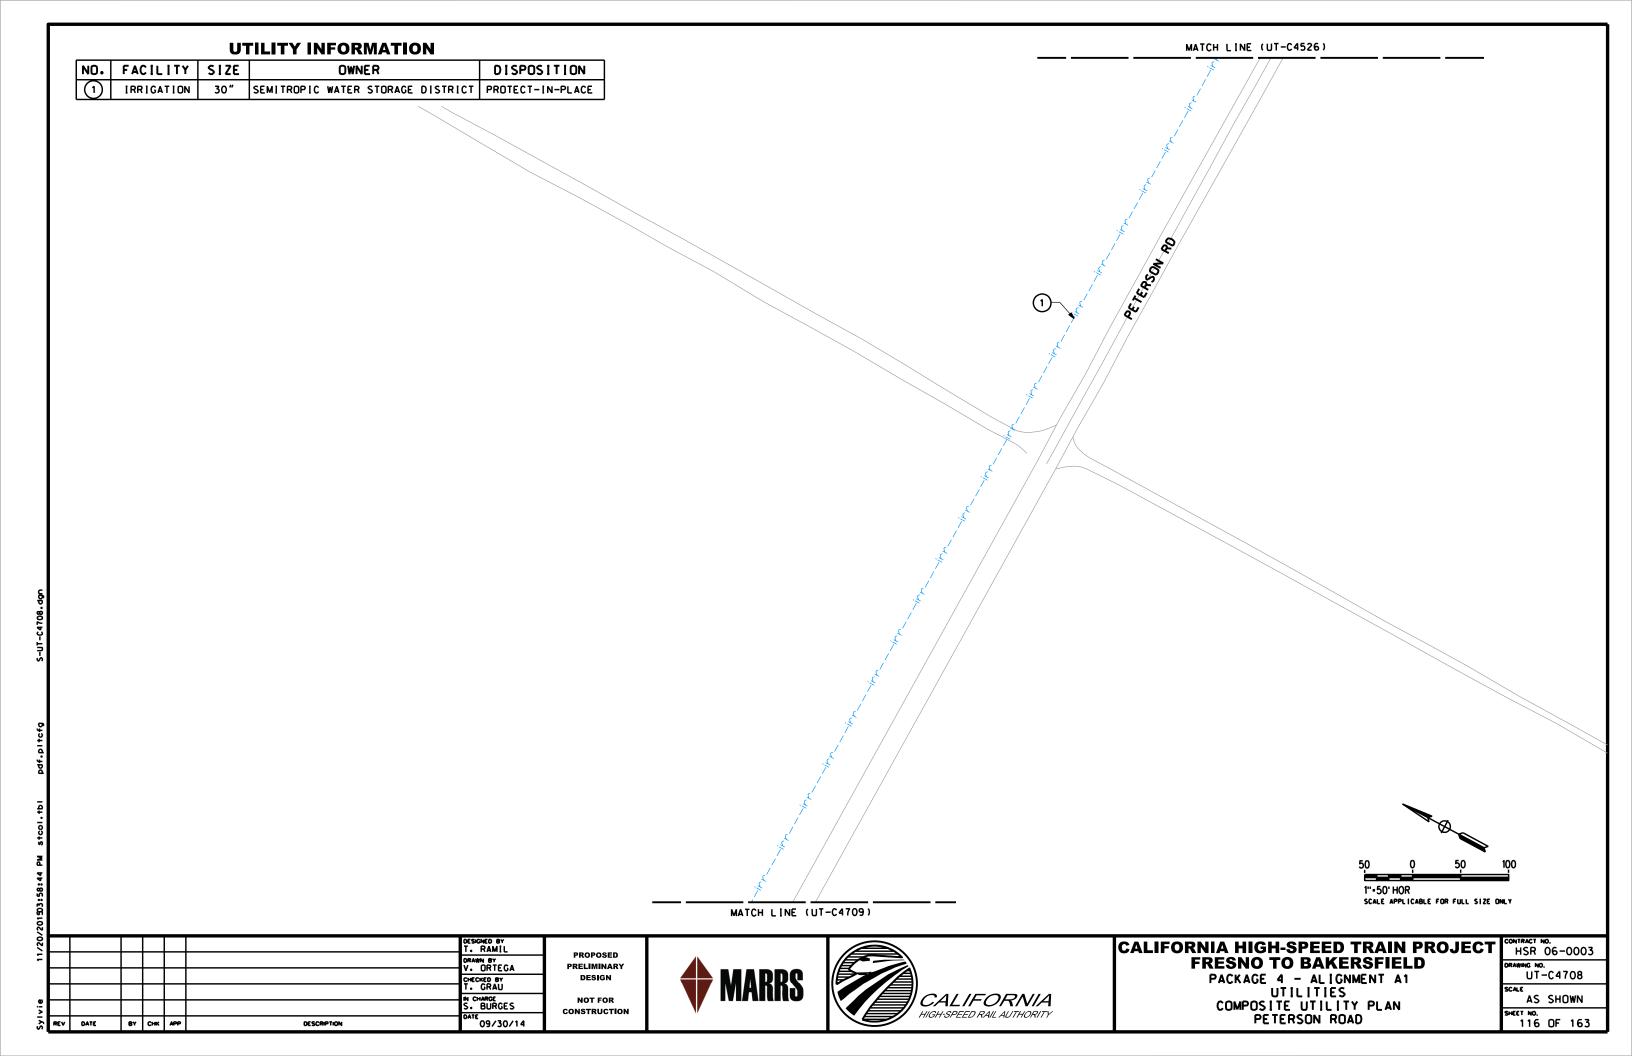

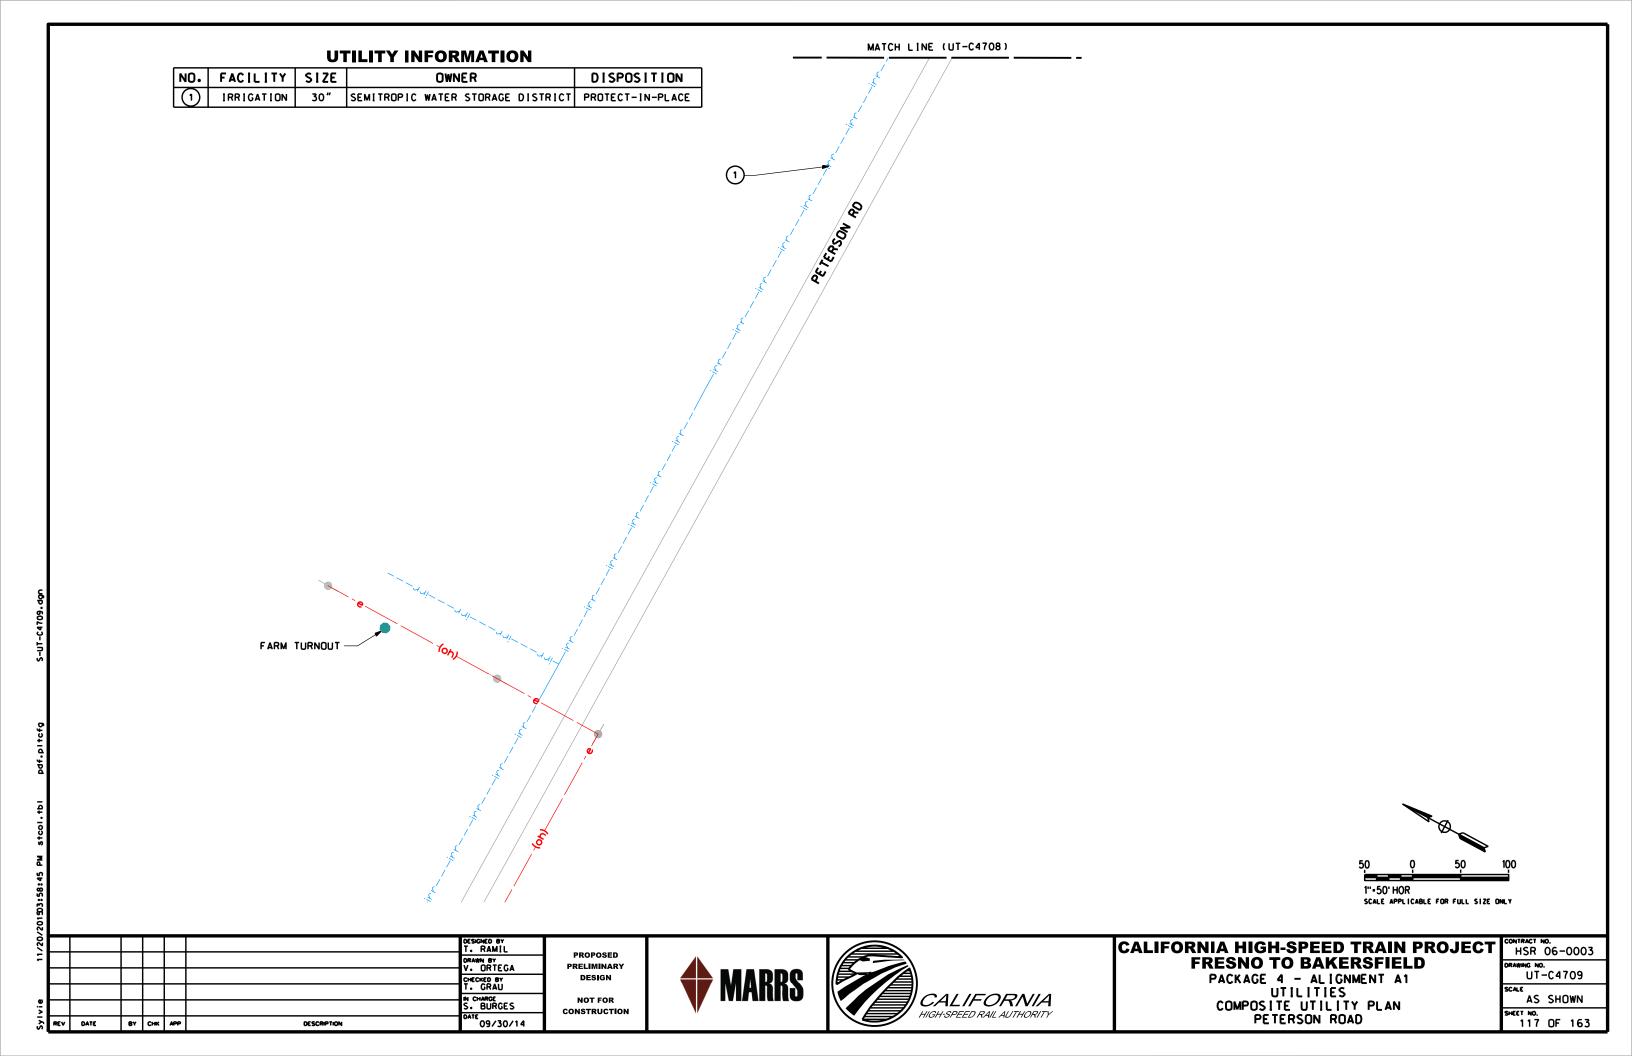

## **UTILITY INFORMATION**

NO.	FACILITY	SIZE	OWNER	DISPOSITION	
1	OH POWER	12kV	PG&E	PROTECT-IN-PLACE	
2	IRRIGATION	30"	SEMITROPIC WATER STORAGE DISTRICT	PROTECT-IN-PLACE	
3	OH POWER	12kV	PG&E	PROTECT-IN-PLACE	

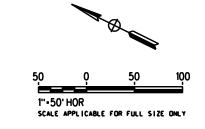



CALIFORNIA HIGH-SPEED TRAIN PROJECT FRESNO TO BAKERSFIELD

PACKAGE 4 - ALIGNMENT A1 UTILITIES COMPOSITE UTILITY PLAN PETERSON ROAD

•	CONTRACT NO. HSR 06-0003
	DRAWING NO. UT-C4710
	AS SHOWN
	SHEET NO. 118 OF 163

NO.	FACILITY	SIZE	OWNER	DISPOSITION
$\odot$	IRRIGATION	30"	SEMITROPIC WATER STORAGE DISTRICT	PROTECT-IN-PLACE
2	OH POWER	12kV	PG&E	PROTECT-IN-PLACE
(3)	POWER	NA	PG&E	PROTECT-IN-PLACE

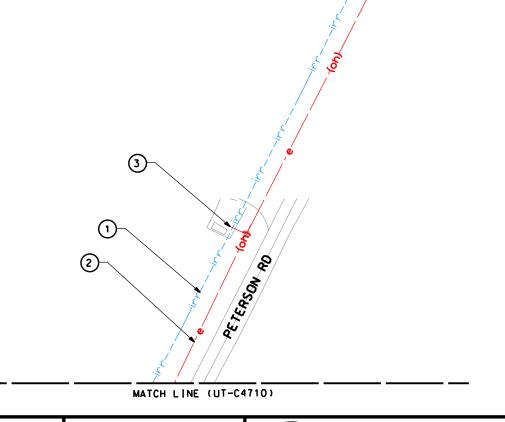

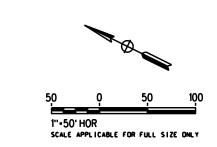

•								_
í							DESIGNED BY T. RAMIL	
-							DRAWN BY	
							CHECKED BY T. GRAU	
							IN CHARGE	
2							S. BURGES	
Š	REV	DATE	84	СНК	APP	DESCRIPTION	09/30/14	L.

PROPOSED
PRELIMINARY
DESIGN
NOT FOR

CONSTRUCTION







# CALIFORNIA HIGH-SPEED TRAIN PROJECT FRESNO TO BAKERSFIELD


PACKAGE 4 - ALIGNMENT A1
UTILITIES
COMPOSITE UTILITY PLAN
PETERSON ROAD


CONTRACT NO.
CONTRACT NO. HSR 06-0003
DRAWING NO.
UT-C4711
SCALE
AS SHOWN
SHEET NO.
119 OF 163

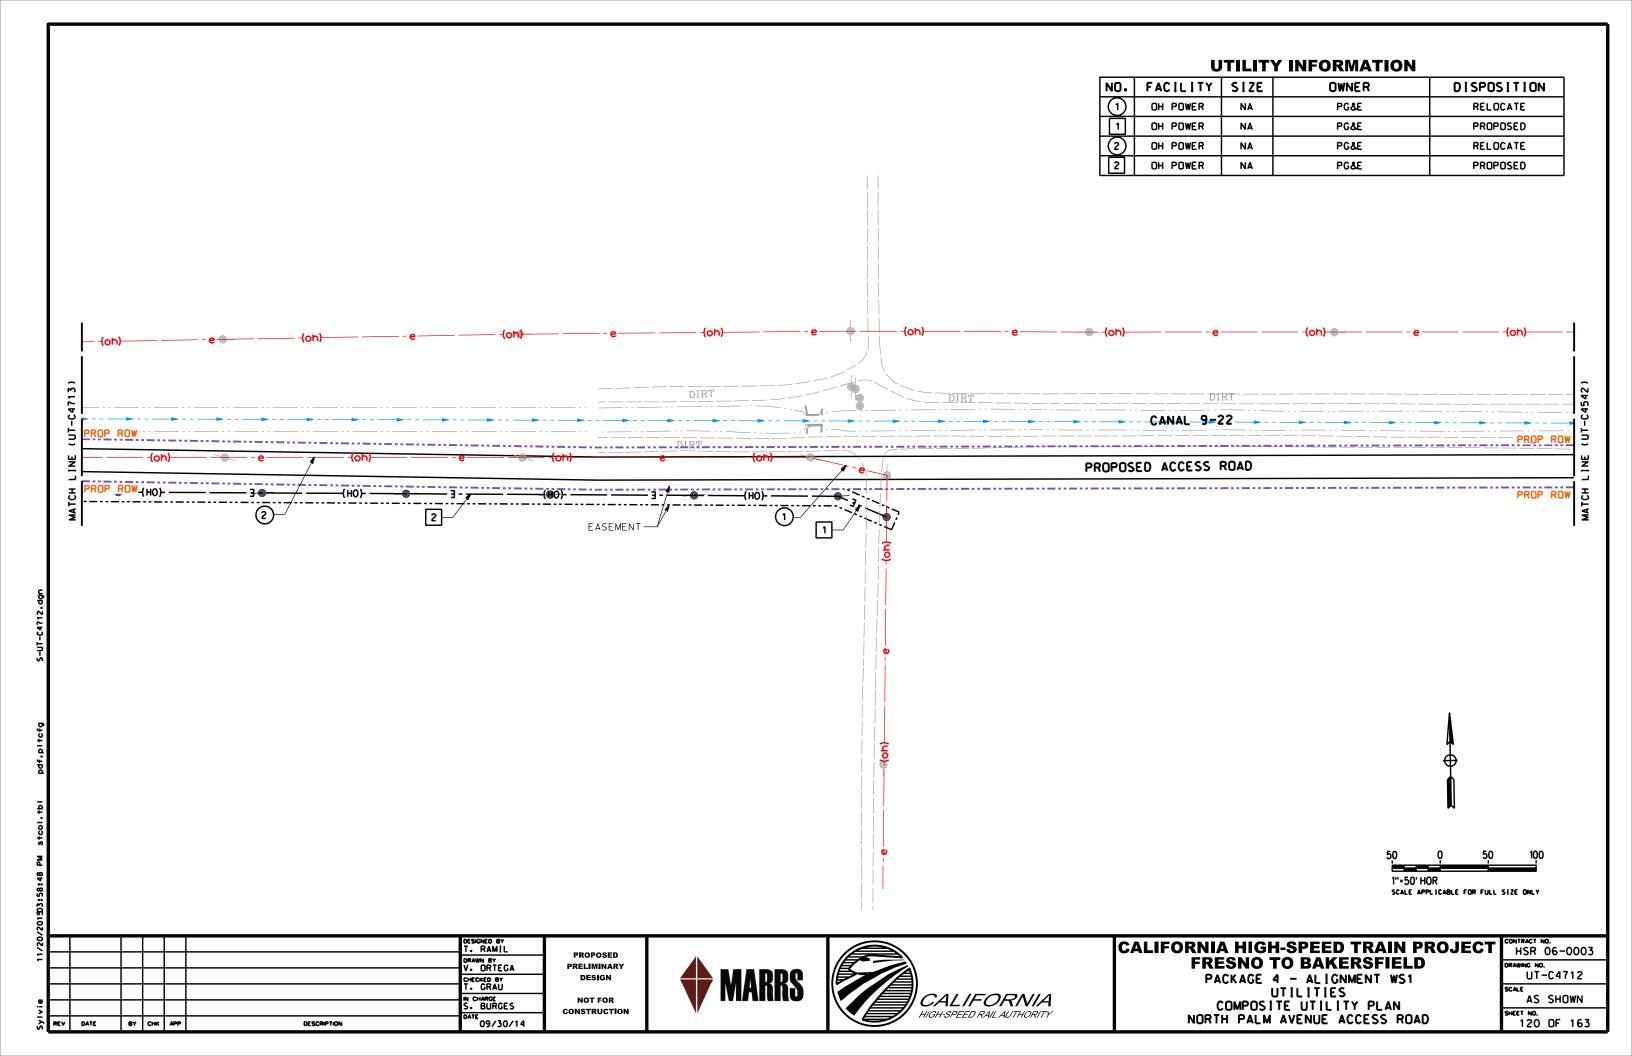


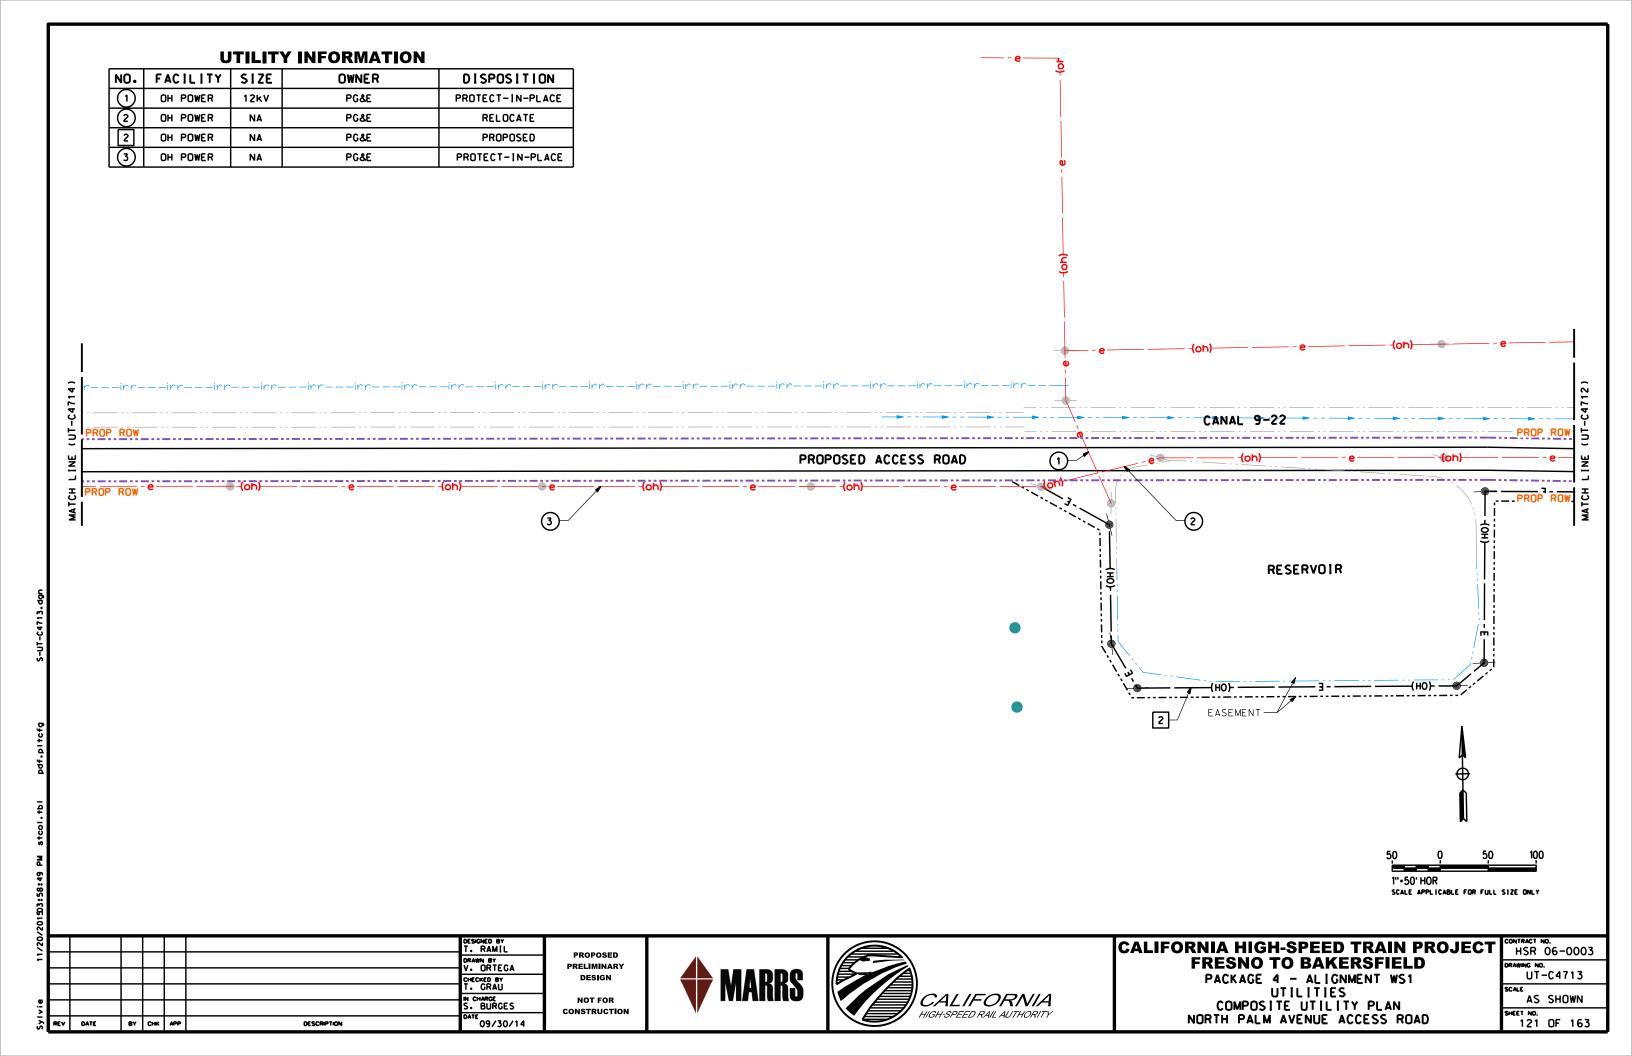

# **UTILITY INFORMATION** FACILITY NO. SIZE OWNER DISPOSITION OH POWER PROTECT IN PLACE PG&E PROTECT-IN-PLACE OH POWER NA PG&E OH POWER NA PG&E PROTECT IN PLACE (4) SEMPRA RELOCATE GAS NA GAS CONCRETE BLANKET SEMPRA PROPOSED IRRIGATION PROTECT IN PLACE UNKNOWN NORTH PALM AVE CANAL 9-22 .\_..\_. MATCH LINE PROPOSED ACCESS ROAD 1"•50' HOR SCALE APPLICABLE FOR FULL SIZE ONLY ONTRACT NO. HSR 06-0003 DESIGNED BY T. RAMIL CALIFORNIA HIGH-SPEED TRAIN PROJECT PROPOSED DRAWN BY V. ORTEGA **FRESNO TO BAKERSFIELD** PRELIMINARY PACKAGE 4 - ALIGNMENT WS1 UTILITIES COMPOSITE UTILITY PLAN UT-C4714 DESIGN CHECKED BY AS SHOWN CHARGE BURGES NOT FOR **CALIFORNIA** CONSTRUCTION SHEET NO. 122 OF 163 NORTH PALM AVENUE ACCESS ROAD TE 09/30/14 BY CHK APP DESCRIPTION

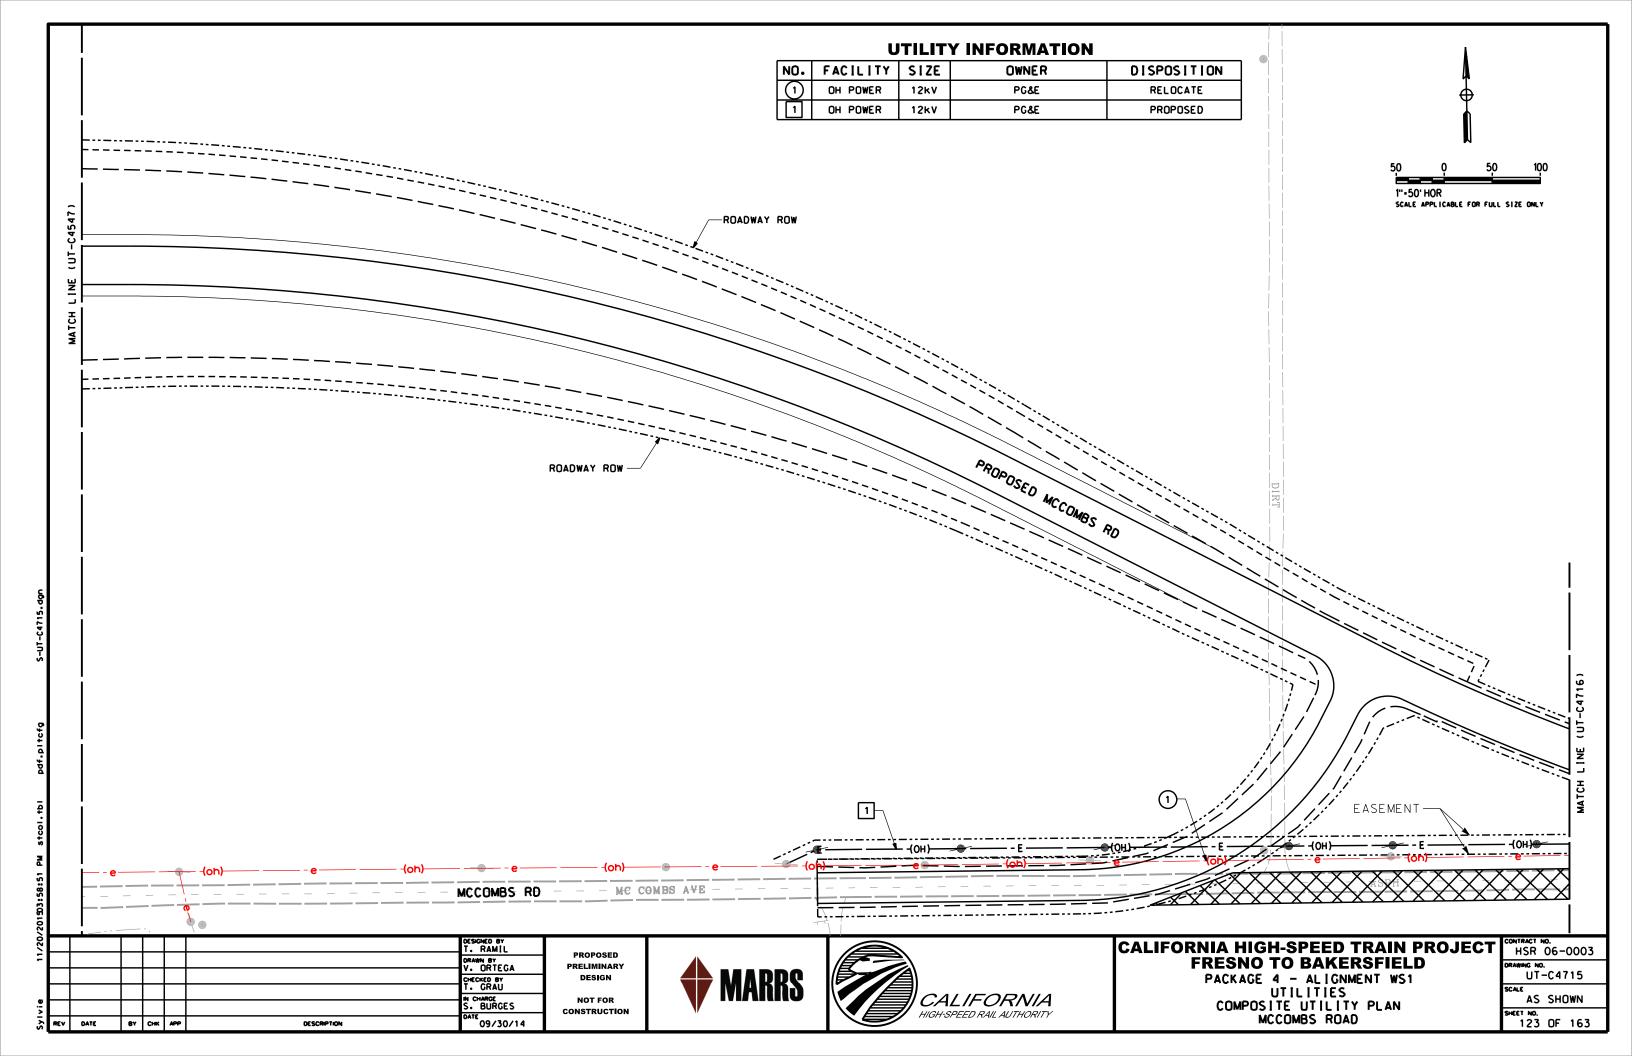

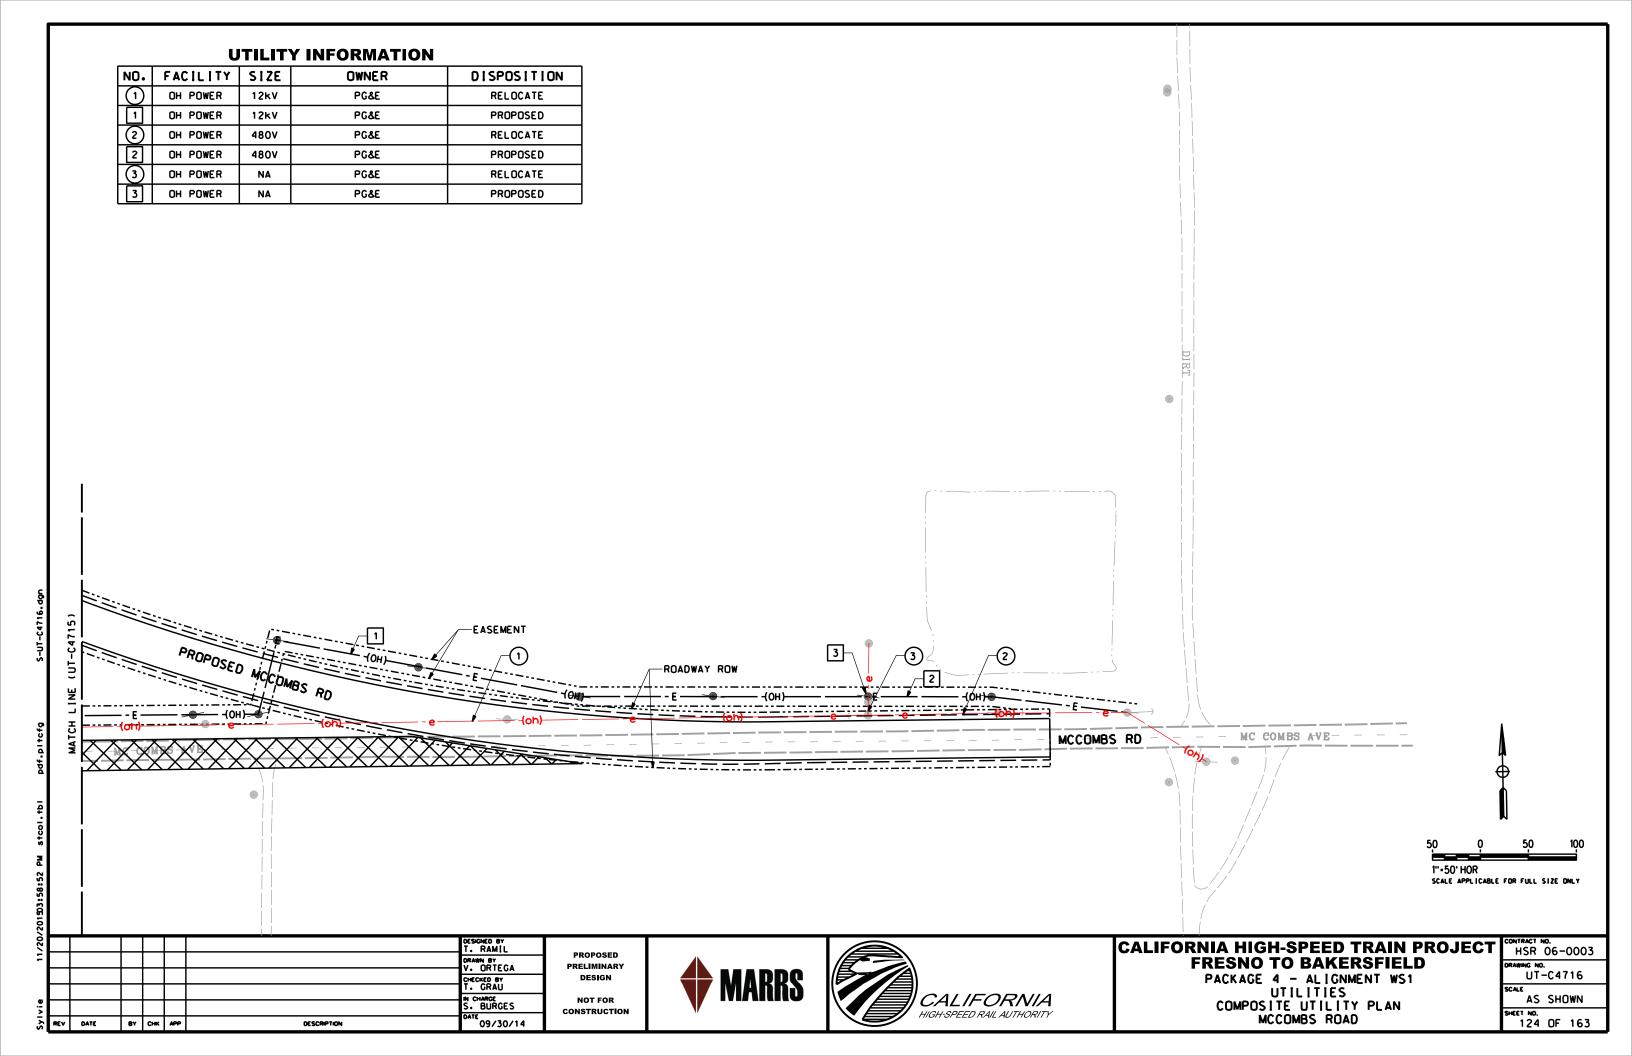


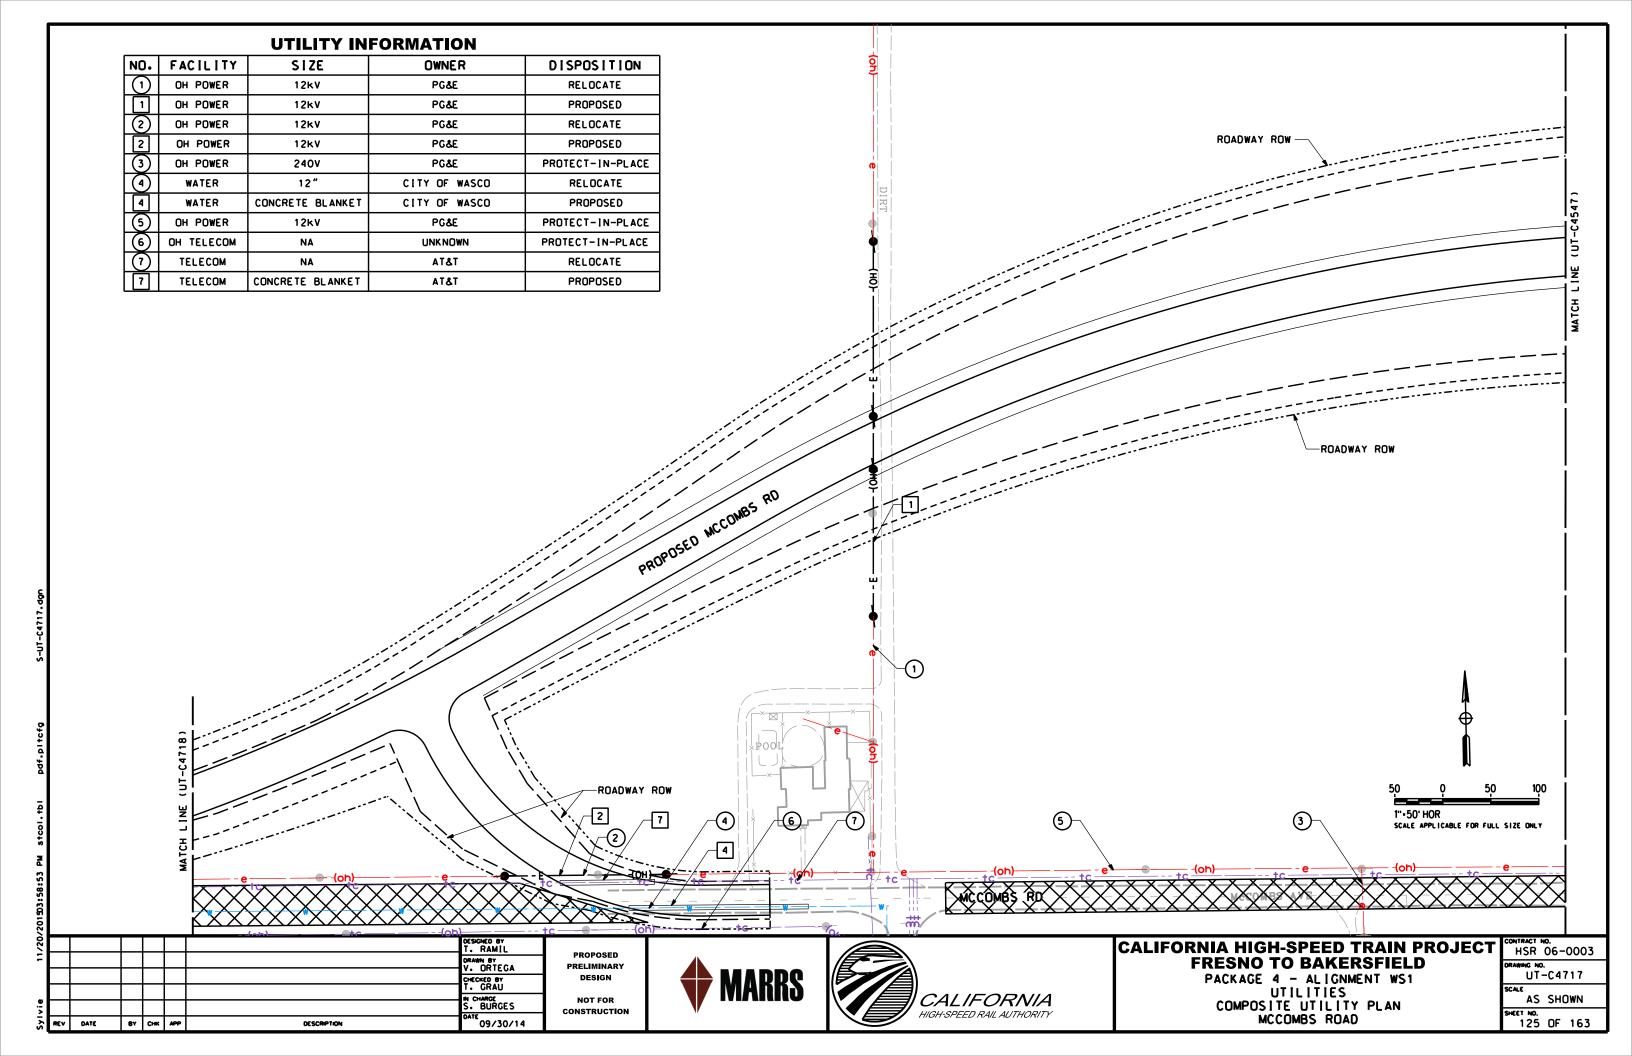

## **UTILITY INFORMATION**

NO.	FACILITY	SIZE	OWNER	DISPOSITION
1	OH POWER	12kV	PG&E	RELOCATE
-	OH POWER	12kV	PG&E	PROPOSED
2	OH POWER	12kV	PG&E	PROTECT-IN-PLACE
3	WATER	12"	CITY OF WASCO	RELOCATE
3A	WATER	CONCRETE BLANKET	CITY OF WASCO	PROPOSED
3B	WATER	CONCRETE BLANKET	CITY OF WASCO	PROPOSED
4	OH TELECOM	NA	UNKNOWN	RELOCATE
4	OH TELECOM	NA	UNKNOWN	PROPOSED
(5)	UG TELECOM	NA	AT&T	RELOCATE
5	UG TELECOM	CONCRETE BLANKET	AT&T	PROPOSED
6	OH POWER	NA	UNKNOWN	PROTECT-IN-PLACE
7	OH TELECOM	NA	UNKNOWN	PROTECT-IN-PLACE

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HIGH-SPEED RAIL AUTHORITY

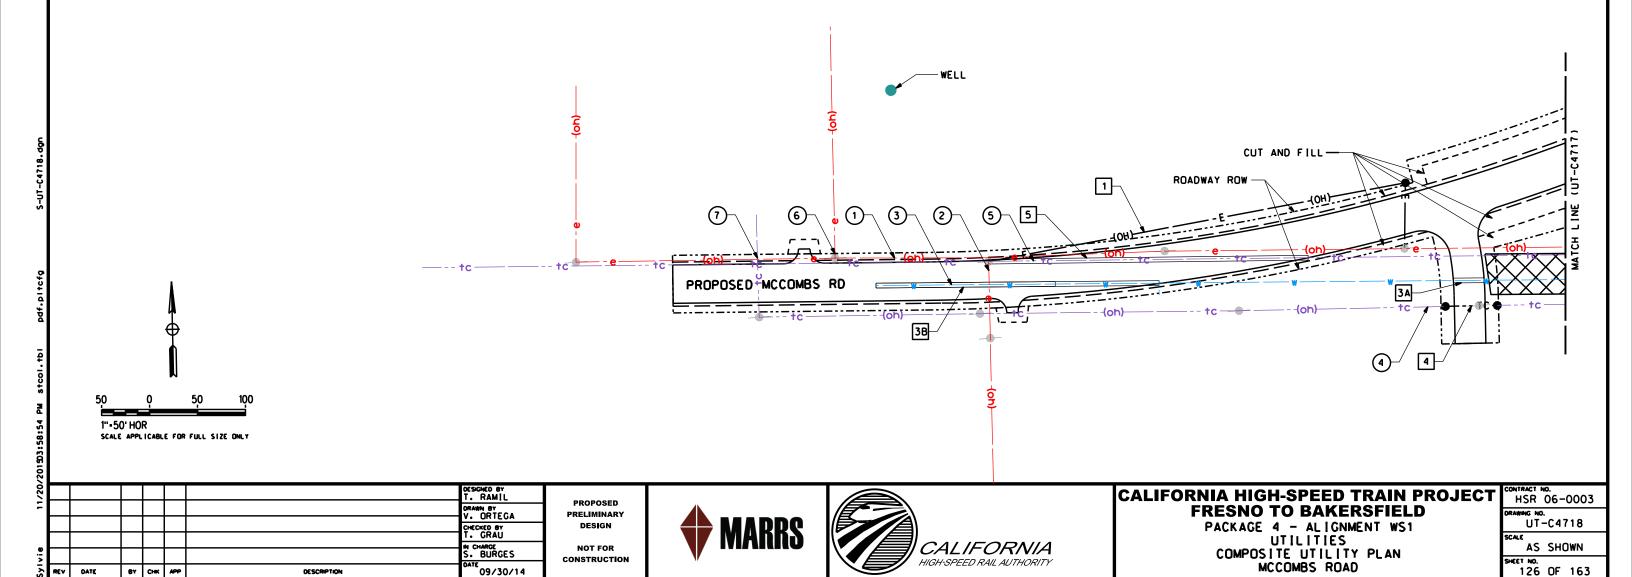
H CHARGE BURGES

BY CHK APP


DESCRIPTION

<sup>116</sup>09/30/14

NOT FOR CONSTRUCTION

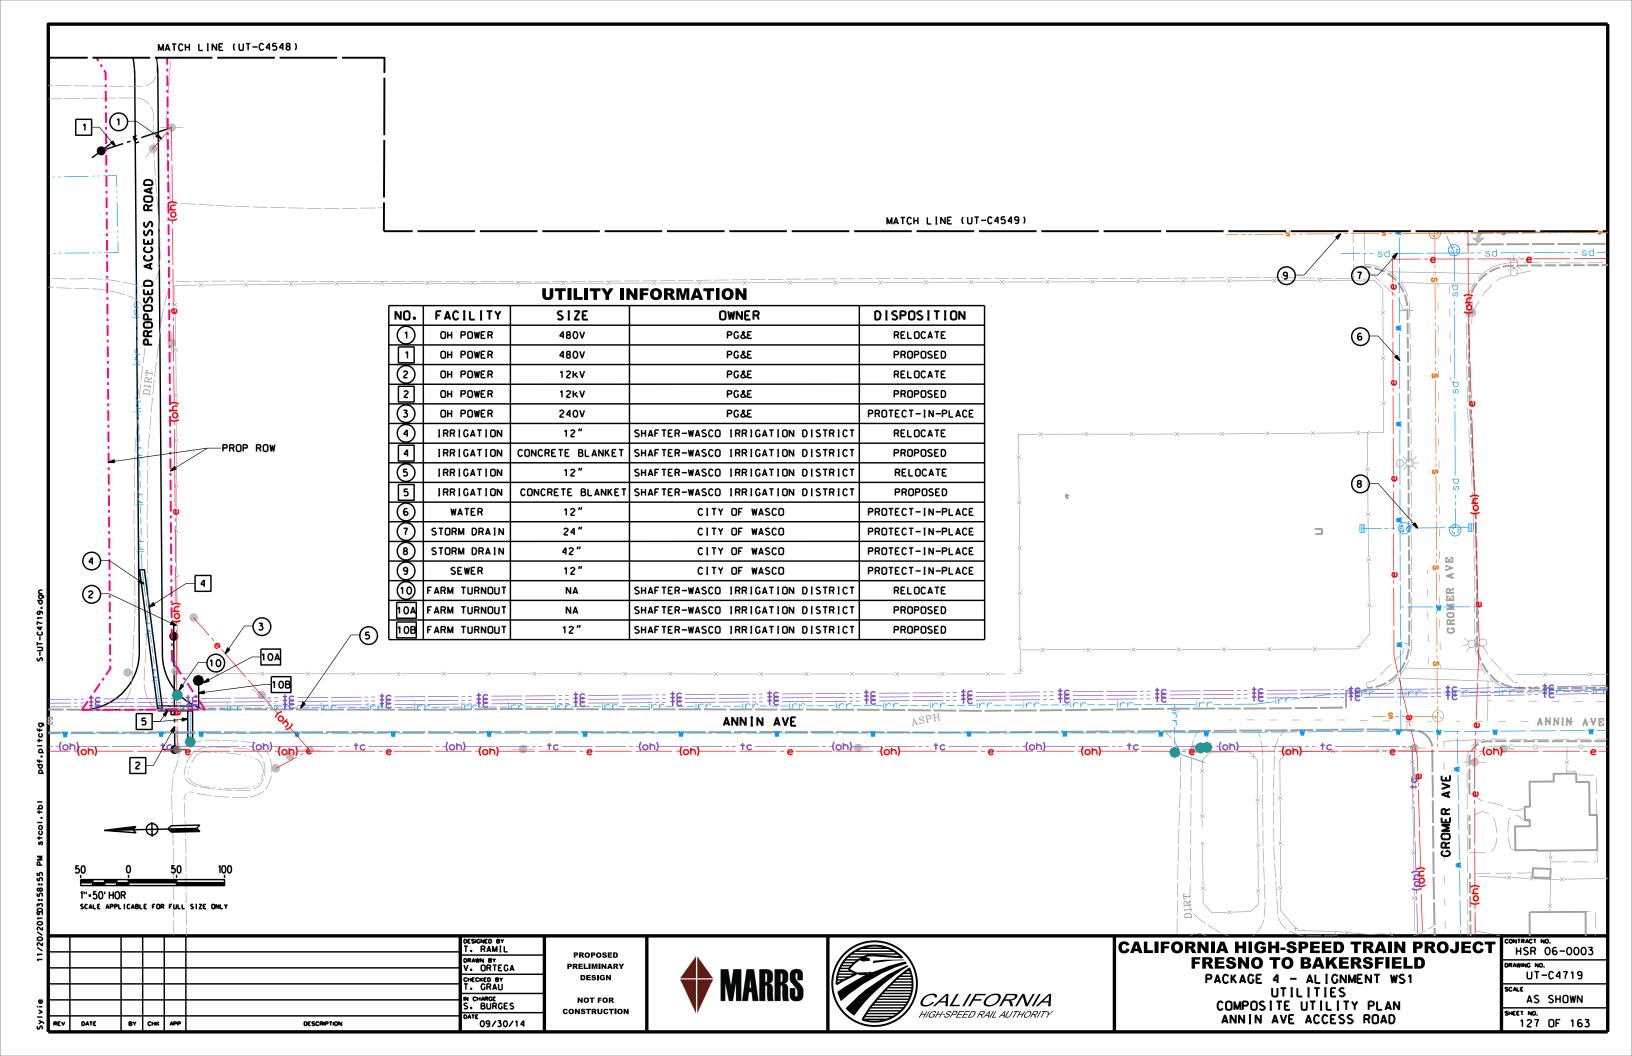

### **UTILITY INFORMATION** FACILITY | SIZE NO. OWNER DISPOSITION (1) SEMPRA GAS RELOCATE 1 GAS 2" SEMPRA PROPOSED (2) SHAFTER-WASCO IRRIGATION DISTRICT IRRIGATION 66" RELOCATE 2 IRRIGATION 66" SHAFTER-WASCO IRRIGATION DISTRICT PROPOSED (3) OH POWER PG&E RELOCATE 12kV 3 OH POWER 12kV PG&E PROPOSED OH POWER 12kV PG&E RELOCATE 4 OH POWER 12kV PG&E PROPOSED (5) OH POWER 12kV PG&E RELOCATE 5 OH POWER 12kV PG&E PROPOSED AT&T UG TELECOM NA RELOCATE AT&T OH TELECOM NA PROPOSED

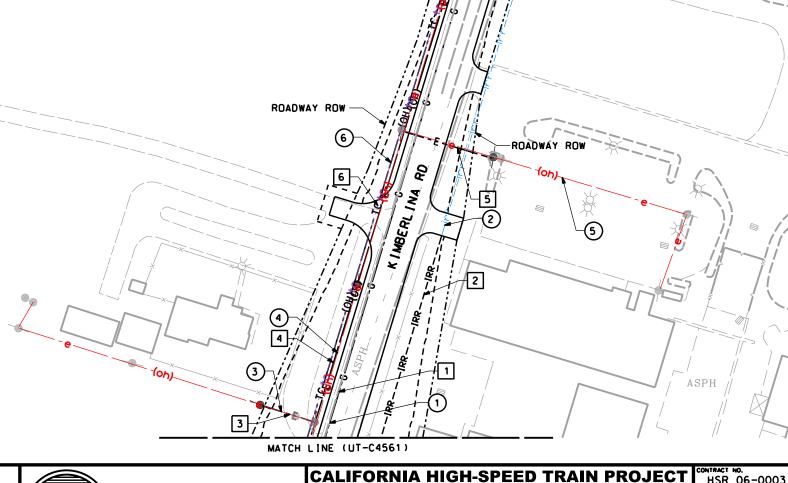

SCALE APPLICABLE FOR FULL SIZE ONLY

PROPOSED
PRELIMINARY
DESIGN

CONSTRUCTION






# CALIFORNIA HIGH-SPEED TRAIN PROJECT FRESNO TO BAKERSFIELD

PACKAGE 4 - ALIGNMENT WS1
UTILITIES
COMPOSITE UTILITY PLAN
KIMBERLINA ROAD

пэк	06-	0003	
AWING NO	١.		
UT.	-C47	722	
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ET NO.			
130	OF	163	

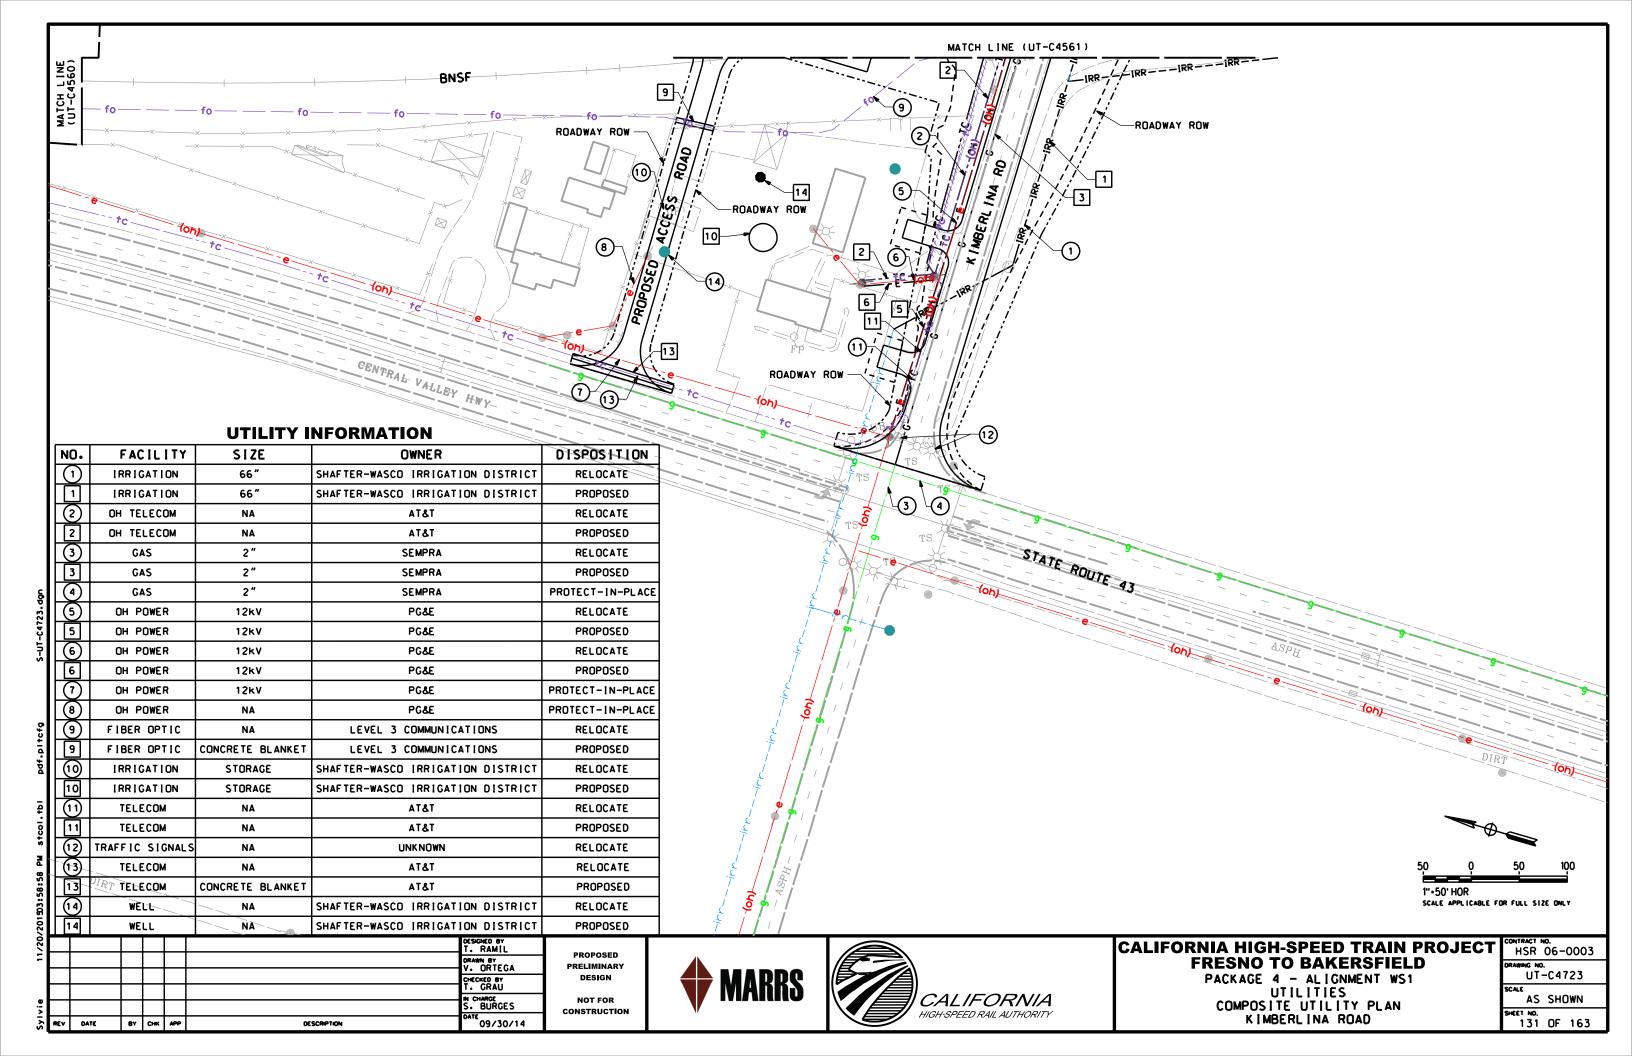


# **UTILITY INFORMATION**

N	0.	FACILITY	SIZE	OWNER	DISPOSITION
$\Box$	1	OH POWER	12kV	PG&E	PROTECT-IN-PLACE

DRESSER AVENUE ACCESS ROAD

AS SHOWN

132 OF 163

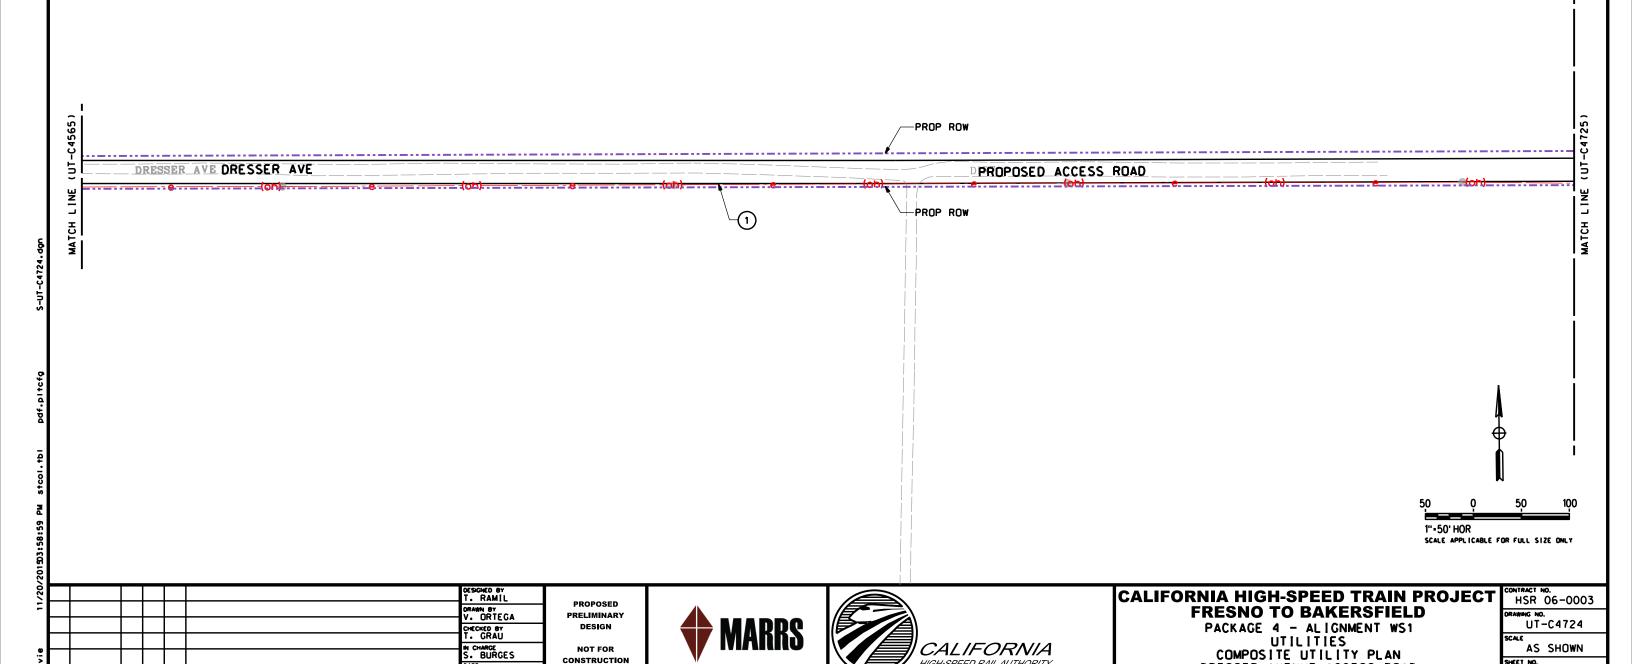

CALIFORNIA

DESIGN

NOT FOR CONSTRUCTION


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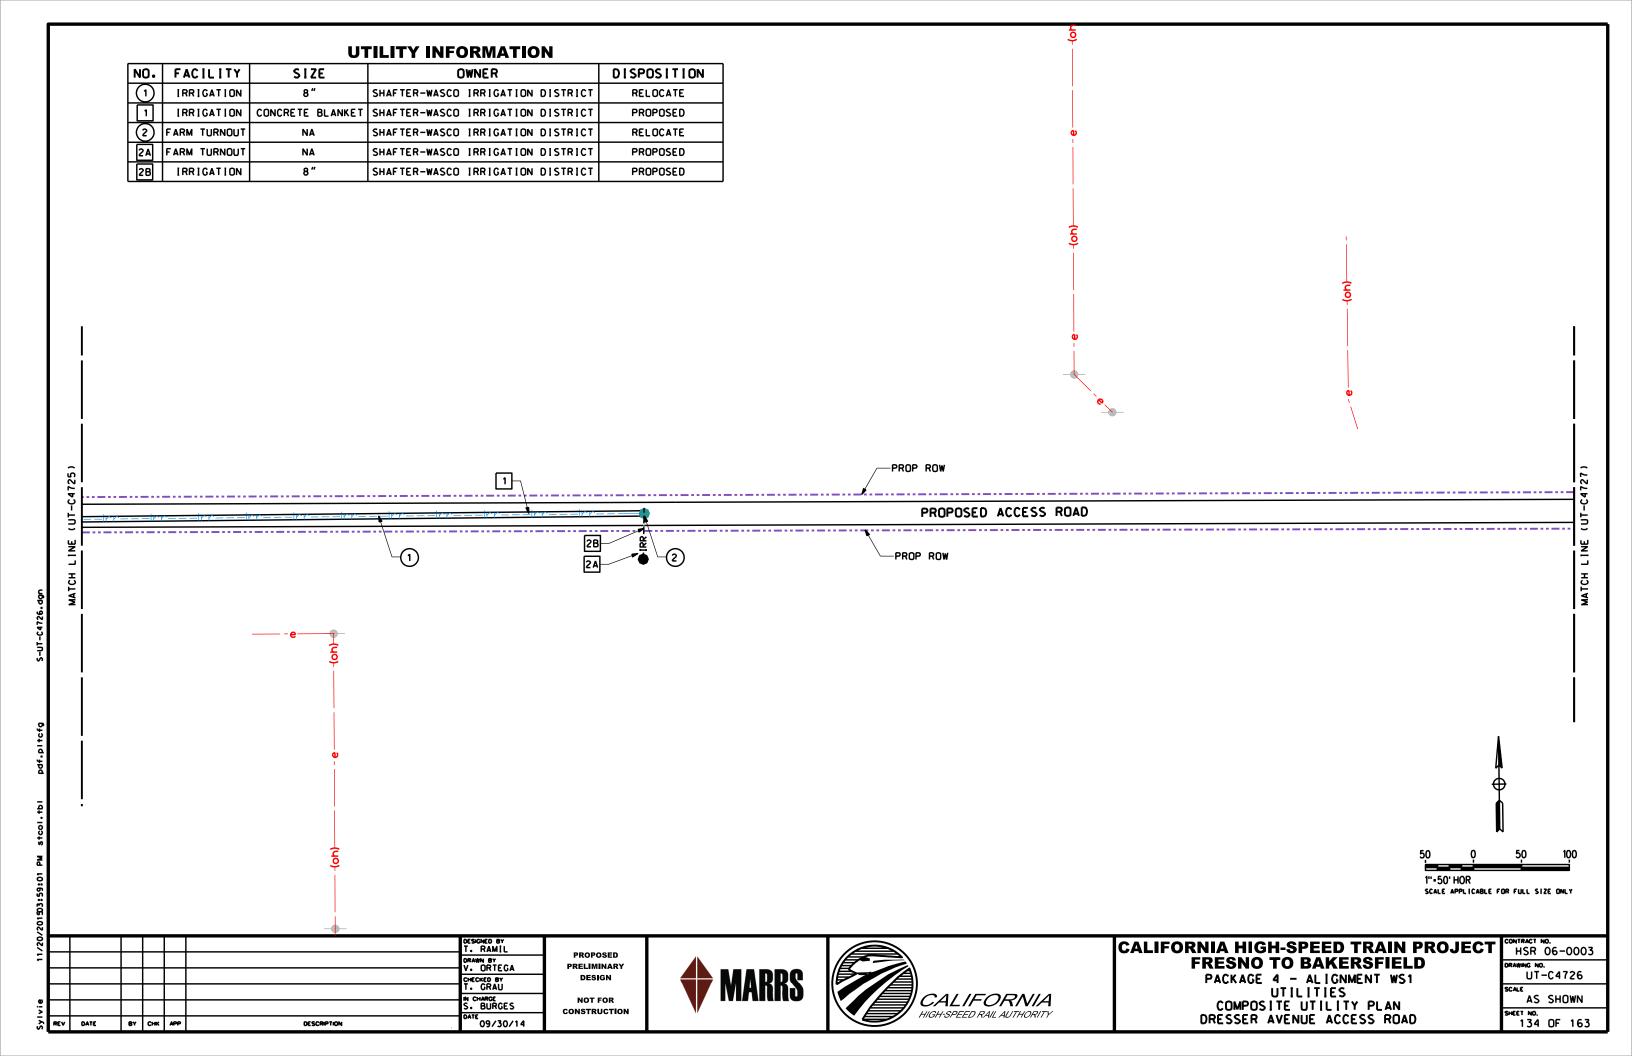
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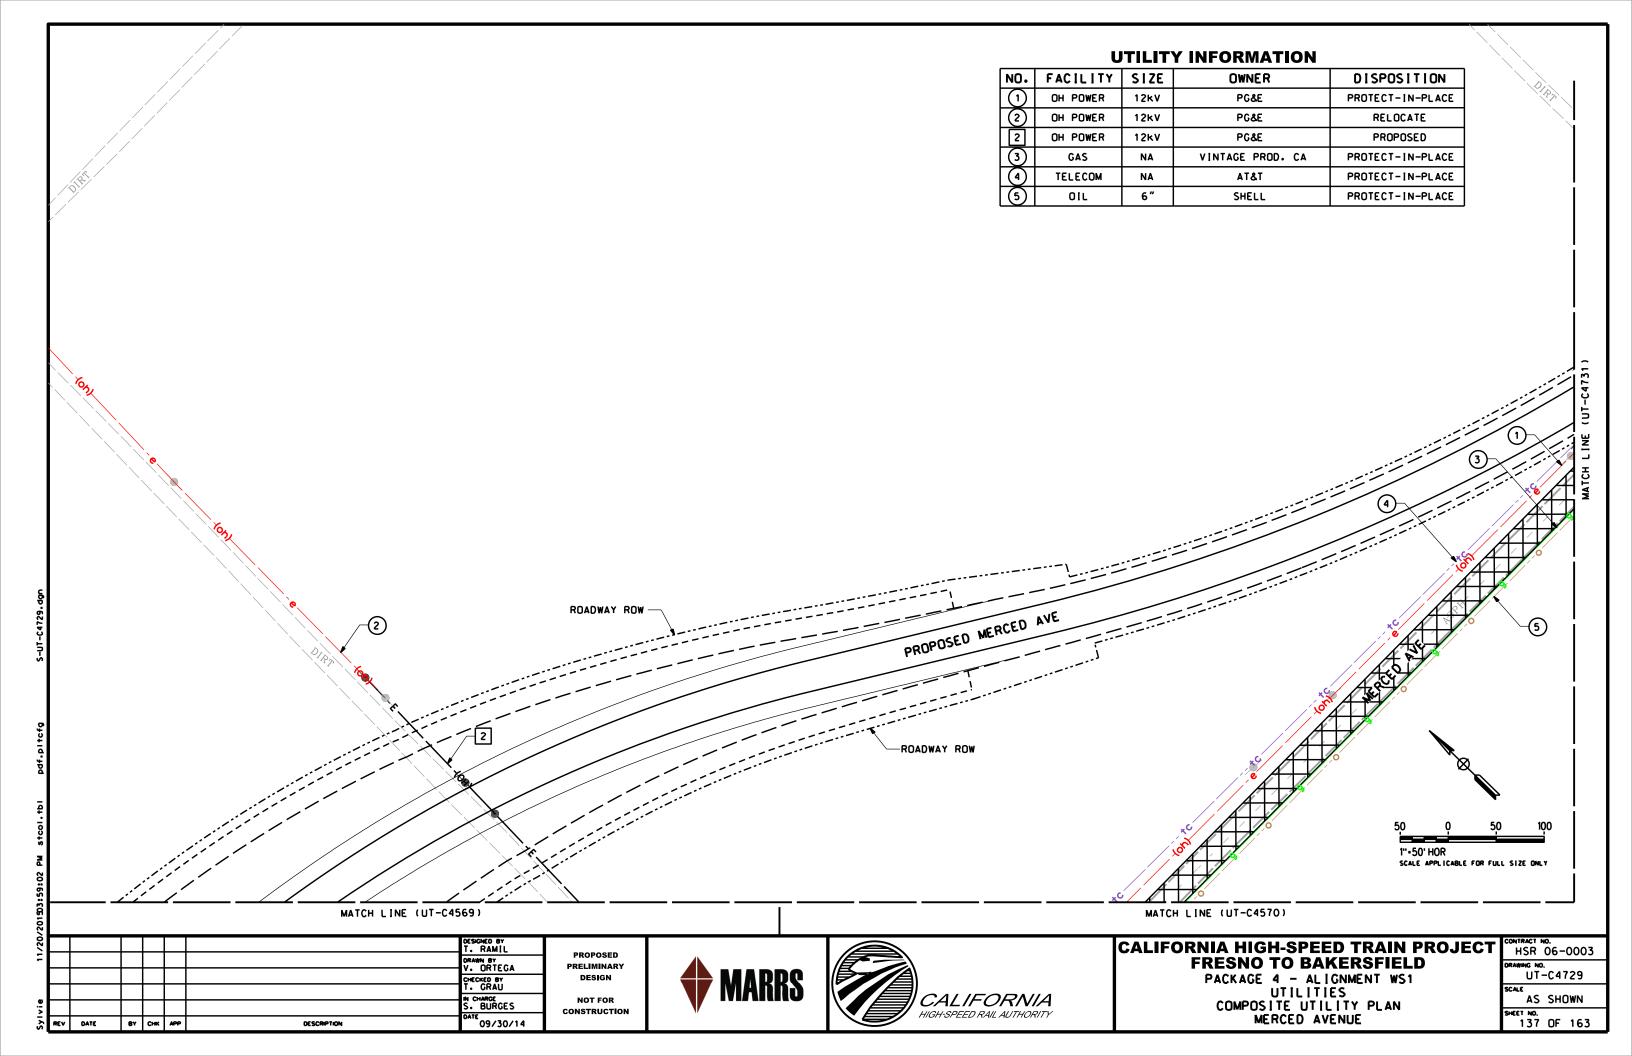
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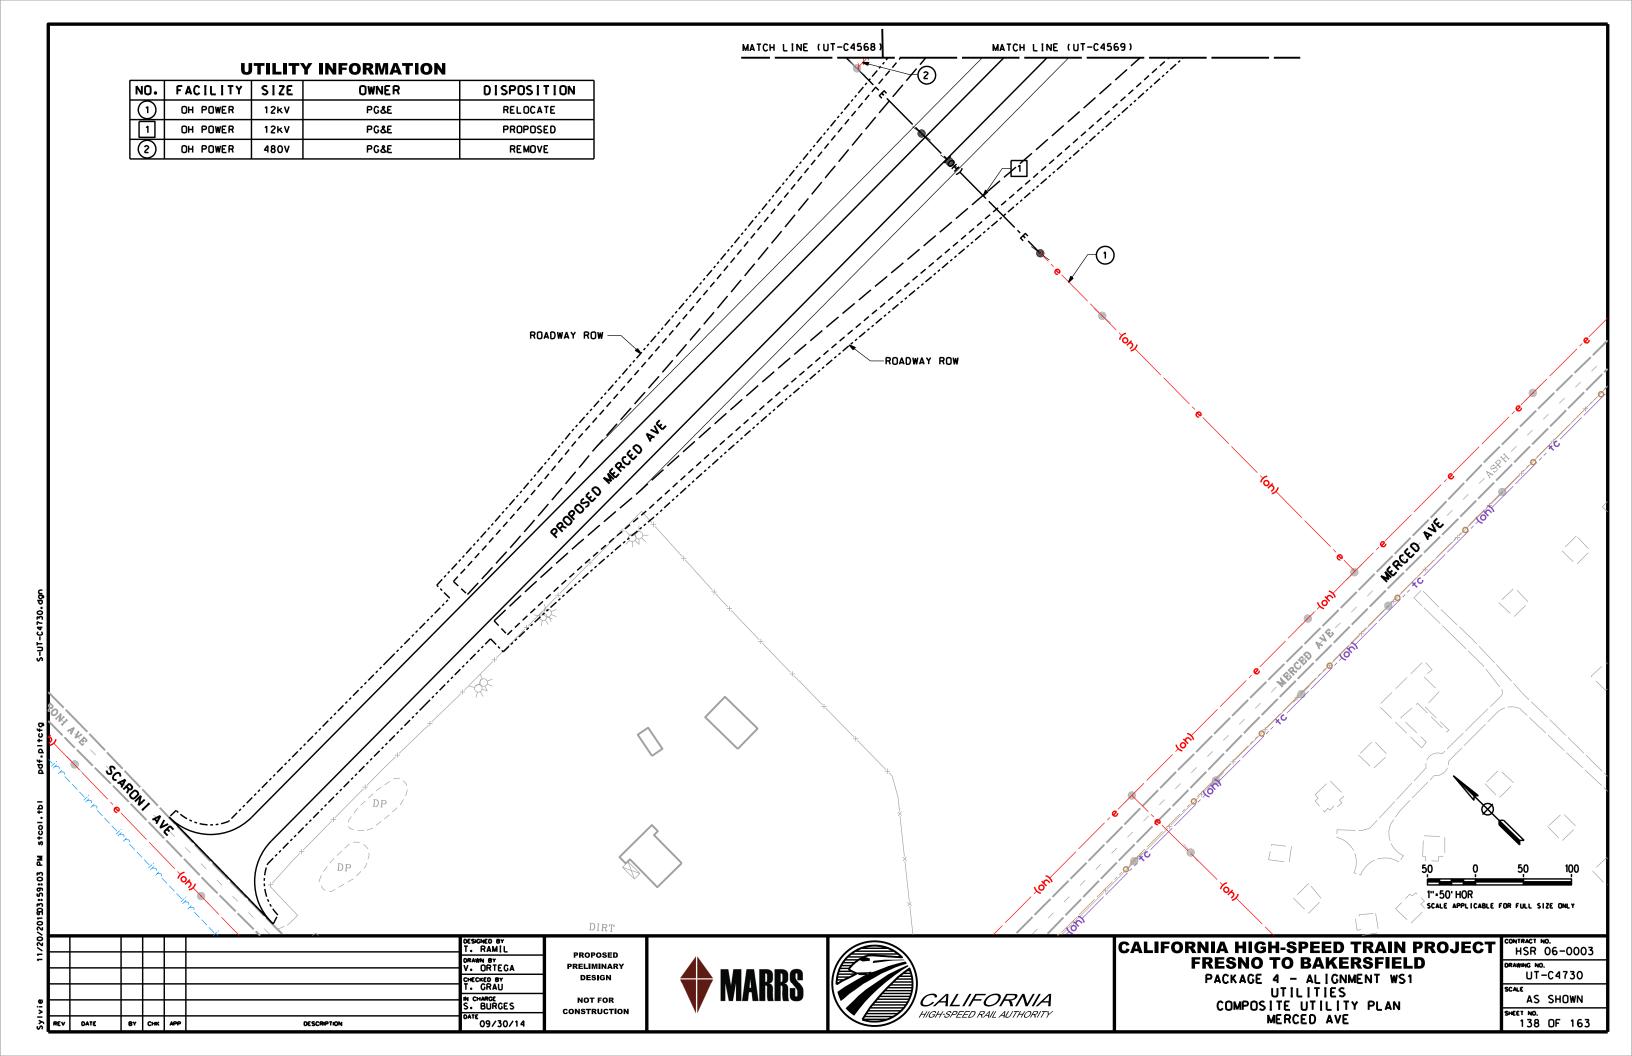
CHARGE BURGES


<sup>116</sup>09/30/14







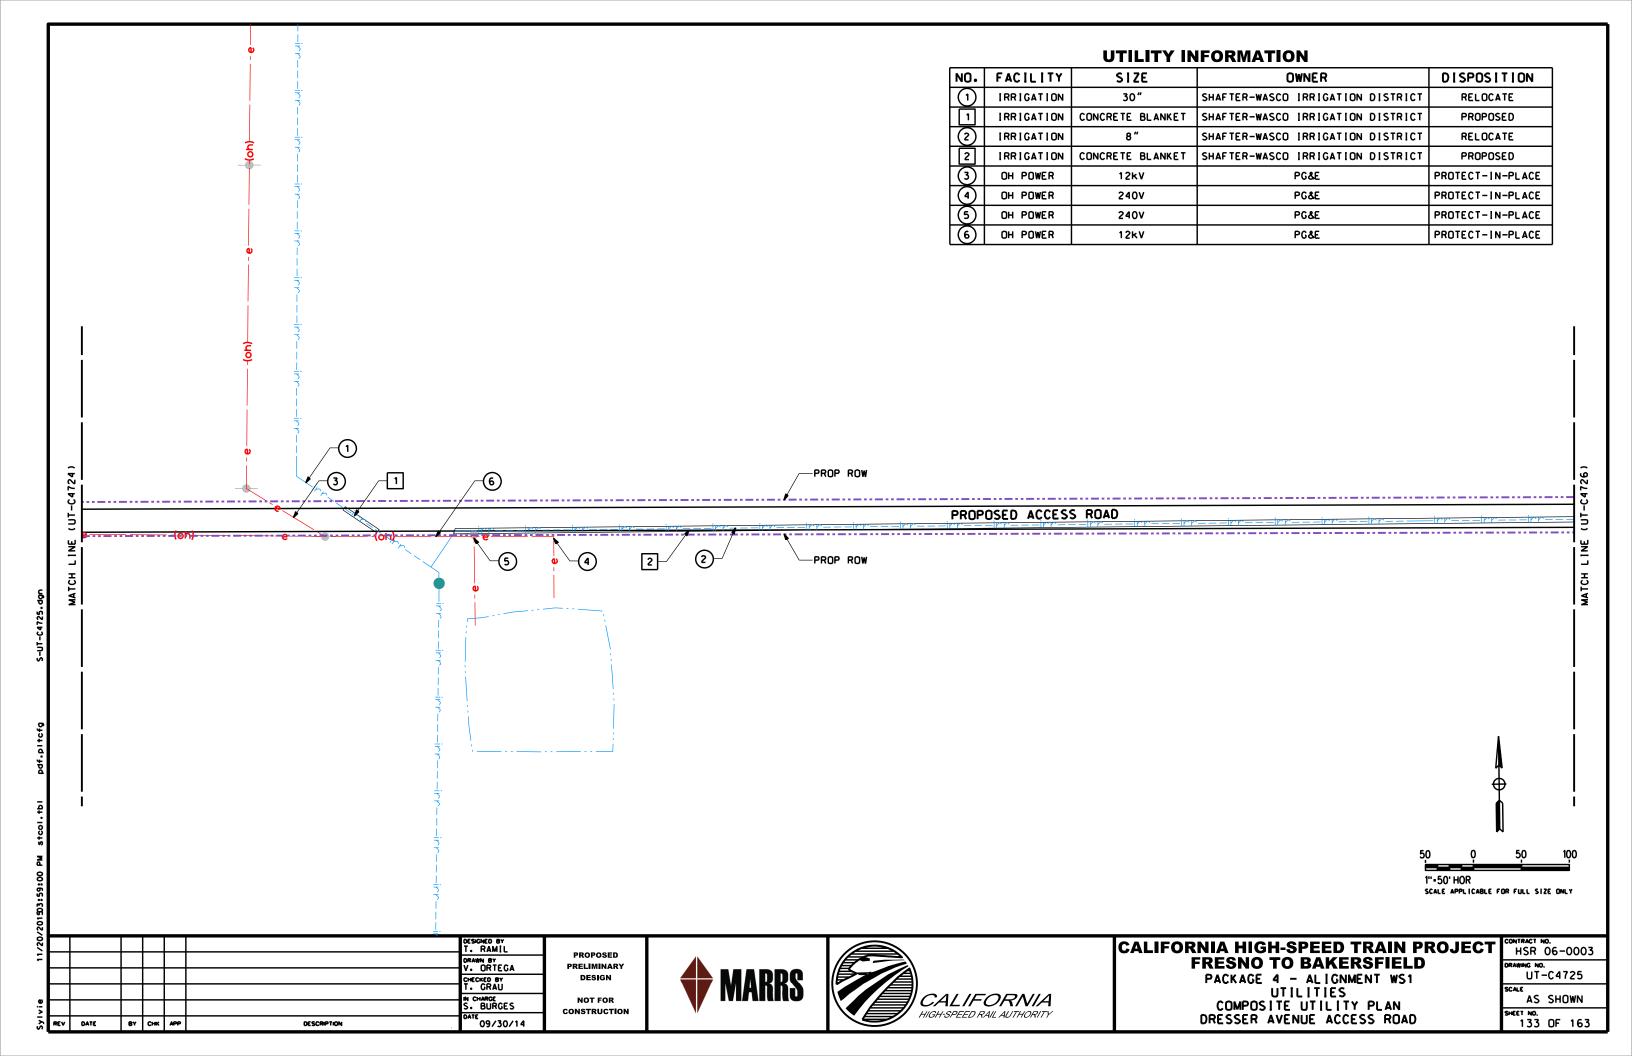

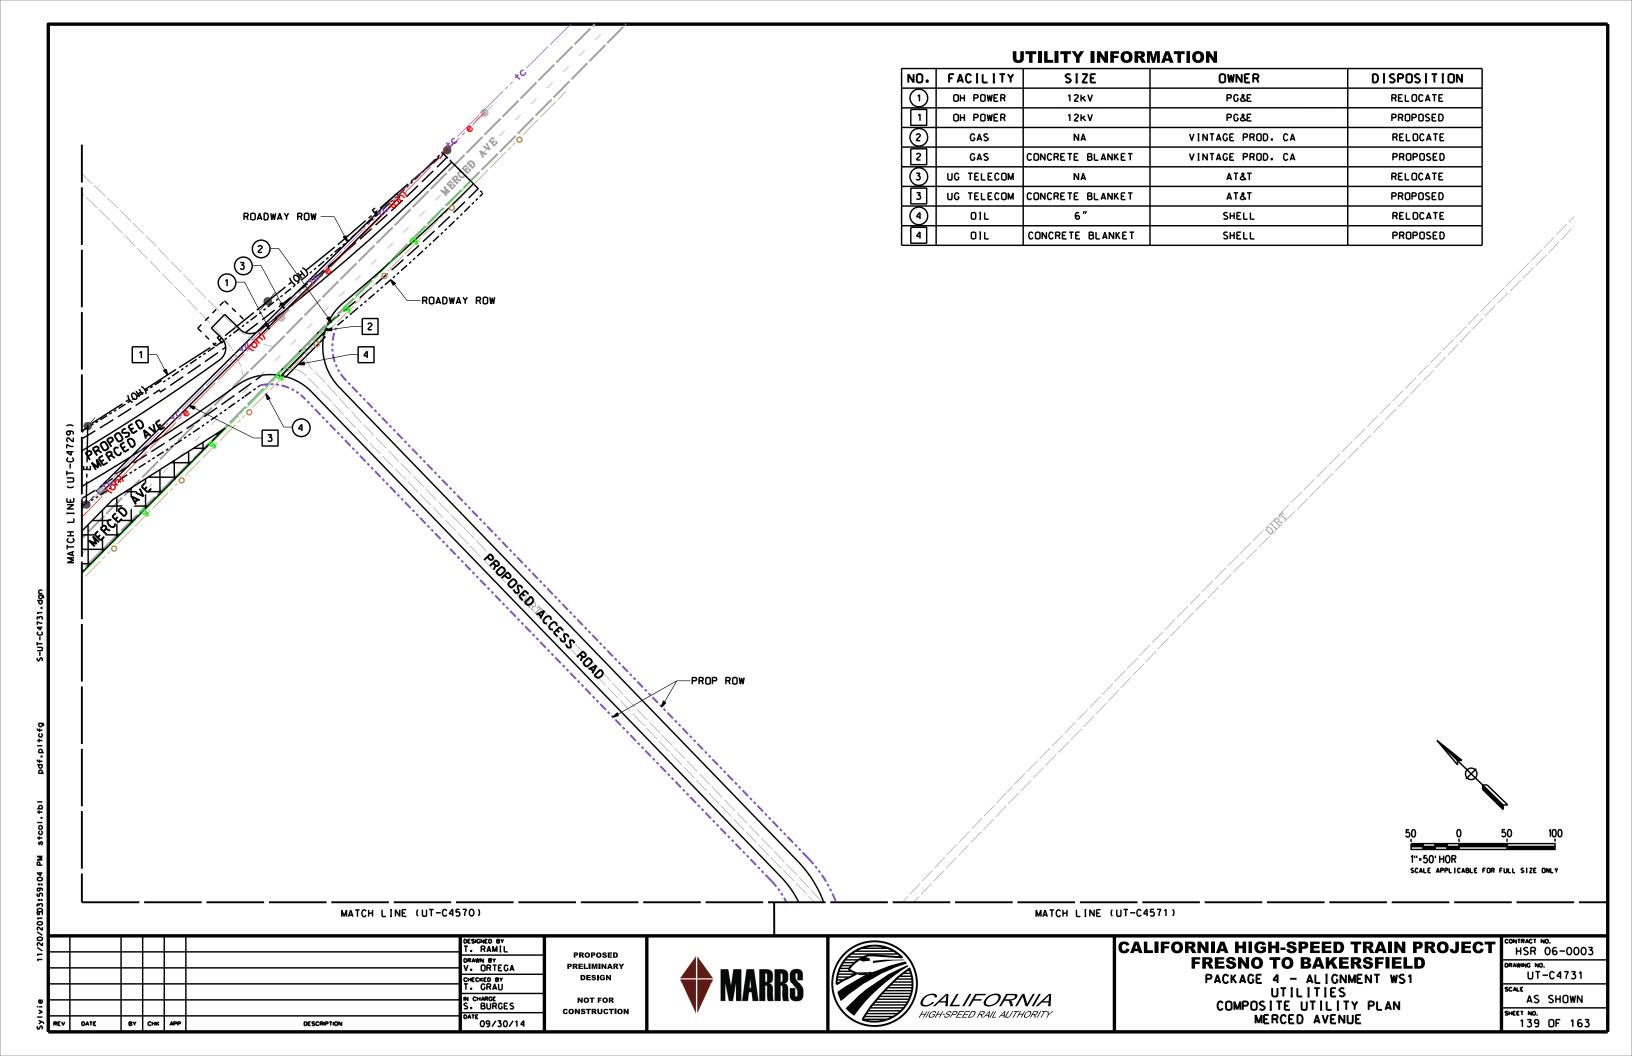



CALIFORNIA HIGH-SPEED RAIL PROJECT

Design-Build Contract for CONSTRUCTION PACKAGE 4

Proposals | RFP Number: HSR 14-32

# INDEX - TYPICAL SECTIONS - HIGH-SPEED RAIL TRACK

DRAWING No.	REV No.	DRAWING DESCRIPTION	SHEET No
2.06.01_01		TYPICAL SECTIONS - TWO TRACK - EMBANKMENT - OR CUT	1 OF 10
2.06.01_02		TYPICAL SECTIONS - TWO TRACK - RETAINED FILL	2 OF 10
2.06.01_03		TYPICAL SECTIONS - TWO TRACK - EMBANKMENT AND RETAINED FILL	3 OF 10
2.06.01_04		TYPICAL SECTIONS - TWO TRACK - LEFT SIDE EMBANKMENT AND RETAINED FILL - RIGHT SIDE EMBANKMENT	4 OF 10
2.06.01_05		TYPICAL SECTIONS - TWO TRACK - LEFT SIDE EMBANKMENT - RIGHT SIDE EMBANKMENT AND RETAINED FILL	5 OF 10
2.06.01_06		TYPICAL SECTIONS - TWO TRACK - LEFT SIDE RETAINED FILL - RIGHT SIDE EMBANKMENT	6 OF 10
2.06.01_07		TYPICAL SECTIONS - TWO TRACK - LEFT SIDE RETAINED FILL - RIGHT SIDE EMBANKMENT AND RETAINED FILL	7 OF 10
2.06.01_08		TYPICAL SECTIONS - TWO TRACK - AT.GRADE	8 OF 10
2.06.01_09		TYPICAL SECTIONS - TWO TRACK - STRUCTURES	9 OF 10
2.06.01_10		TYPICAL SECTIONS - TWO TRACK - STRUCTURES	10 OF 10

# INDEX - TYPICAL SECTIONS - ROADWAYS

DRAWING No.	REV No.	DRAWING DESCRIPTION	SHEET No
2.06.02_01		ALLENSWORTH BYPASS SUBSECTION - ALIGNMENT A1 - THROUGH WASCO SUBSECTION - ALIGNMENT WS1 ROADWAY GRADE SEPARATION - TYPICAL CROSS SECTIONS	1 OF 3
2.06.02_02		THROUGH WASCO SUBSECTION - ALIGNMENT WS1 - ROADWAY GRADE SEPARATION - TYPICAL CROSS SECTIONS	2 OF 3
2.06.02_03		THROUGH WASCO SUBSECTION - ALIGNMENT WS1 - ROADWAY GRADE SEPARATION - TYPICAL CROSS SECTIONS	3 OF 3

- PRELIMINARY, SUBJECT TO CHANGE DURING DETAIL DESIGN.

DATE							DESIGNED BY  DRAWN BY  CHECKED BY  IN CHARGE
	REV	DATE	BY	СНК	APP	DESCRIPTION	IN CHARGE

ONLY FOR
BIDDING PURPOSES
NOT FOR
CONSTRUCTION





# CALIFORNIA HIGH-SPEED TRAIN PROJECT FRESNO TO BAKERSFIELD


INDEX OF DRAWINGS TYPICAL SECTIONS

CONTRACT NO.
DRAWING NO.
2.06
SCALE
NO SCALE
SHEET NO.
1 OF 1

# TYPICAL SECTIONS HIGH-SPEED RAIL TRACK



- 1. TRACK, SYSTEMS AND DRAINAGE ARE SCHEMATIC AND DO NOT REPRESENT DESIGN.
- 2. THE CONTROL POINT (CP) SHALL BE 2'-6" ABOVE THE TOP OF SUBBALLAST.
- 3. PROTECTIVE BARRIER, SUCH AS A BERM OR A DIKE, SHALL BE INSTALLED AT THE RIGHT-OF-WAY BOUNDARY TO INTERCEPT STORM WATER RUN OFF, WHERE THERE IS A POTENTIAL FOR STORM WATER RUN OFF TO ENTER CHST RIGHT-OF-WAY FROM ADJACENT PROPERTY.

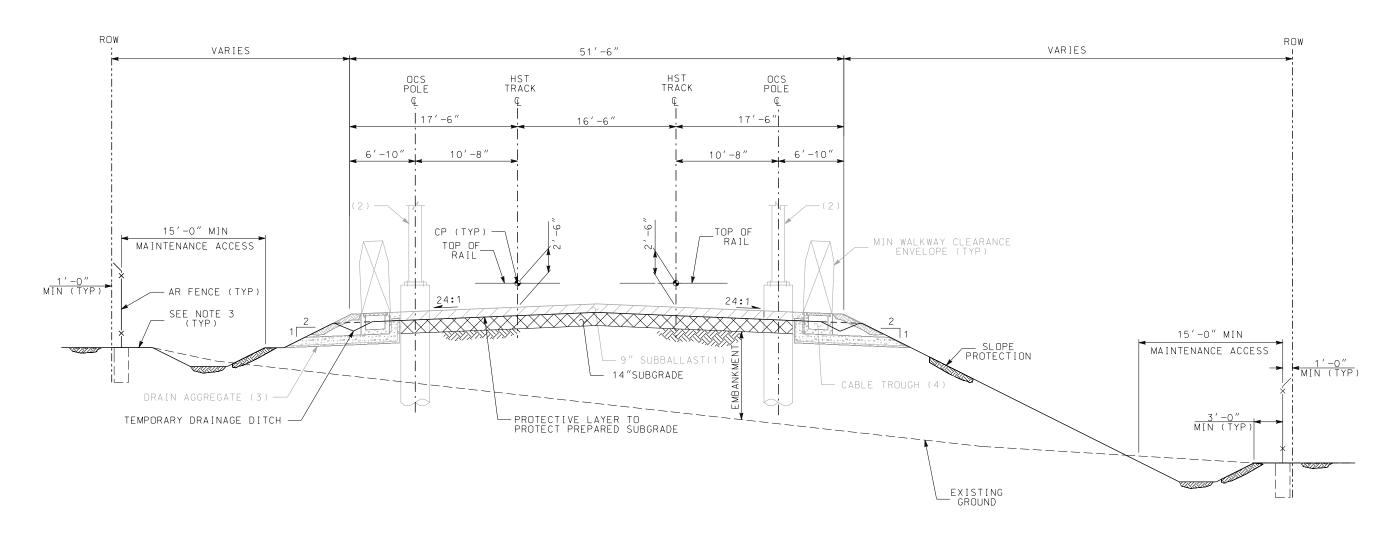

### WORK ELEMENTS NOT IN CONTRACT (NIC)

- (1) SUBBALLAST
- (2) OCS POLE AND FOUNDATION, ASSEMBLY, CONTACT WIRE, MESSENGER WIRE, NEGATIVE FEEDER, STATIC WIRE
- (3) DRAIN AGGREGATE UNDER CABLE TROUGH WITH GEOFABRIC, INTERMITTENT DRAIN AGGREGATE LAYER
- (4) CABLE TROUGH

## **SECTION 1**

TWO TRACK
EMBANKMENT AND/OR CUT
STA 4435+50.00 THROUGH STA 4597+57.27
STA 4598+37.52 THROUGH STA 4786+06.00
STA 4787+06.80 THROUGH STA 4848+43.89
STA 4849+26.89 THROUGH STA 4925+33.36
STA 5154+50.00 THROUGH STA 5191+50.00
STA 5271+60.00 THROUGH STA 5291+86.00
STA 5713+17.00 THROUGH STA 5715+72.92
STA 5716+93.45 THROUGH STA 5879+93.88



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IN CHARGE DATE							DRAWN BY	ı
DATE							CHECKED BY	ı
DATE							IN CHARGE	ı
								ı
	REV	DATE	BY	СНК	APP	DESCRIPTION	DATE	

ONLY FOR
BIDDING PURPOSES

NOT FOR
CONSTRUCTION






# CALIFORNIA HIGH-SPEED TRAIN PROJECT FRESNO TO BAKERSFIELD

TYPICAL SECTIONS
TWO TRACK
EMBANKMENT AND/OR CUT

CONTRACT NO.
DRAWING NO. 2.06.01_01
AS SHOWN

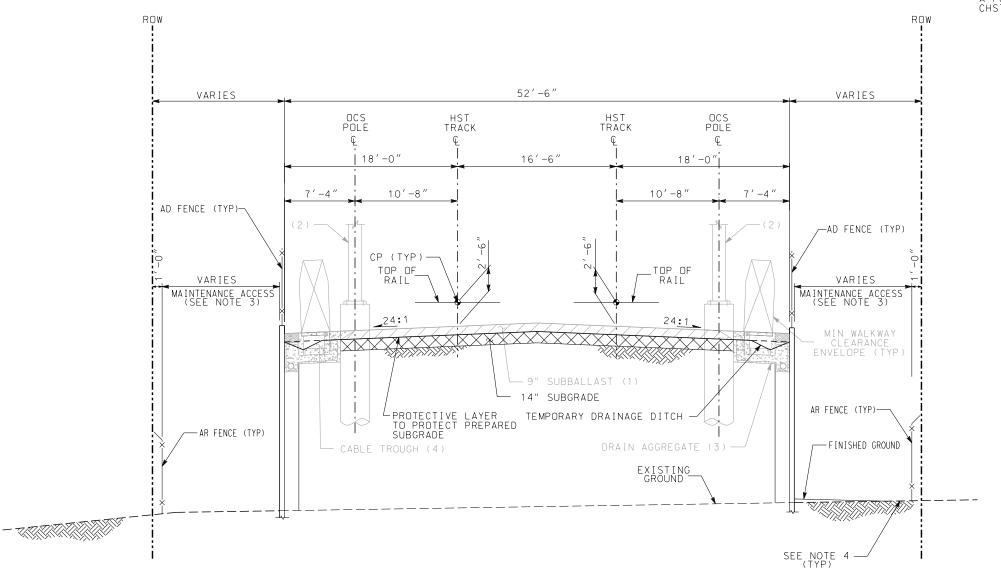

### NOTE

- 1. TRACK, SYSTEMS AND DRAINAGE ARE SCHEMATIC AND DO NOT REPRESENT DESIGN.
- 2. THE CONTROL POINT (CP) SHALL BE 2'-6" ABOVE THE TOP OF SUBBALLAST.
- 3. 10' MIN MAINTENANCE ACCESS REQUIRED WHEN THERE IS NO FENCE OR CONTINUOUS OBSTRUCTION.
- 4. PROTECTIVE BARRIER, SUCH AS A BERM OR A DIKE, SHALL BE INSTALLED AT THE RIGHT-OF-WAY BOUNDARY TO INTERCEPT STORM WATER RUN OFF, WHERE THERE IS A POTENTIAL FOR STORM WATER RUN OFF TO ENTER CHST RIGHT-OF-WAY FROM ADJACENT PROPERTY.

# WORK ELEMENTS NOT IN CONTRACT (NIC)

- (1) SUBBALLAST
- (2) OCS POLE AND FOUNDATION, ASSEMBLY, CONTACT WIRE, MESSENGER WIRE, NEGATIVE FEEDER, STATIC WIRE
- (3) DRAIN AGGREGATE UNDER CABLE TROUGH WITH GEOFABRIC, INTERMITTENT DRAIN AGGREGATE LAYER
- (4) CABLE TROUGH

# 5 0 5 10 SCALE: 1"=5'

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ONLY FOR
BIDDING PURPOSES
NOT FOR
CONSTRUCTION



SECTION 2

TWO TRACK
RETAINED FILL

STA 5525+00.00 THROUGH STA 5538+35.66 STA 5539+75.66 THROUGH STA 5556+48.00 STA 5557+68.00 THROUGH STA 5572+08.00 STA 5612+20.00 THROUGH STA 5654+45.00 STA 5678+90.00 THROUGH STA 5682+94.00



# CALIFORNIA HIGH-SPEED TRAIN PROJECT FRESNO TO BAKERSFIELD


TYPICAL SECTIONS
TWO TRACK
RETAINED FILL

CON	TRACT NO.
DRA	wing no. 2.06.01_02
SCA	LE

SHEET NO.

2 OF 10

- 1. TRACK. SYSTEMS AND DRAINAGE ARE SCHEMATIC AND DO NOT REPRESENT DESIGN.
- 2. THE CONTROL POINT (CP) SHALL BE 2'-6" ABOVE THE TOP OF SUBBALLAST.
- 3. PROTECTIVE BARRIER, SUCH AS A BERM OR A DIKE, SHALL BE INSTALLED AT THE RIGHT-OF-WAY BOUNDARY TO INTERCEPT STORM WATER RUN OFF, WHERE THERE IS A POTENTIAL FOR STORM WATER RUN OFF TO ENTER CHST RIGHT-OF-WAY FROM ADJACENT PROPERTY.

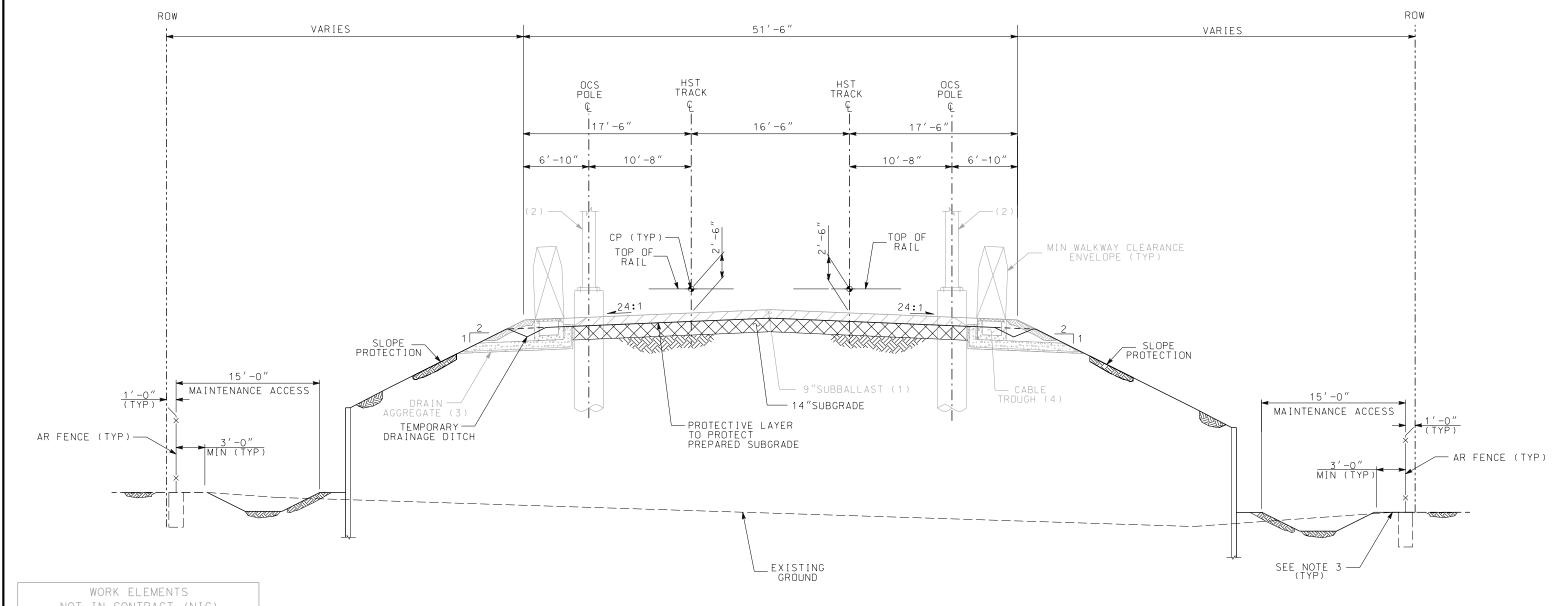

# NOT IN CONTRACT (NIC)

(1) SUBBALLAST

(2) OCS POLE AND FOUNDATION,
ASSEMBLY, CONTACT WIRE,
MESSENGER WIRE, NEGATIVE
FEEDER, STATIC WIRE

(3) DRAIN AGGREGATE UNDER CABLE TROUGH WITH GEOFABRIC, INTERMITTENT DRAIN AGGREGATE LAYER

(4) CABLE TROUGH

# SECTION 3

TWO TRACK
EMBANKMENT AND RETAINED FILL
STA 5191+50.00 THROUGH STA 5225+53.00
STA 5227+67.00 THROUGH STA 5271+60.00

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CONSTRUCTION





# CALIFORNIA HIGH-SPEED TRAIN PROJECT FRESNO TO BAKERSFIELD

TYPICAL SECTIONS
TWO TRACK
EMBANKMENT AND RETAINED FILL

CONTRACT NO.
DRAWING NO.
2.06.01_03
SCALE
AS SHOWN
AS 5110 MIN
SHEET NO.


3 OF 10

SCALE: 1"=5'

- (1) SUBBALLAST
- (2) OCS POLE AND FOUNDATION, ASSEMBLY, CONTACT WIRE, MESSENGER WIRE, NEGATIVE FEEDER, STATIC WIRE
- (3) DRAIN AGGREGATE UNDER CABLE TROUGH WITH GEOFABRIC, INTERMITTENT DRAIN AGGREGATE LAYER
- (4) CABLE TROUGH

### NOTES:

- 1. TRACK, SYSTEMS AND DRAINAGE ARE SCHEMATIC AND DO NOT REPRESENT DESIGN.
- 2. THE CONTROL POINT (CP) SHALL BE 2'-6" ABOVE THE TOP OF SUBBALLAST.
- 3. PROTECTIVE BARRIER, SUCH AS A BERM OR A DIKE, SHALL BE INSTALLED AT THE RIGHT-OF-WAY BOUNDARY TO INTERCEPT STORM WATER RUN OFF, WHERE THERE IS A POTENTIAL FOR STORM WATER RUN OFF TO ENTER CHST RIGHT-OF-WAY FROM ADJACENT PROPERTY.

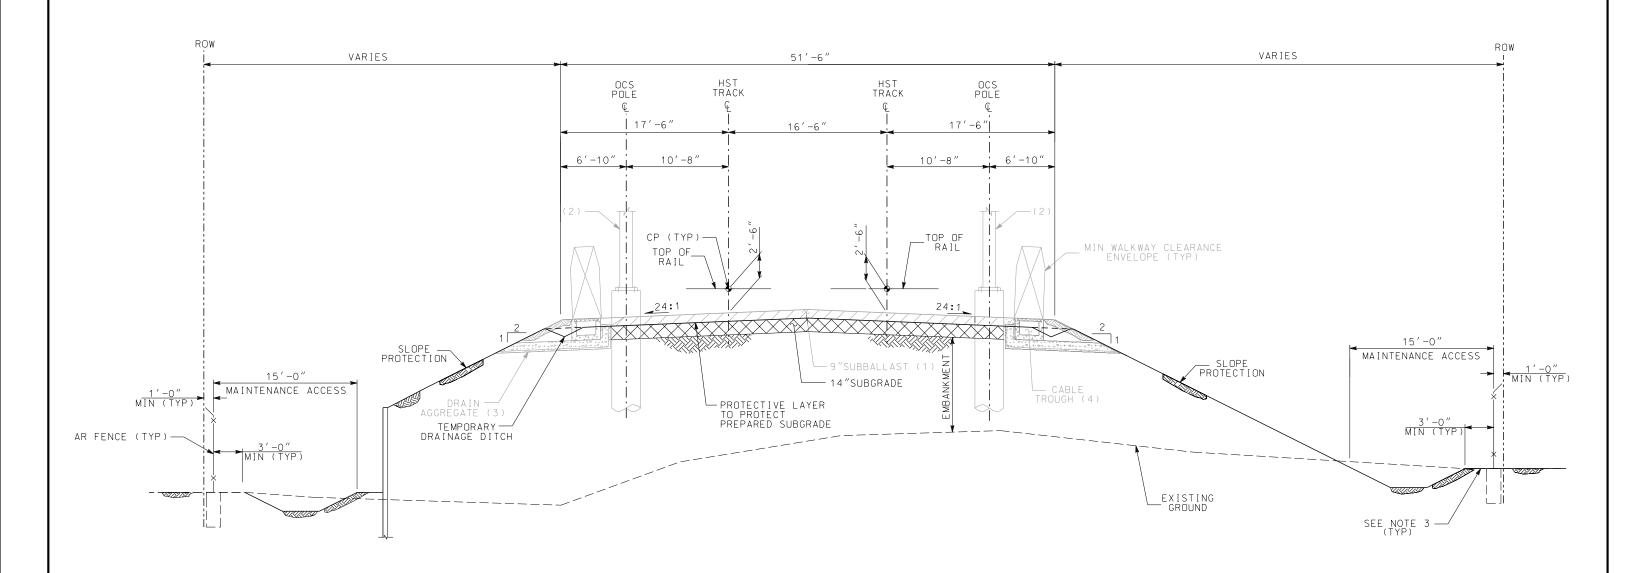

# **SECTION 4**

TWO TRACK LEFT SIDE EMBANKMENT AND RETAINED FILL RIGHT SIDE EMBANKMENT STA 5291+86.00 THROUGH STA 5298+50.00



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# CALIFORNIA HIGH-SPEED TRAIN PROJECT FRESNO TO BAKERSFIELD


TYPICAL SECTIONS
TWO TRACK
LEFT SIDE EMBANKMENT AND RETAINED FILL
RIGHT SIDE EMBANKMENT

CONTRACT NO.
2.06.01_04
AS SHOWN
SHEET NO. 4 OF 10

- (1) SUBBALLAST
- (2) OCS POLE AND FOUNDATION, ASSEMBLY, CONTACT WIRE, MESSENGER WIRE, NEGATIVE FEEDER, STATIC WIRE
- (3) DRAIN AGGREGATE UNDER CABLE TROUGH WITH GEOFABRIC, INTERMITTENT DRAIN AGGREGATE LAYER
- (4) CABLE TROUGH

### NOTES:

- 1. TRACK, SYSTEMS AND DRAINAGE ARE SCHEMATIC AND DO NOT REPRESENT DESIGN.
- 2. THE CONTROL POINT (CP) SHALL BE 2'-6" ABOVE THE TOP OF SUBBALLAST.
- 3. PROTECTIVE BARRIER, SUCH AS A BERM OR A DIKE, SHALL BE INSTALLED AT THE RIGHT-OF-WAY BOUNDARY TO INTERCEPT STORM WATER RUN OFF, WHERE THERE IS A POTENTIAL FOR STORM WATER RUN OFF TO ENTER CHST RIGHT-OF-WAY FROM ADJACENT PROPERTY.

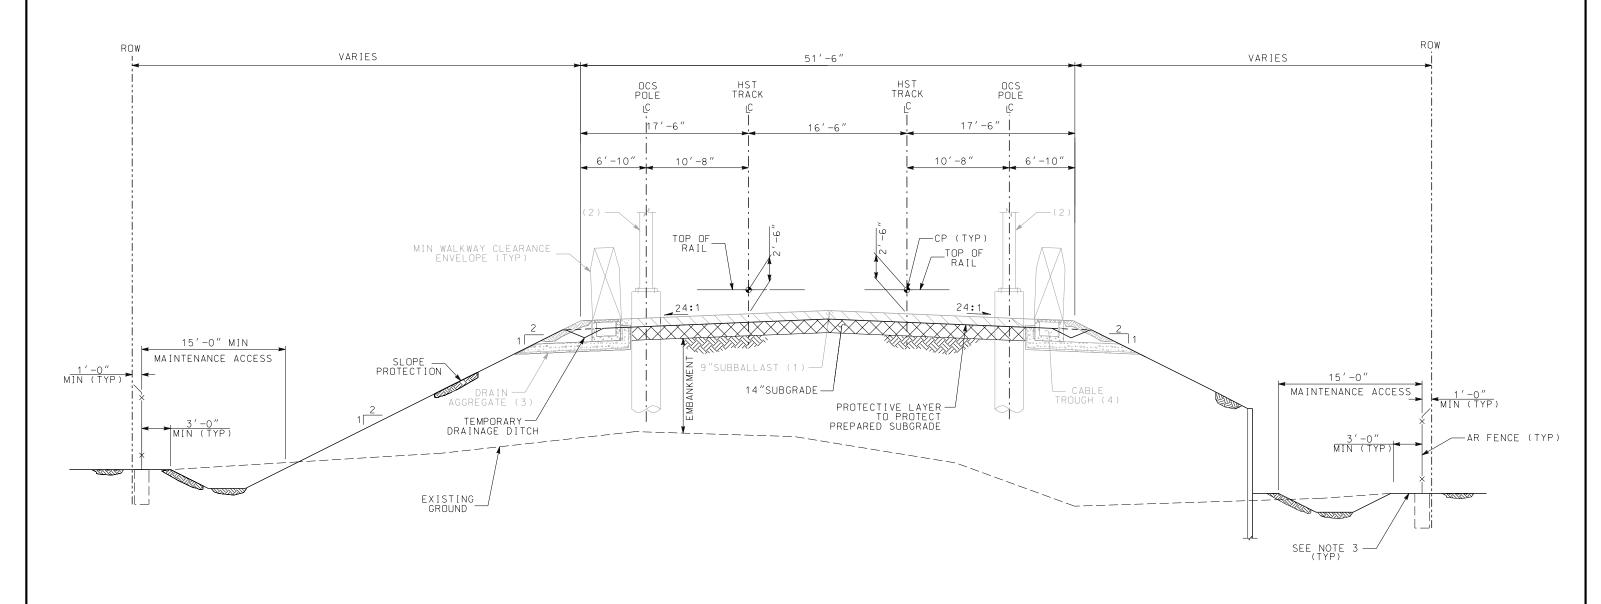

# **SECTION 5**

TWO TRACK
LEFT SIDE EMBANKMENT
RIGHT SIDE EMBANKMENT AND RETAINED FILL
STA 5709+48.00 THROUGH STA 5713+17.00



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# CALIFORNIA HIGH-SPEED TRAIN PROJECT FRESNO TO BAKERSFIELD

TYPICAL SECTIONS
TWO TRACK
LEFT SIDE EMBANKMENT
RIGHT SIDE EMBANKMENT AND RETAINED FILL


CONTRACT NO.
DRAWING NO.
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AS SHOWN
A5 5110 III
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### (1) SUBBALLAST

- (2) OCS POLE AND FOUNDATION, ASSEMBLY, CONTACT WIRE, MESSENGER WIRE, NEGATIVE FEEDER, STATIC WIRE
- (3) DRAIN AGGREGATE UNDER CABLE TROUGH WITH GEOFABRIC, INTERMITTENT DRAIN AGGREGATE LAYER
- (4) CABLE TROUGH

### NOTES:

- 1. TRACK, SYSTEMS AND DRAINAGE ARE SCHEMATIC AND DO NOT REPRESENT DESIGN.
- 2. THE CONTROL POINT (CP) SHALL BE 2'-6" ABOVE THE TOP OF SUBBALLAST.
- 3. PROTECTIVE BARRIER, SUCH AS A BERM OR A DIKE, SHALL BE INSTALLED AT THE RIGHT-OF-WAY BOUNDARY TO INTERCEPT STORM WATER RUN OFF, WHERE THERE IS A POTENTIAL FOR STORM WATER RUN OFF TO ENTER CHST RIGHT-OF-WAY FROM ADJACENT PROPERTY.
- 4. 10' MIN MAINTENANCE ACCESS REQUIRED WHEN THERE IS NO FENCE OR CONTINUOUS OBSTRUCTION.

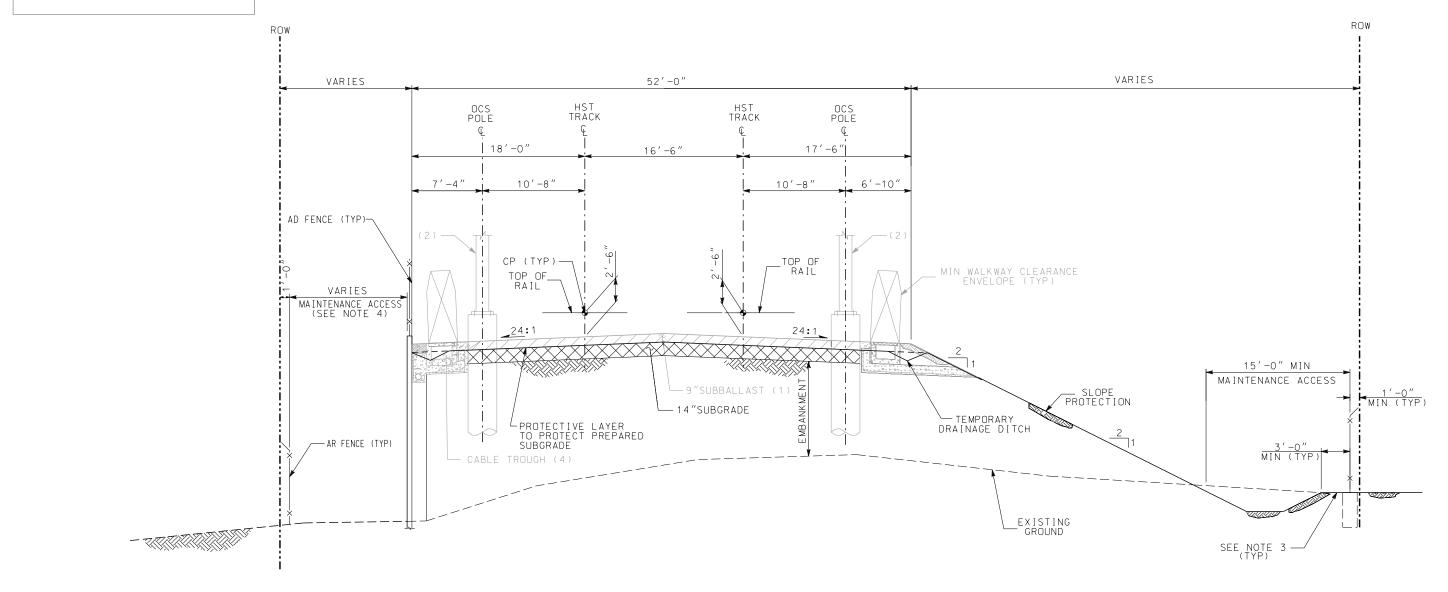

# **SECTION 6**

TWO TRACK

LEFT SIDE RETAINED FILL

RIGHT SIDE EMBANKMENT

STA 5298+50.00 THROUGH STA 5322+33.13
STA 5422+50.00 THROUGH STA 5505+70.00



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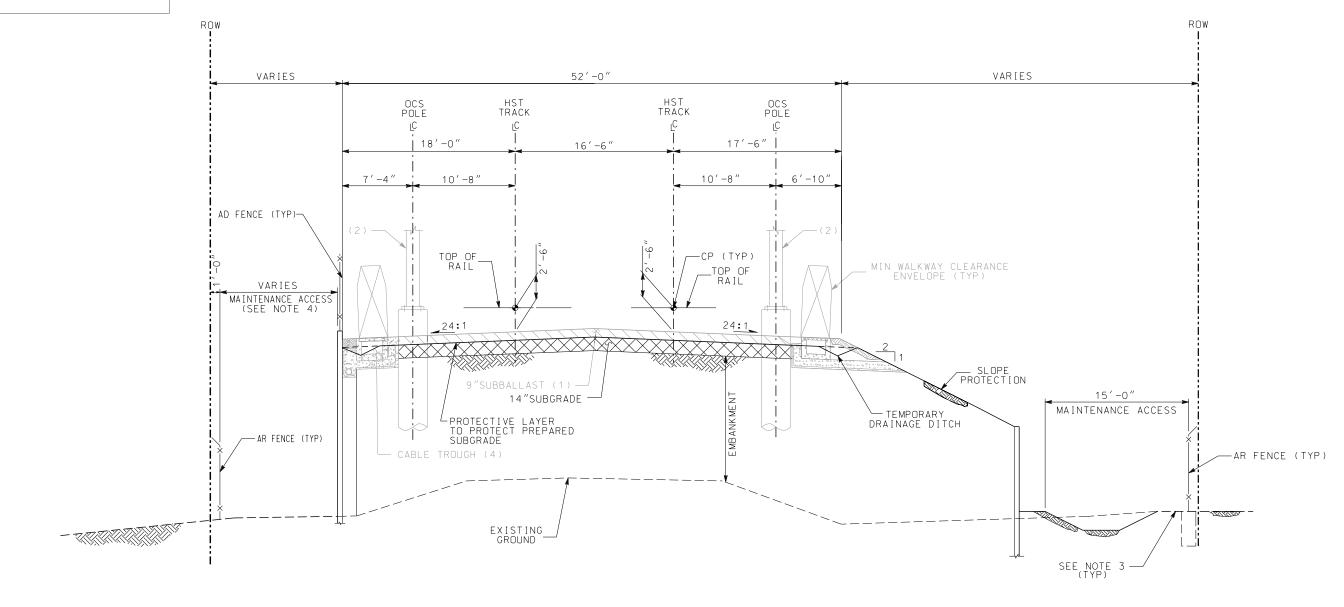
TYPICAL SECTIONS
TWO TRACK
LEFT SIDE RETAINED FILL
RIGHT SIDE EMBANKMENT

CONTRACT NO.
DRAWING NO. 2.06.01_06
SCALE
AS SHOWN
3HEET 1404

- (1) SUBBALLAST
- (2) OCS POLE AND FOUNDATION, ASSEMBLY, CONTACT WIRE, MESSENGER WIRE, NEGATIVE FEEDER, STATIC WIRE
- (3) DRAIN AGGREGATE UNDER CABLE TROUGH WITH GEOFABRIC, INTERMITTENT DRAIN AGGREGATE LAYER
- (4) CABLE TROUGH

### NOTES:

- 1. TRACK, SYSTEMS AND DRAINAGE ARE SCHEMATIC AND DO NOT REPRESENT DESIGN.
- 2. THE CONTROL POINT (CP) SHALL BE 2'-6" ABOVE THE TOP OF SUBBALLAST.
- 3. PROTECTIVE BARRIER, SUCH AS A BERM OR A DIKE, SHALL BE INSTALLED AT THE RIGHT-OF-WAY BOUNDARY TO INTERCEPT STORM WATER RUN OFF, WHERE THERE IS A POTENTIAL FOR STORM WATER RUN OFF TO ENTER CHST RIGHT-OF-WAY FROM ADJACENT PROPERTY.
- 4. 10' MIN MAINTENANCE ACCESS REQUIRED WHEN THERE IS NO FENCE OR CONTINUOUS OBSTRUCTION.



# **SECTION 7**

TWO TRACK
LEFT SIDE RETAINED FILL
RIGHT SIDE EMBANKMENT AND RETAINED FILL
STA 5505+70.00 THROUGH STA 5525+00.00
STA 5682+94.00 THROUGH STA 5709+48.00



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# CALIFORNIA HIGH-SPEED TRAIN PROJECT FRESNO TO BAKERSFIELD

TYPICAL SECTIONS


TWO TRACK

LEFT SIDE RETAINED FILL

RIGHT SIDE EMBANKMENT AND RETAINED FILL

CONTRACT NO.
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2.06.01_07
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- 1. TRACK, SYSTEMS AND DRAINAGE ARE SCHEMATIC AND DO NOT REPRESENT DESIGN.
- 2. THE CONTROL POINT (CP) SHALL BE 2'-6" ABOVE THE TOP OF SUBBALLAST.
- 3. 10' MIN MAINTENANCE ACCESS REQUIRED WHEN THERE IS NO FENCE OR CONTINUOUS OBSTRUCTION.
- 4. PROTECTIVE BARRIER, SUCH AS A BERM OR A DIKE, SHALL BE INSTALLED AT THE RIGHT-OF-WAY BOUNDARY TO INTERCEPT STORM WATER RUN OFF, WHERE THERE IS A POTENTIAL FOR STORM WATER RUN OFF TO ENTER CHST RIGHT-OF-WAY FROM ADJACENT PROPERTY.

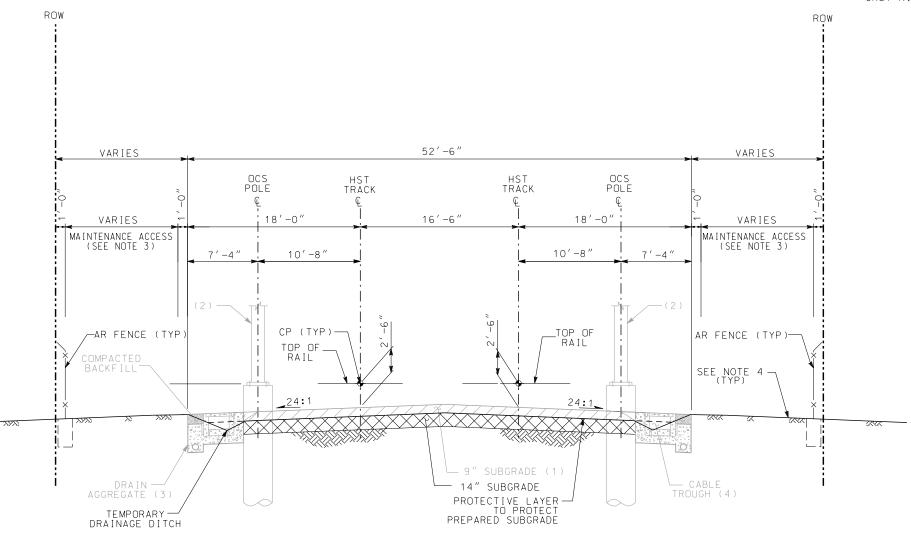

# WORK ELEMENTS NOT IN CONTRACT (NIC)

- (1) SUBBALLAST
- (2) OCS POLE AND FOUNDATION, ASSEMBLY, CONTACT WIRE, MESSENGER WIRE, NEGATIVE FEEDER, STATIC WIRE
- (3) DRAIN AGGREGATE UNDER CABLE TROUGH WITH GEOFABRIC, INTERMITTENT DRAIN AGGREGATE LAYER
- (4) CABLE TROUGH

# SECTION 8

TWO TRACK AT. GRADE STA 5572+08.00 THROUGH STA 5578+39.25 STA 5578+69.75 THROUGH STA 5609+57.25 STA 5609+87.75 THROUGH STA 5612+20.00



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CONSTRUCTION






# CALIFORNIA HIGH-SPEED TRAIN PROJECT FRESNO TO BAKERSFIELD

TYPICAL SECTIONS
TWO TRACK
AT.GRADE

CONTRACT NO.
DRAWING NO. 2.06.01_08
SCALE
AS SHOWN


8 OF 10

SHEET NO.

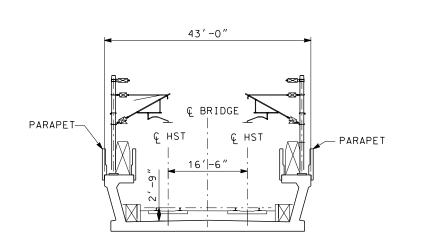


VIADUCT OVER GARCES HWY STA 4597+57.27 THROUGH STA 4598+37.52



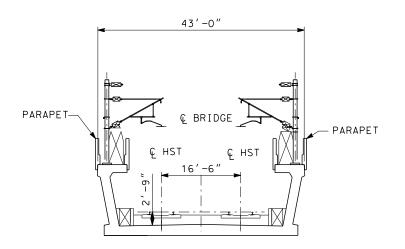


# SECTION 10

VIADUCT OVER POND RD STA 4786+06.00 THROUGH STA 4787+06.80

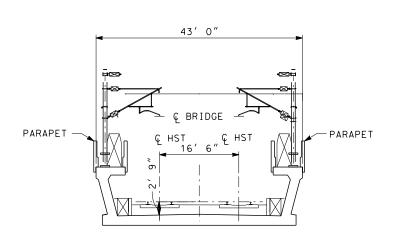


**SECTION 11** 

VIADUCT OVER PETERSON RD STA 4848+43.89 THROUGH STA 4849+26.89

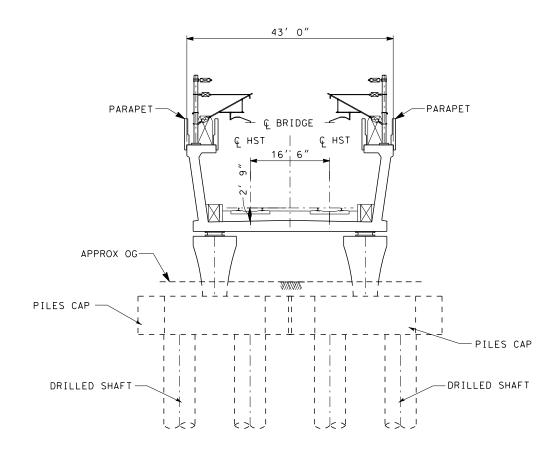


# SECTION 12

VIADUCT OVER POSO CREEK STA 5225+53 THROUGH STA 5227+67.00

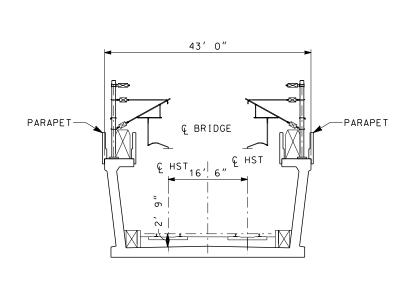

## SECTION 13

VIADUCT OVER SUNNYGEM STA 5538+35.66 THROUGH STA 5539+75.66

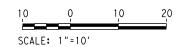

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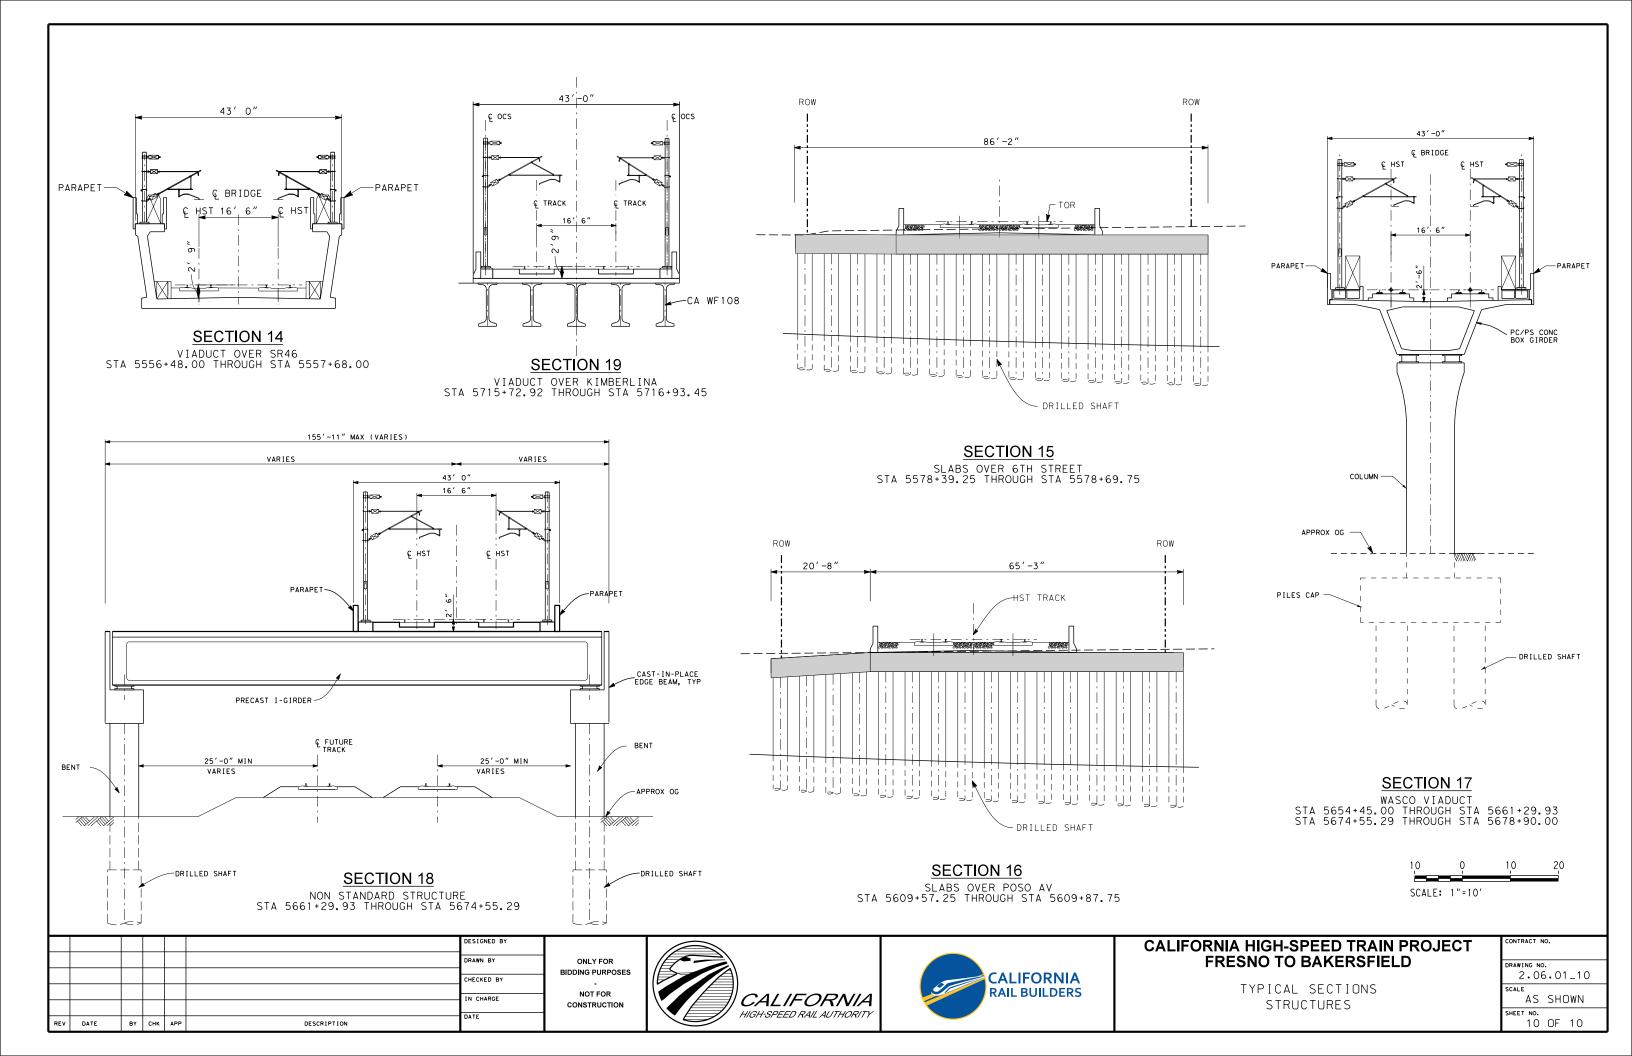




# CALIFORNIA HIGH-SPEED TRAIN PROJECT FRESNO TO BAKERSFIELD

TYPICAL SECTIONS STRUCTURES


CONTRACT NO.
DRAWING NO. 2.06.01_09
AS SHOWN
SHEET NO. 9 OF 10




# TYPICAL SECTIONS ROADWAYS



1. SUPERELEVATION AS SHOWN OR AS DIRECTED BY THE ENGINEER.

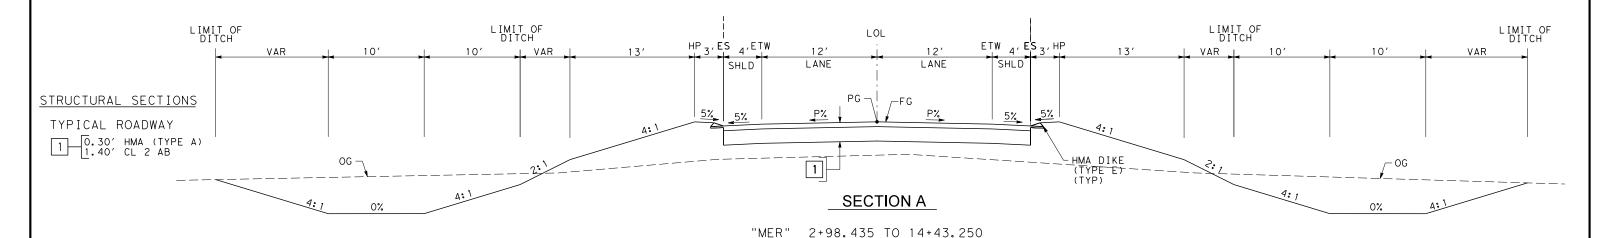

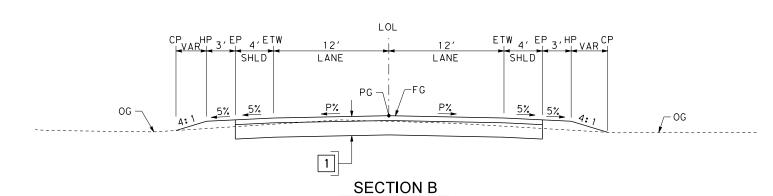


"MER" 19+28.590 TO 40+00.000

"SCO" 11+00.000 TO 78+62.800
"MAG" 10+00.000 TO 43+80.431
"MCAC" 20+00.000 TO 26+78.870
"AMCC" 0+00.000 TO 4+63.234
"MER" 0+10.000 TO 2+98.435
"MER" 40+00.000 TO 43+90.950

### TABLE OF DESIGN SPEEDS

STREET NAME	ALIGNMENT DESIGNATION	DESIGN SPEED	CRITERIA / JURISDICTION
SCOFIELD AVE	SCO	45	KERN COUNTY/KERN COUNTY
MAGNOLIA AVE	MAG	45	KERN COUNTY/KERN COUNTY
ANNIN CONNECTOR AND MCCOMBS CONNECTOR	AMCC/MCAC	25	KERN COUNTY/KERN COUNTY
MERCED AVE	MER	55	CITY OF SHAFTER/CITY OF SHAFTER

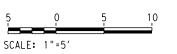

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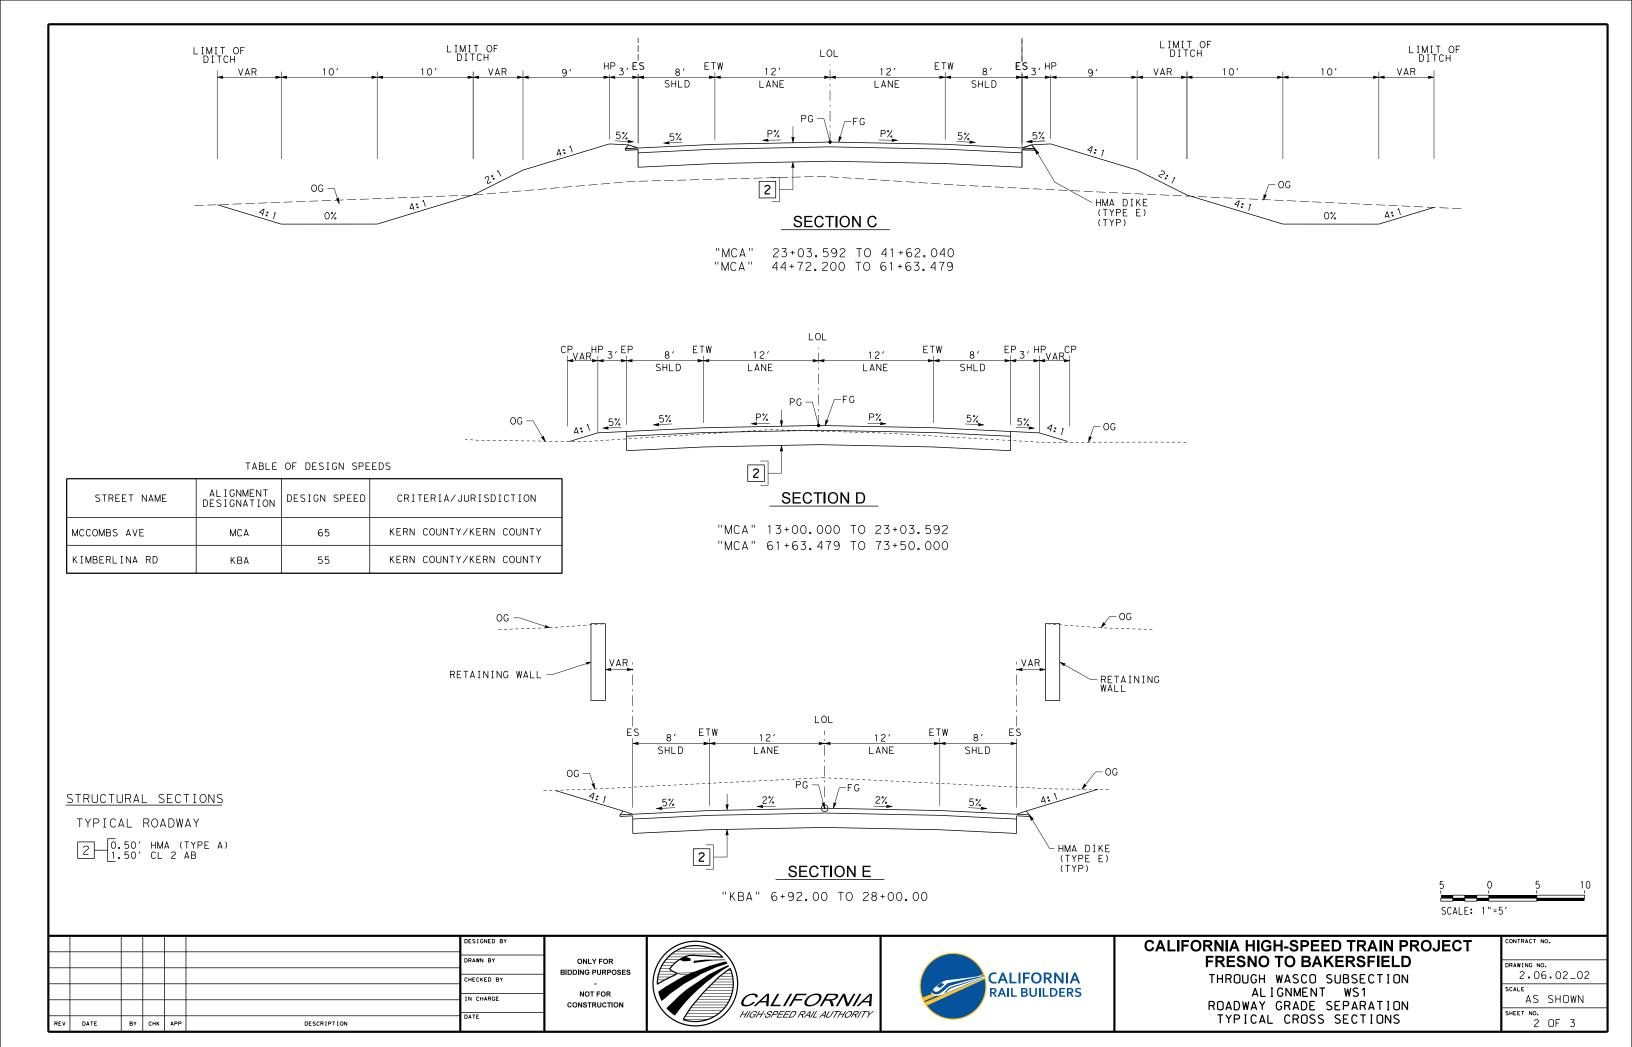




# CALIFORNIA HIGH-SPEED TRAIN PROJECT FRESNO TO BAKERSFIELD


ALLENSWORTH BYPASS SUBSECTION - ALIGNMENT A1 THROUGH WASCO SUBSECTION - ALIGNMENT WS1 ROADWAY/GRADE SEPARATION TYPICAL CROSS SECTIONS

CONTRACT NO.
DRAWING NO.
2.06.02_01
SCALE
AS SHOWN
SHEET NO.
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### TABLE OF DESIGN SPEEDS

STREET NAME	ALIGNMENT DESIGNATION	DESIGN SPEED	CRITERIA/JURISDICTION
6TH STREET	"6TH"	30	CITY OF WASCO/CITY OF WASCO
POSO AVE	"POS"	30	CITY OF WASCO/CITY OF WASCO
J.STREET (WASCO AVE)	"JST"	30	CITY OF WASCO/CITY OF WASCO



Per AASHTO GREEN BOOK 2011 SECTION 4.16.4 Tunnels the total clearance between walls should be a minimum of 30 feet. The minimum sidewalk should be 1.5 feet.

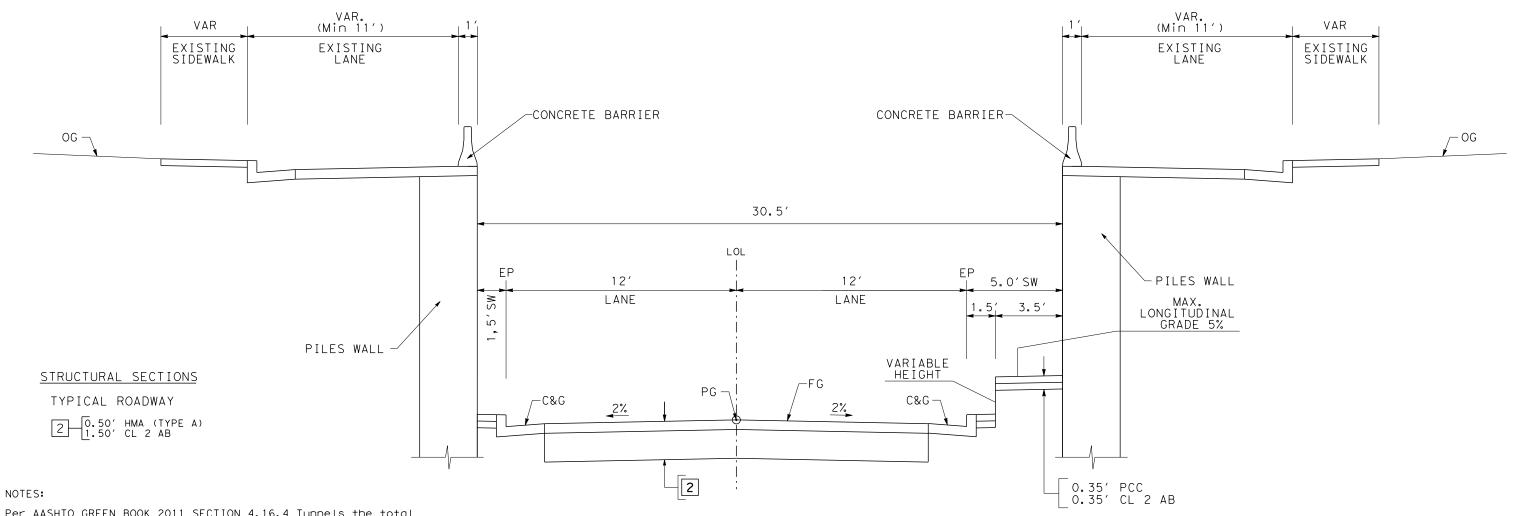Per 2010 ADA (American with Disabilities Act) Standards for Accessible Design Section 403.5.1 clear width minimum should be 3 feet providing passing spaces.


Per AASHTO GREEN BOOK 2011 SECTION 4.3 lanes 11 feet wide

Per Caltrans 309.1 Minimum horizontal Clearance 1.5 Ft.

Per 2010 ADA (American with Disabilities Act) Standards for Accessible Design Section 403.3, the running slope of walking surfaces shall not be steeper than 1:20 (5%).

# SECTION F

"6TH" 7+94.567 TO 19+35.00 "POS" 8+00.000 TO 14+53.00 "JST" 3+80.000 TO 15+30.00

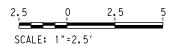

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BIDDING PURPOSES NOT FOR CONSTRUCTION





### **CALIFORNIA HIGH-SPEED TRAIN PROJECT** FRESNO TO BAKERSFIELD

THROUGH WASCO SUBSECTION ALIGNMENT WS1 ROADWAY GRADE SEPARATION TYPICAL CROSS SECTIONS

CONTRACT NO.
DRAWING NO. 2.06.02_03
SCALE AS SHOWN
SHEET NO. 3 OF 3

